
# ZEBULON CAMPGROUND

## ROGER HONBARRIER & RYAN RIMMELE

WAKE COUNTY, NORTH CAROLINA 30% CONSTRUCTION DOCUMENTS ISSUED: AUGUST 12, 2024

### SITE PLAN LEGEND

EXISTING	PROPOSED	
		- CENTERLINE/BASELINE CONSTRUCTION
P	P	- PROPERTY LINE
Ex R/W	R/W	- RIGHT OF WAY
		- EASEMENT
		- SWALE
— — ——1000— — —	————1000————	- CONTOUR
X" STM	st <u>X" STM</u> st	- STORM SEWER
X" SAN	sa <u>X" SAN</u> sa	- SANITARY SEWER
<i>X"_WTR</i> w	w X" WTR	- WATER LINE
———— WS —— ———	w	- WATER SERVICE
GG <i>X" GAS</i> GG		GAS LINE
——————————————————————————————————————	E	ELECTRIC LINE, UNDERGROUND
——————————————————————————————————————		TELEPHONE LINE, UNDERGROUND
—— —— FOC ——		FIBER OPTIC LINE, UNDERGROUND
CATV		CABLE LINE, UNDERGROUND
		CATCH BASIN, MANHOLE MANHOLE ADJUSTED TO GRADE
Typ	***	HYDRANT, HYDRANT ASSEMBLY
$WV\bowtie GV\bowtie$	WV ►	VALVE, WV=WATER VALVE GV=GAS VALVE
EGW		METER, E=ELECTRIC, G=GAS, W=WATER
		ELECTRIC CABINET, PULL BOX, PEDESTAL, MANHOLE
		TELEPHONE MANHOLE, UTILITY MARKER
$\varphi \phi \phi \phi \phi$	$ \leftarrow \stackrel{\sim}{\rho} \stackrel{\sim}{\rho} \stackrel{\sim}{\varrho} \stackrel{\sim}{\varrho}$	POWER POLE, TELEPHONE POLE, COMBINATION POLE, LIGHT POLE
IPFO	IPS ●	IRON PIN/PIPE FOUND, IRON PIN SET
MON	MON <b>■</b>	MONUMENT BOX
<del>-                                    </del>	<del></del>	SIGN
<i>MB</i>		MAILBOX
${\displaystyle \oint^{\sim}}\; \diamondsuit$		FLAG POLE, DECORATIVE/YARD LIGHT
		TREE, SHRUB LINE, TREE REMOVED, TREE LIMBED AND ROOT PRUNED
# 1000		BASEMENT ELEVATION

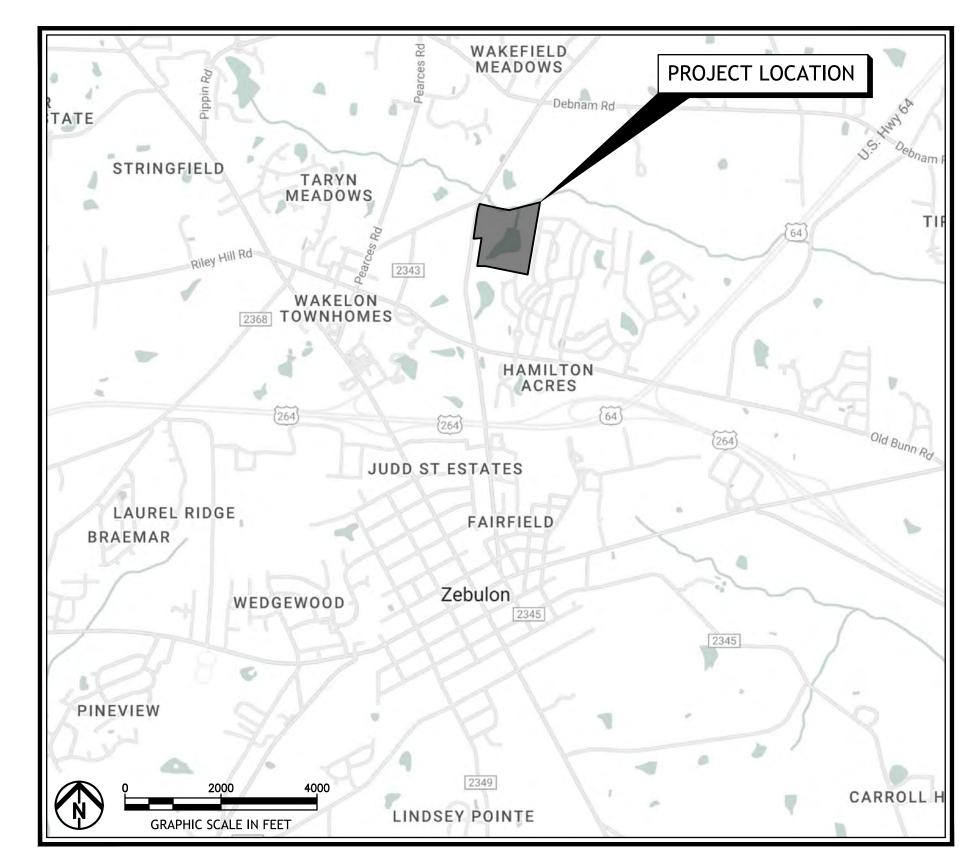

LOCATION MAP


PLANS PREPARED AND RECOMMENDED BY:



TITLE SHEET	
EXISTING CONDITIONS PLAN	V1.00
CODE REQUIREMENTS AND REGULATIONS	G1.00
SITE LAYOUT PLAN - OVERALL SITE	C1.00
SITE LAYOUT PLAN ENLARGEMENTS	C1.01-C1.04
CAMPSITE ENLARGEMENTS	C1.05-C1.06
SITE GRADING PLAN - OVERALL SITE	C2.00
SITE GRADING PLAN ENLARGEMENTS	C2.01-C2.04
SITE UTILITY PLAN - OVERALL SITE	C3.00
SITE UTILITY PLAN ENLARGEMENTS	C3.01-C3.04
SIGNAGE AND PAVEMENT MARKING PLAN	C4.00-C4.01
UTILITY ALLOCATION EXHIBIT	C5.00
SITE LANDSCAPE PLAN	L1.00
SITE LANDSCAPE PLAN ENLARGEMENT	L1.01
LANDSCAPE PLAN DETAILS	L1.02
LIGHTING PLAN	E1.00
LIGHTING PLAN DETAILS	E1.01
ARCHITECTURAL PLAN ENLARGEMENT	A1.00-A1.04

APPROVALS:	
TOWN MANAGER	DATE
PLANNING DIRECTOR	DATE

EDG PROJ. NUMBER 23-00285-020		SHEET
DRAWN BY CMR/SDK	TITLE 61155T	
CHECKED BY SDK	TITLE SHEET	T1.00
FILE NO. ZCOVR 23-00285-020.dwg		

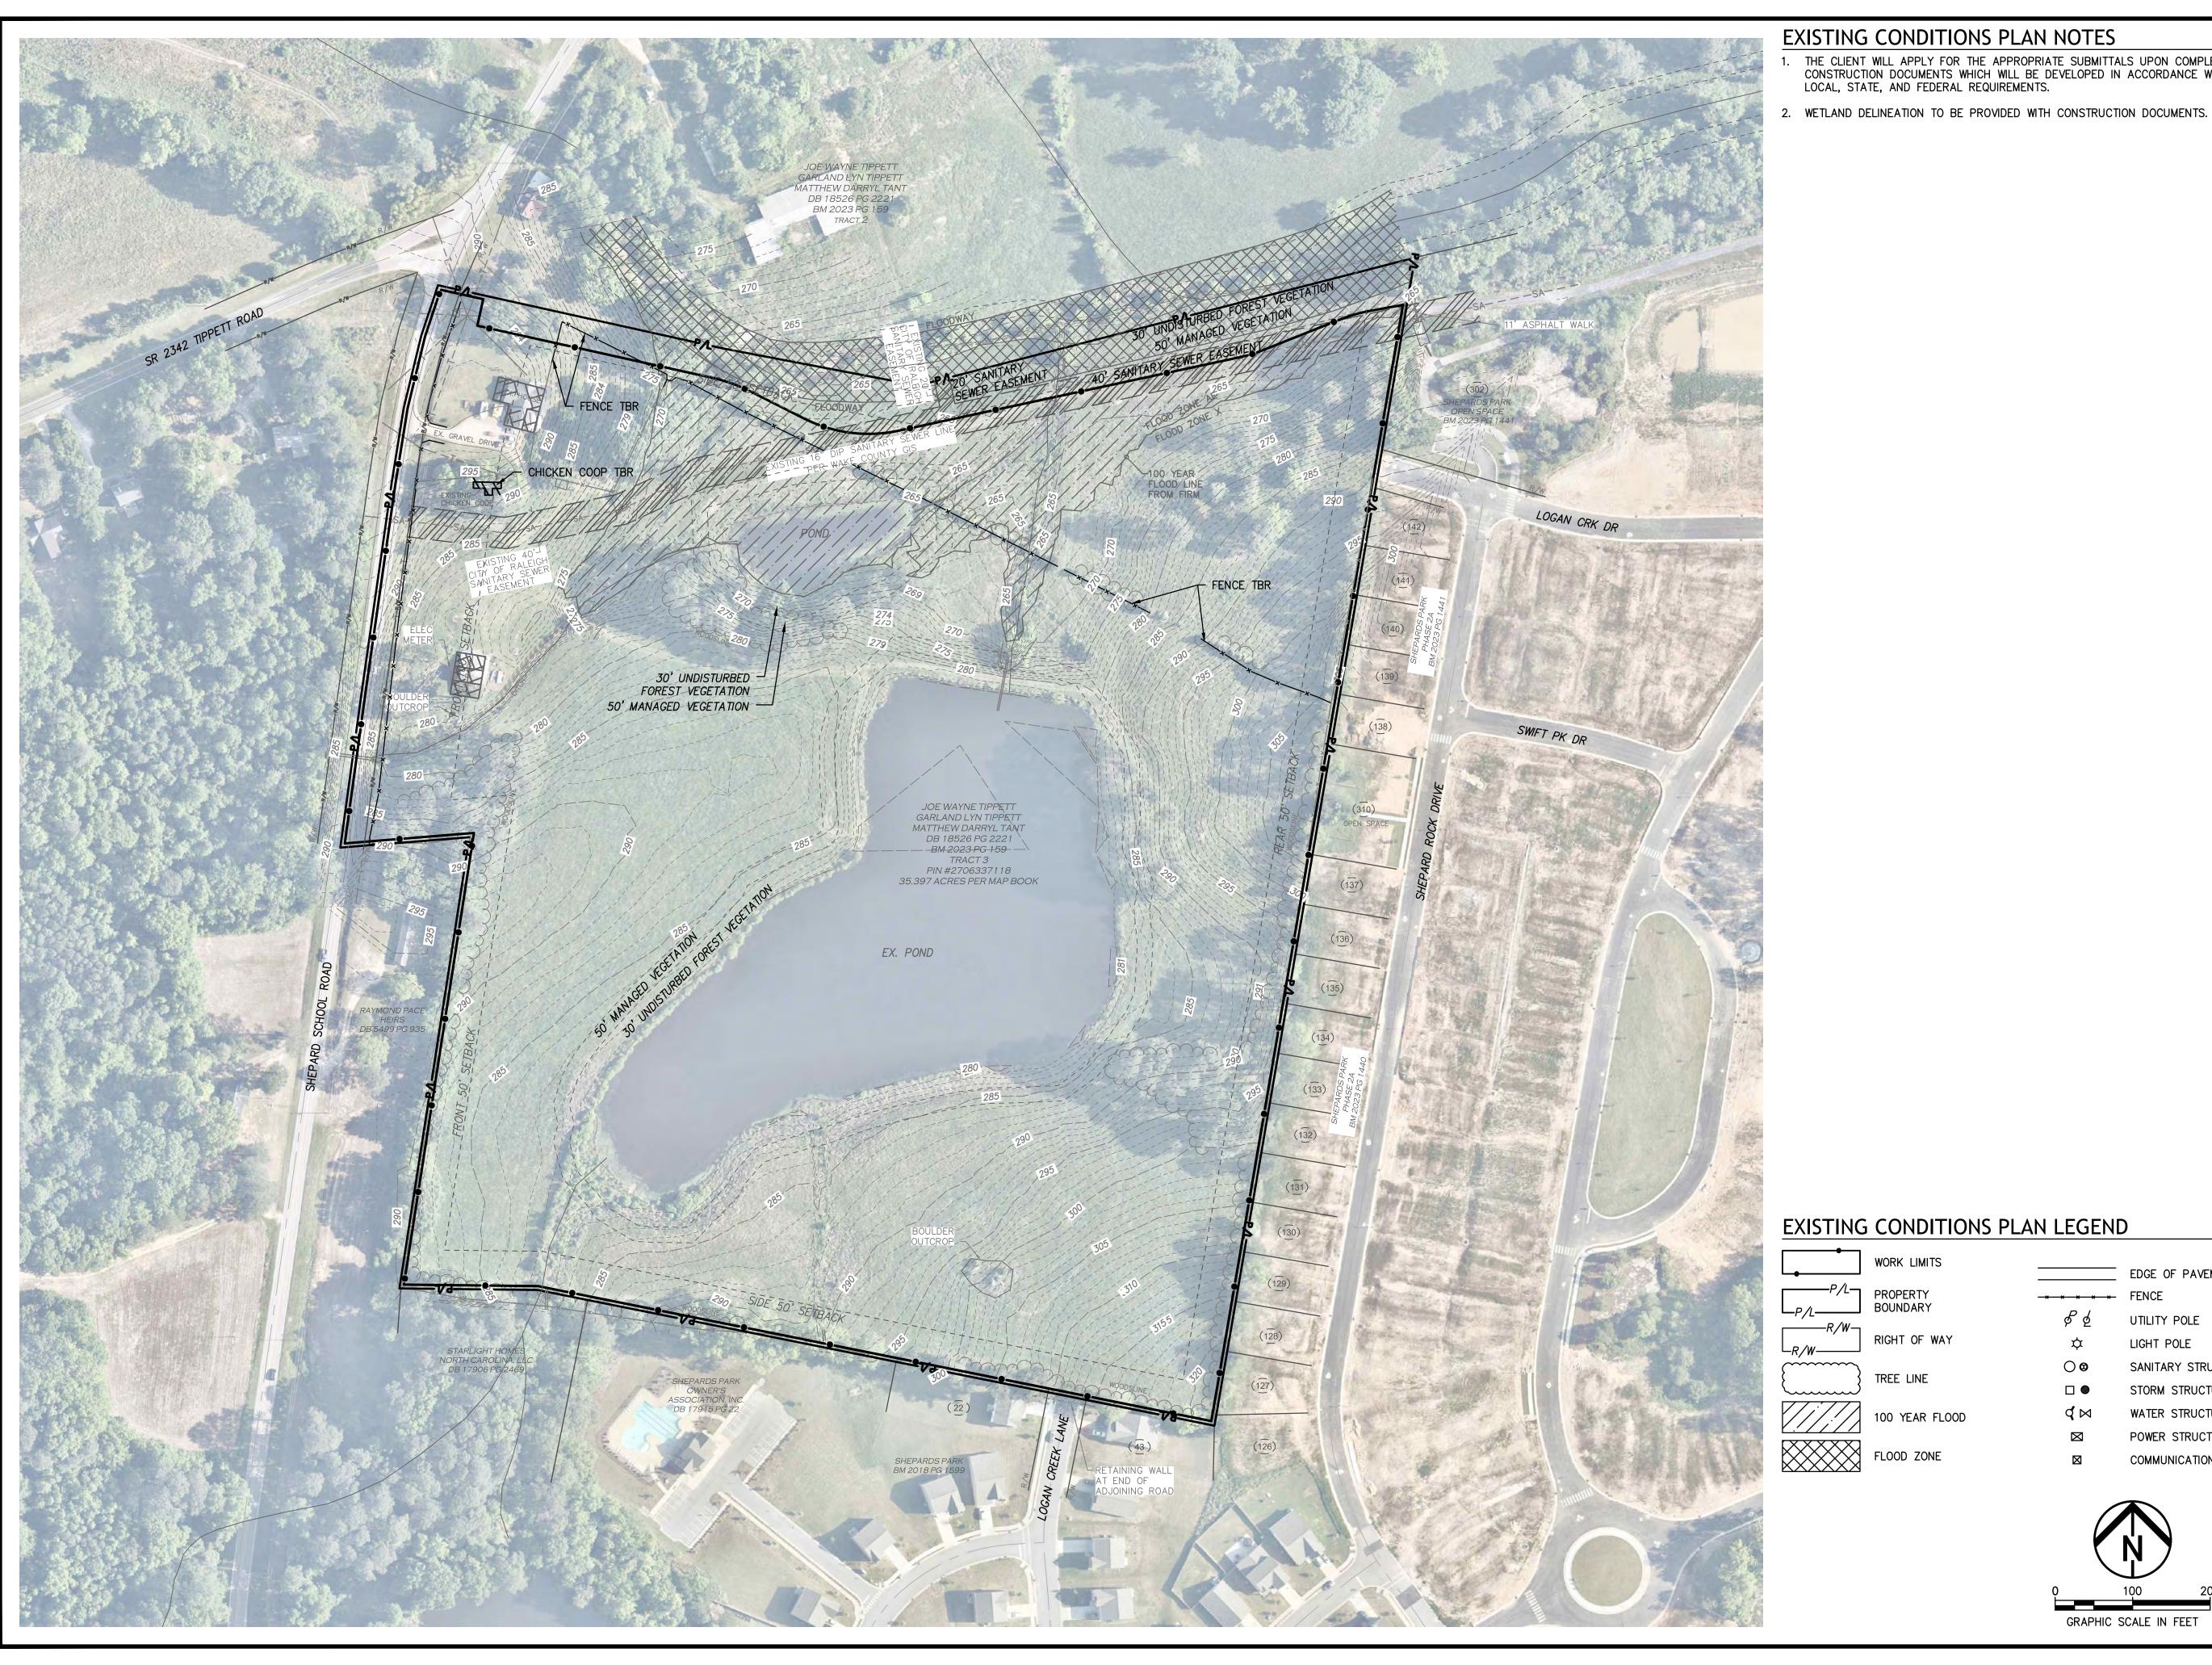

- 1. THE CLIENT WILL APPLY FOR THE APPROPRIATE SUBMITTALS UPON COMPLETION OF CONSTRUCTION DOCUMENTS WHICH WILL BE DEVELOPED IN ACCORDANCE WITH THE LOCAL, STATE, AND FEDERAL REQUIREMENTS.





CAMPGROUND HONBARRIER ZEBULON ROGER HONBA 30% CDS

		<u> , </u>	
	WORK LIMITS		EDGE OF PAVEMENT
P/L	PROPERTY BOUNDARY	<del></del>	FENCE
<u> </u>	DOUNDART	$\mathscr{S}$ &	UTILITY POLE
$L_{R/W}$	'   RIGHT OF WAY	$\Rightarrow$	LIGHT POLE
	TREE LINE	0 🛇	SANITARY STRUCTURE
			STORM STRUCTURE
	100 YEAR FLOOD	$\triangleleft \bowtie$	WATER STRUCTURE
		$\bowtie$	POWER STRUCTURE
	FLOOD ZONE	$\boxtimes$	COMMUNICATION STRUCTURE

	REV	ISIONS	
	<b>A</b>	DATE	DESCRIPTION
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	PROJ	IECT NO.:	23-00285-020
	DRAV	VN BY:	CMR/SDK
	CHEC	CKED BY:	SDK
RE	DATE	ISSUED:	2024/04/01
ΝĽ			

EXISTING CONDITIONS PLAN

V1.00

### RESTROOM AND SHOWER FACILITIES

### **Campground Requirements**

### Per Town of Zebulon, Unified Development Oridinance (UDO) 4.3.5.LL.8:

Each park shall provide the following bathroom facilities for every 8 campsites or fraction thereof:

Male bathrooms to include: 1 urinal, 1 toilet, 1 lavatory, 1 shower

Female bathooms to include: 2 toilets, 1 lavatory, 1 shower

### Per the NFPA 1194 Standard for Recreational Vehicles and Campgrounds, 7.5 and 7.6:

- 7.5.1.1 Toilets shall be provided at one or more locations in every recreational vehicle park and campground except at primitive and semi-primitive campgrounds.
- 7.5.1.2 Toilets shall be located within a 500 ft (152.4 m) radius from any recreational vehicle, recreational park trailer, and/or camping unit site not provided with an individual sewer connection.
- 7.6.1 In recreational vehicle parks and in semi-developed and developed campgrounds, a minimum of one toilet shall be provided for each sex up to the first 25 sites.
- 7.6.2 For each additional 25 sites not provided with sewer connections, an additional toilet for each sex shall be provided.
- 7.6.3 If water flush toilets are provided, an equal number of lavatories shall be provided up to six toilets.
- 7.6.3.1 One additional lavatory shall be provided for each two toilets when more than six toilets are required.
- 7.6.4 If separate facilities are provided for men and women, urinals shall be acceptable for no more than one-third of the toilets required in the men's facilities.

		Sewer Co	onnections		Tota	al Number	of Req'd Pl	lumbing Fix	ktures per	Code		Propose	ed Number	Plumbing	Fixtures
Type of Site	Site Count	at Ea	ch Site	Town	of Zebulo	n UDO 4.3	.5.LL.8	1	NFPA 1194	7.5 and 7.	6	(all rest	rooms to be	unisex, sin	gle use)
		Provided	Not Provided	Urinals	Toilets	Lavs	Showers	Urinals	Toilets	Lavs	Showers	Urinals	Toilets	Lavs	Showers
Back-In RV Campsites	32	32													
Pull-Thru RV Campsites	18	18		$\frown$	$\sim$	$\sim$	$\sim$								
Yurts*	8		8	7	19	13	13	0	6	6	0	0	8	Q	
Platform Tent Campsites*	11		11	<b>(</b>	13	13	13	Ň				O			1
Enlarged Glamping Sites*	3		3					<b>  /</b> <sub>1</sub> \							
Tent Campsites	13		13												
TOTAL	85	50	35												

<sup>\*</sup>Yurts and Platform Tents may or may not have integral restrooms.

### **Activity Center Requirements\***

PRIMARY	Area		Unisex Restrooms				
ACTIVITY CENTER	Alea	# of Occ.	Req'ts	Toilets	Lavs	Req'ts	Showers
CLUBHOUSE		Referenced Co	de: NC State Bu	uilding Code			
Offices	430	3.0					
Store	435	7.3			1	N/A	
Storage	175	0.6	1 per 75  1 per 75  6  1 per 75  1 per 75  1 per 75	2			0
Activity Room	975	48.8					
Patio	1000	50.0					
Sub-Total		109.6		2	1		
SWIMMING POOL			-				
Pool Area**	1500	100				4 200	
Spa Area	100	10	per 200 bathers	2	2	1 per 200 bathers	1
Deck Area	3450		20011010			22311010	
Sub-Total		110		2	2		1
TOTAL Fixtures				4	3		1

<sup>\*</sup>Clubhouse / Activity Center to be used by resort guests only.

\*\*\*Total fixtures assume single use, unisex restrooms.

### **Proposed Number of Plumbing Fixtures for Entire Site**

<u> </u>				
PROPOSED LOCATIONS	ı			
PROPOSED LOCATIONS	Toilets	Lavs	Showers	Laundry
Clubhouse / Activity Ctr.	4	4	2	0
Pool (rinse shower)	0	0	2	0
SE Corner	4	4	2	2 units
NE Corner	4	4	2	0
Total	12	12	8	2 Units

### BENCHMARK REQUIREMENTS FOR SITE DEVELOPMENT

Site Requirements	NFPA 1194	Proposed Campground	Comments
•			Alt. Routes provided within
			Campground. Site limitaions to
Emergency Access	Х		provied 2 ways to enter and exit.
Separate access to each camp			
site	Х	X	
Each Site is Identifiable	Х	Х	
Min 1,500 SF per camp site		Х	
Each Stand Min 8'-0" Wide	Х	Х	
Min 15'-0" distance between			
Recreational Vehicles or			
protable camping units	Х	Х	X
Min 10'-0" distance between			
portable camping units	Х	X	X
Min 15'-0" from any building,			
public roadway, street, alley			
and or any right-of-way for			
vehicular traffic		Х	
Dump Station	Х		Not required- Full Hook Ups Provided
Gray Water Recycling	Х	Х	Required for Primitive Campsites

### OPEN SPACE CALCULATIONS

Open Space			
Total Property Area (Not Including Lake)	1288748	SF	29.6 AC
Lake Area	255130	SF	5.9 AC
Open Space Set-Aside Required (5%)	5%	%	5% %
Total	77194	SF	1.78 AC

	Total	529843	SE	12 50	AC
Passive	ALL Passive Open Space (not including Camping Sites/Roads/Lakes/Etc.	5268181	SF	12.10	AC
Active	Playground	3025	SF	0.10	AC
Active	Swimming and Lodge	9420	SF	0.30	AC

### PARKING REQUIREMENTS

PARKING REQUIREMENTS		Proposed #	Location	Number of Parking Spaces	
Area Type	Town of Zebulon Requirements	of Units	Location	Required	Proposed
Recreational Vehicle Park		50	RV Campsites	13	50
	1 per employee on largest shift,		Maintenance	2	2
	and .25 per every RV space*		Clubhouse / Activity Center	4	16
	and .25 per every kv space		SW Parking Area		8
			SE Shelter / Bathhouse		14
Campgrounds		2	NW Yurts	4	4
		6	SE Yurts	12	25
	1+1 per every camping space	3	E Enlarged Glamping Sites	6	6
		11	E Platform Tents	22	22
		13	NE Tent Campsites & Bathhouse	26	27
Trailhead	1/50 units	85	NW Corner	2	2
Commercial Recreation, Indoor	1/200 SF		Not Used**		•
Commercial Recreation, Outdoor	1/1,000 SF (including building SF)		Not Used**		
Community Center	1/300 SF		Not Used**		
Convenience Store	1/200 SF		Not Used**		
Indoor Private Recreation	1/200 SF		Not Used**		
Office, Sales	1/200 SF for public areas, 1/600 for non-public areas		Not Used**		
TOTAL				91	176

<sup>\*</sup>Estimated number of employees at peak season: 6. Up to 2 parking spaces available at each RV campsite depending on length of RV / trailer.

\*\*Requirements included for reference only. Clubbouse and Activity Areas to be used by resort quests only.





# | ZEBULON CAMPGROUND | ROGER HONBARRIER & RYAN RIMMELE

30% CDS

ATE: \_\_

REVISIONS

DATE DESCRIPTION

1 08-12-2024 REVIEW RESUBMITTAL

PROJECT NO.: 23-00285-020

DRAWN BY: CMR/SDK

CHECKED BY: SDK

DATE ISSUED: 2024/04/01

CODE REQUIREMENTS
AND REGULATIONS

G1.00

 $<sup>**</sup>Number\ of\ req'd\ to ilets\ and\ lavatories\ could\ be\ reduced\ in\ half\ if\ bather\ load\ is\ under\ 100.$ 

<sup>\*\*</sup>Requirements included for reference only. Clubhouse and Activity Areas to be used by resort guests only.



### SITE LAYOUT PLAN - OVERALL SITE NOTES

- EXISTING CONDITIONS ARE BASED ON SURVEY PROVIDED BY THE CLIENT. ALL UNDERGROUND STRUCTURES AND UTILITIES HAVE BEEN SHOWN TO A REASONABLE DEGREE OF ACCURACY. IT SHALL BE THE CONTRACTOR'S RESPONSIBILITY TO VERIFY EXISTING CONDITIONS AND REPORT ANY DISCREPANCIES TO THE OWNER'S REPRESENTATIVE PRIOR TO CONSTRUCTION ACTIVITY.
- 2. REFER TO ARCHITECTURAL FOR COORDINATION OF BUILDING LIMITS, EXTERIOR COLUMNS, FROST SLAB AND ETC. CONSTRUCTION CONTRACTOR SHALL FIELD VERIFY THESE ELEMENTS AND REPORT ANY DISCREPANCIES TO THE ARCHITECT.
- 3. UNLESS OTHERWISE SHOWN, ALL COORDINATE POINTS ARE GIVEN FROM THE CENTER POINT OF SITE ELEMENTS AND STRUCTURES. ALL DIMENSIONS ARE FROM FACE OF
- 4. DO NOT SCALE FROM THE DRAWING. ALL WRITTEN DIMENSIONS SHALL GOVERN. ALL ANGLES ARE 90 DEGREES UNLESS NOTED OTHERWISE.
- 5. CONTRACTOR IS RESPONSIBLE TO MAINTAIN EXISTING SITE CONTROLS AND SET NEW
- 6. PRECISE LAYOUT SHALL BE DETERMINED BY A REGISTERED PROFESSIONAL SURVEYOR PRIOR TO CONSTRUCTION. CONTRACTOR SHALL FIELD VERIFY ALL DIMENSIONS AND REPORT ANY DISCREPANCIES TO THE ARCHITECT.
- 7. CONSTRUCTION NOTES AND TYPICALS MAY APPEAR ONLY ONCE ON THE DRAWING BUT APPLY TO ALL SIMILAR CONDITIONS.
- 8. CONTRACTOR SHALL REPAIR OR REPLACE ALL PAVEMENT, UTILITIES AND LAWN/LANDSCAPE AREAS THAT ARE TO REMAIN THAT ARE DAMAGED AS A RESULT OF CONSTRUCTION ACTIVITIES AT NO ADDITIONAL COST TO THE OWNER.
- 9. REFER TO SITE UTILITY PLAN FOR UTILITY LAYOUT INFORMATION, PAVEMENT UNDERDRAINS AND OTHER STORM SEWER REQUIREMENTS.
- 10. REFER TO SHEET G1.00 FOR SITE PARKING REQUIREMENTS MATRIX.
- 11. THE CLIENT WILL APPLY FOR THE APPROPRIATE SUBMITTALS UPON COMPLETION OF CONSTRUCTION DOCUMENTS WHICH WILL BE DEVELOPED IN ACCORDANCE WITH THE LOCAL, STATE, AND FEDERAL REQUIREMENTS.

### CAMPSITE LEGEND

- A PREMIUM RV BACK-IN CAMPSITE (5)
- B PREMIUM RV BACK-IN REVERSE CAMPSITE (27)
- C PREMIUM RV PULL-THROUGH CAMPSITE (8)
- D PREMIUM RV PULL-THROUGH REVERSE CAMPSITE (10)
- E YURT CAMPSITE ENLARGED PLAN (8)
- F GLAMPING ENLARGED PLAN (11)
- F\* GLAMPING MODIFIED ENLARGED PLAN (3)
- G PLATFORM TENT ENLARGED PLAN (13)

## SITE LAYOUT PLAN LEGEND

\_\_\_\_EX R/W\_ STANDARD DUTY ASPHALT STANDARD DUTY

PROPERTY BOUNDARY

FLAG POLE

RIGHT OF WAY

GRAPHIC SCALE IN FEET

AMPGROUND HONB, **Z**O EBUL

**Environmental** 

**Design** Group

AKRON / CLEVELAND / COLUMBUS

HQ 450 GRANT ST., AKRON, OH 44311 P 330.375.1390 / TF 800.835.1390 W ENVDESIGNGROUP.COM

Know what's below.
Call before you dig.

**REVISIONS** 

DATE ISSUED:

30% CDS


# DATE DESCRIPTION 08-12-2024 REVIEW RESUBMITTAL


PROJECT NO.: 23-00285-020 CMR/SDK DRAWN BY: **CHECKED BY:** 


SITE LAYOUT PLAN -**OVERALL SITE** 


2024/04/01

C1.00

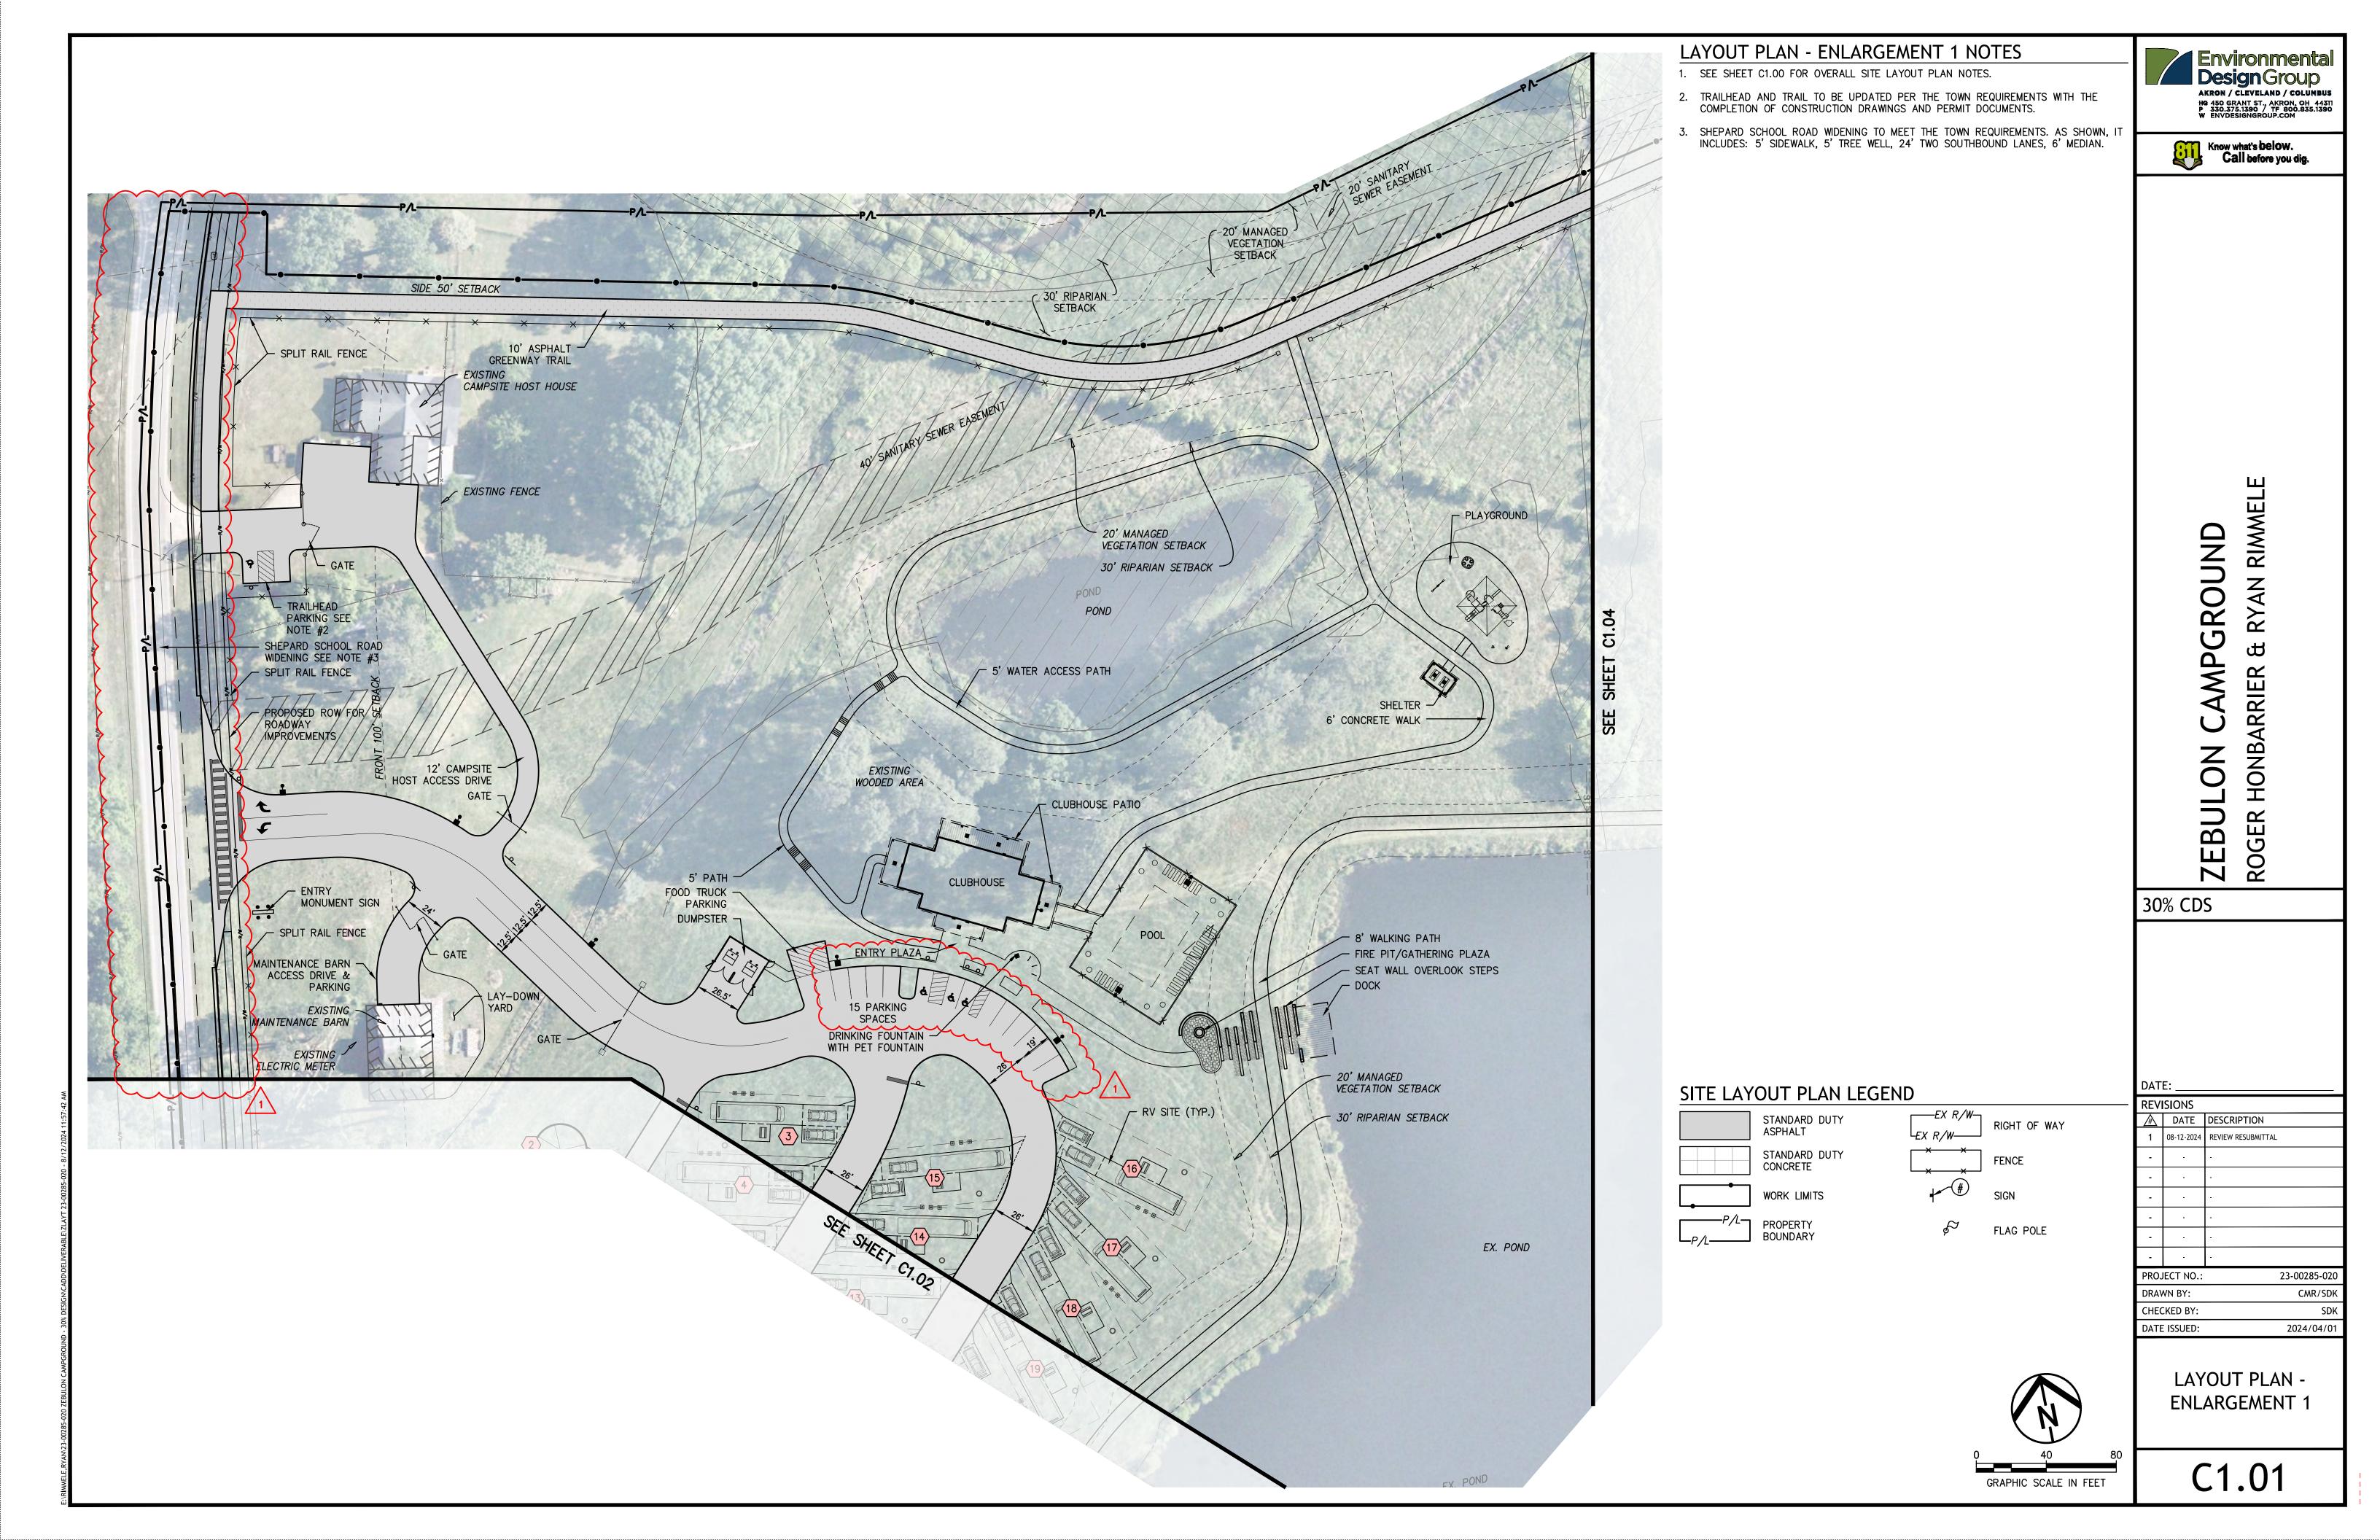

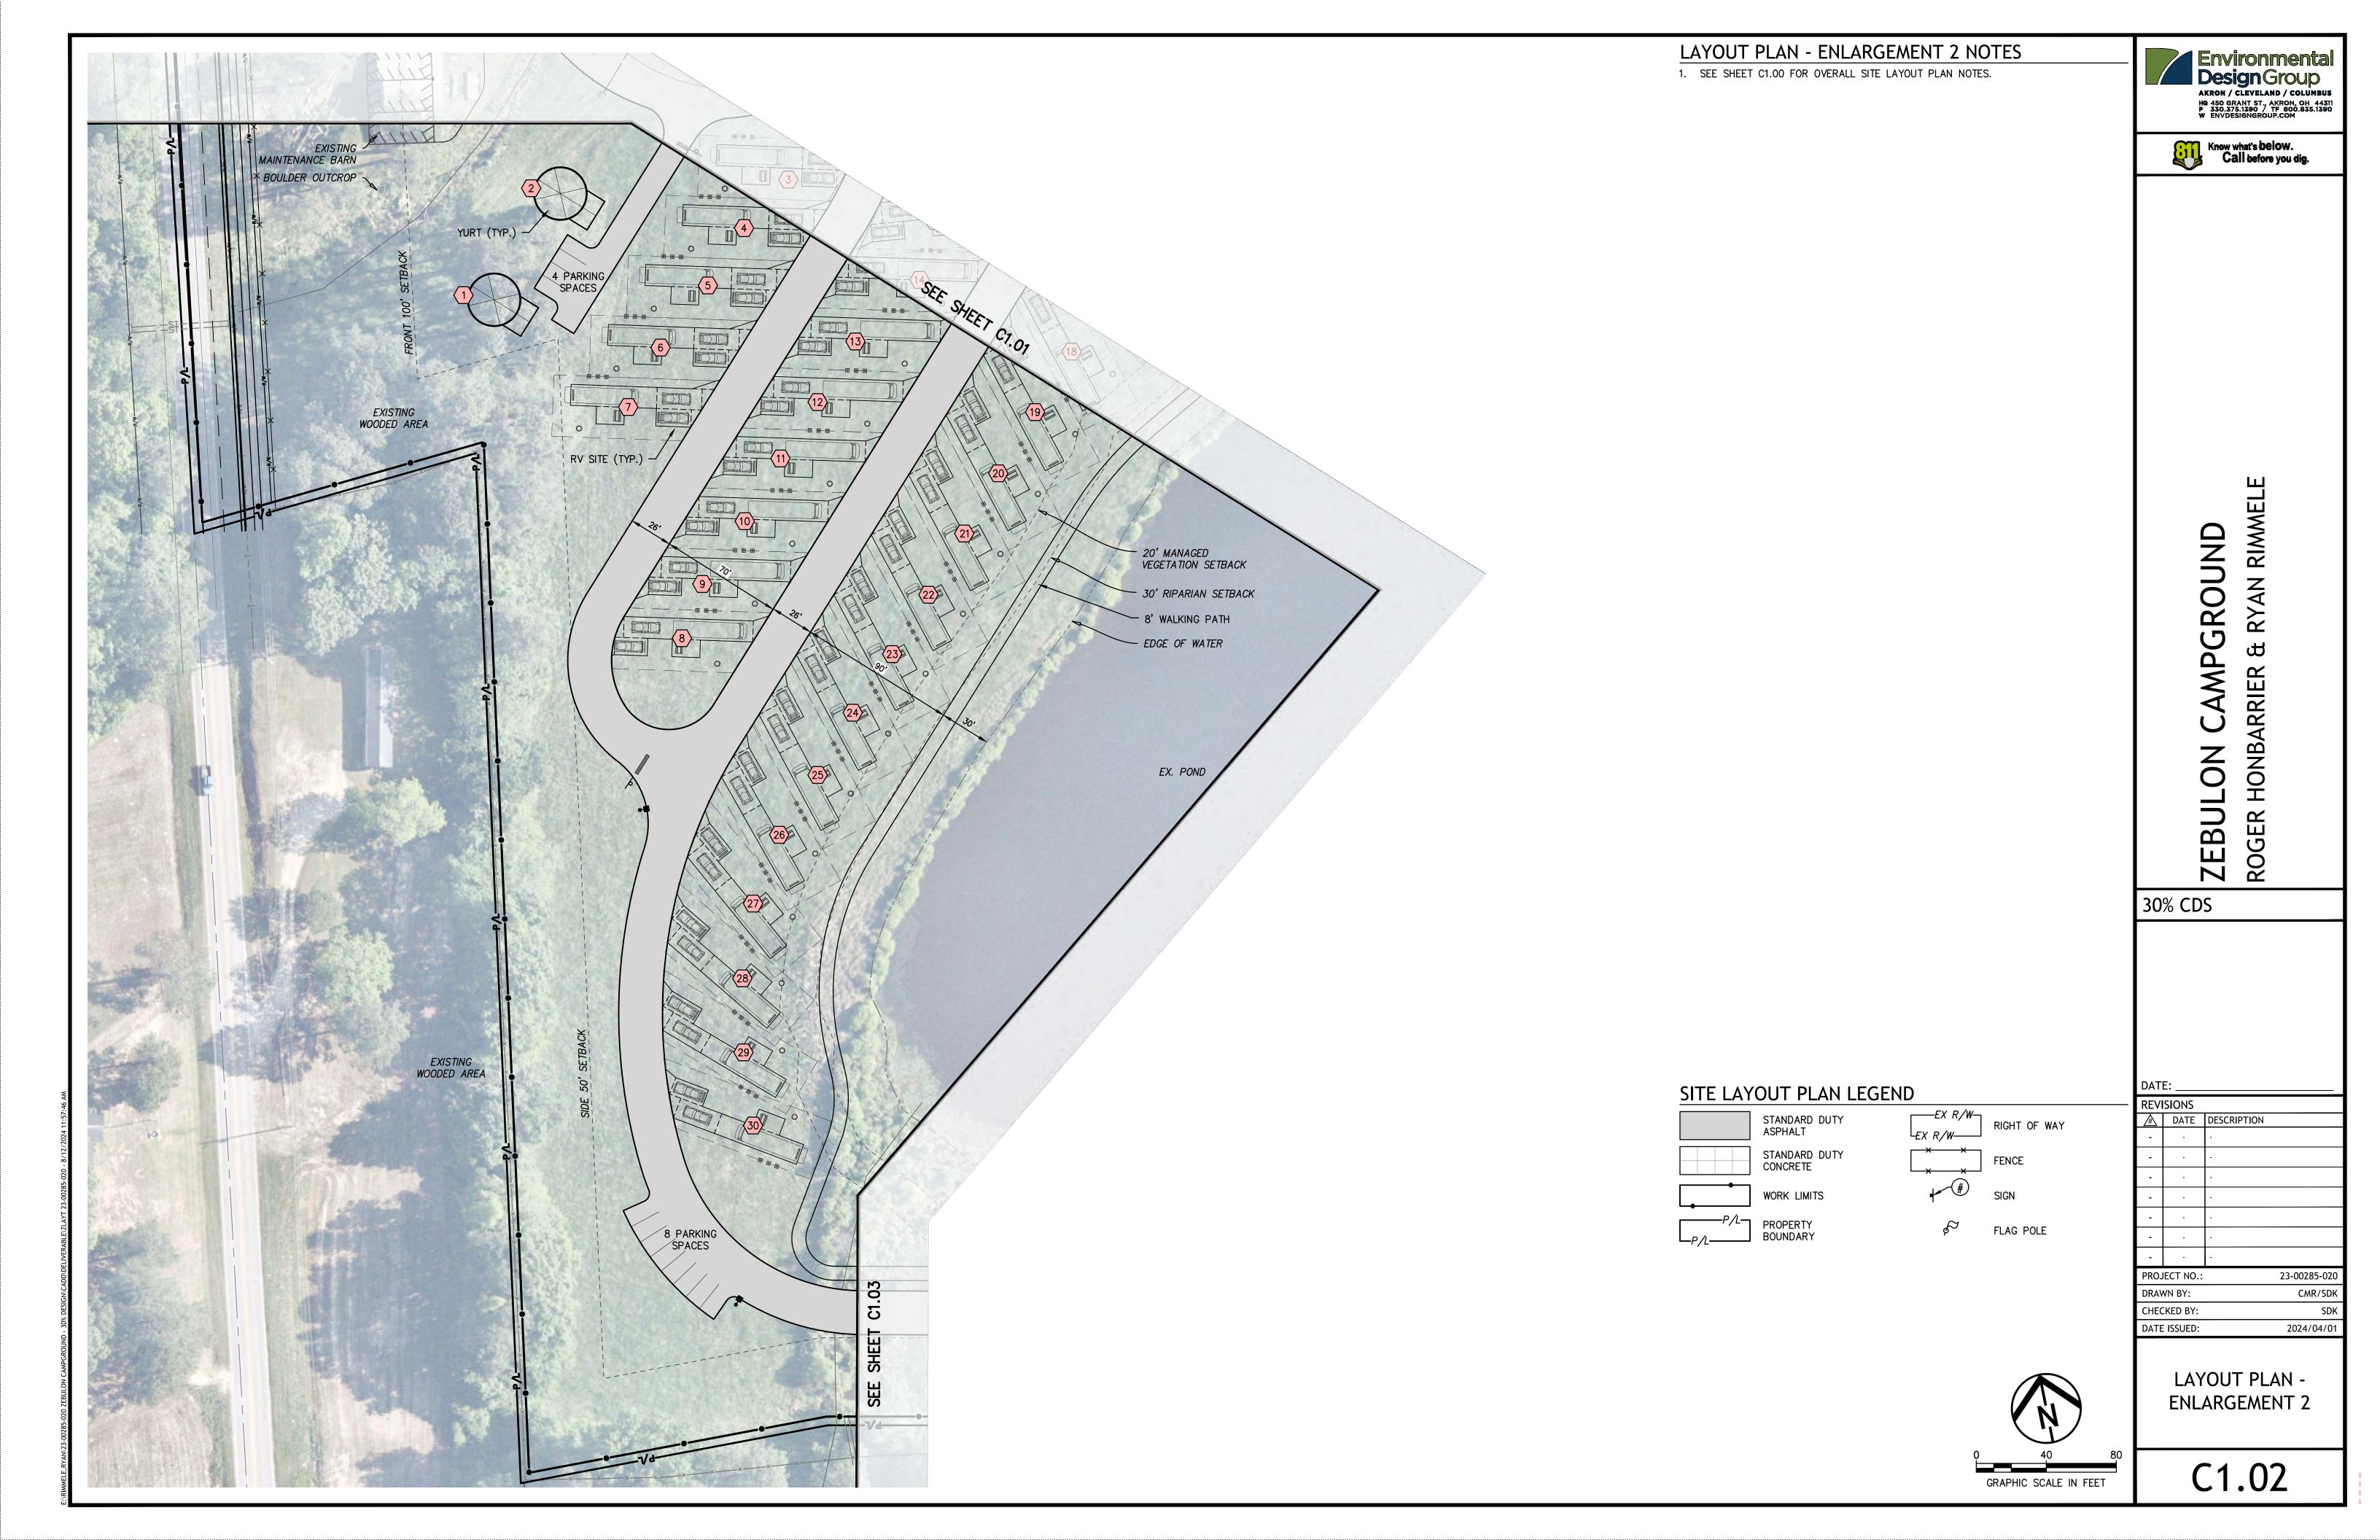

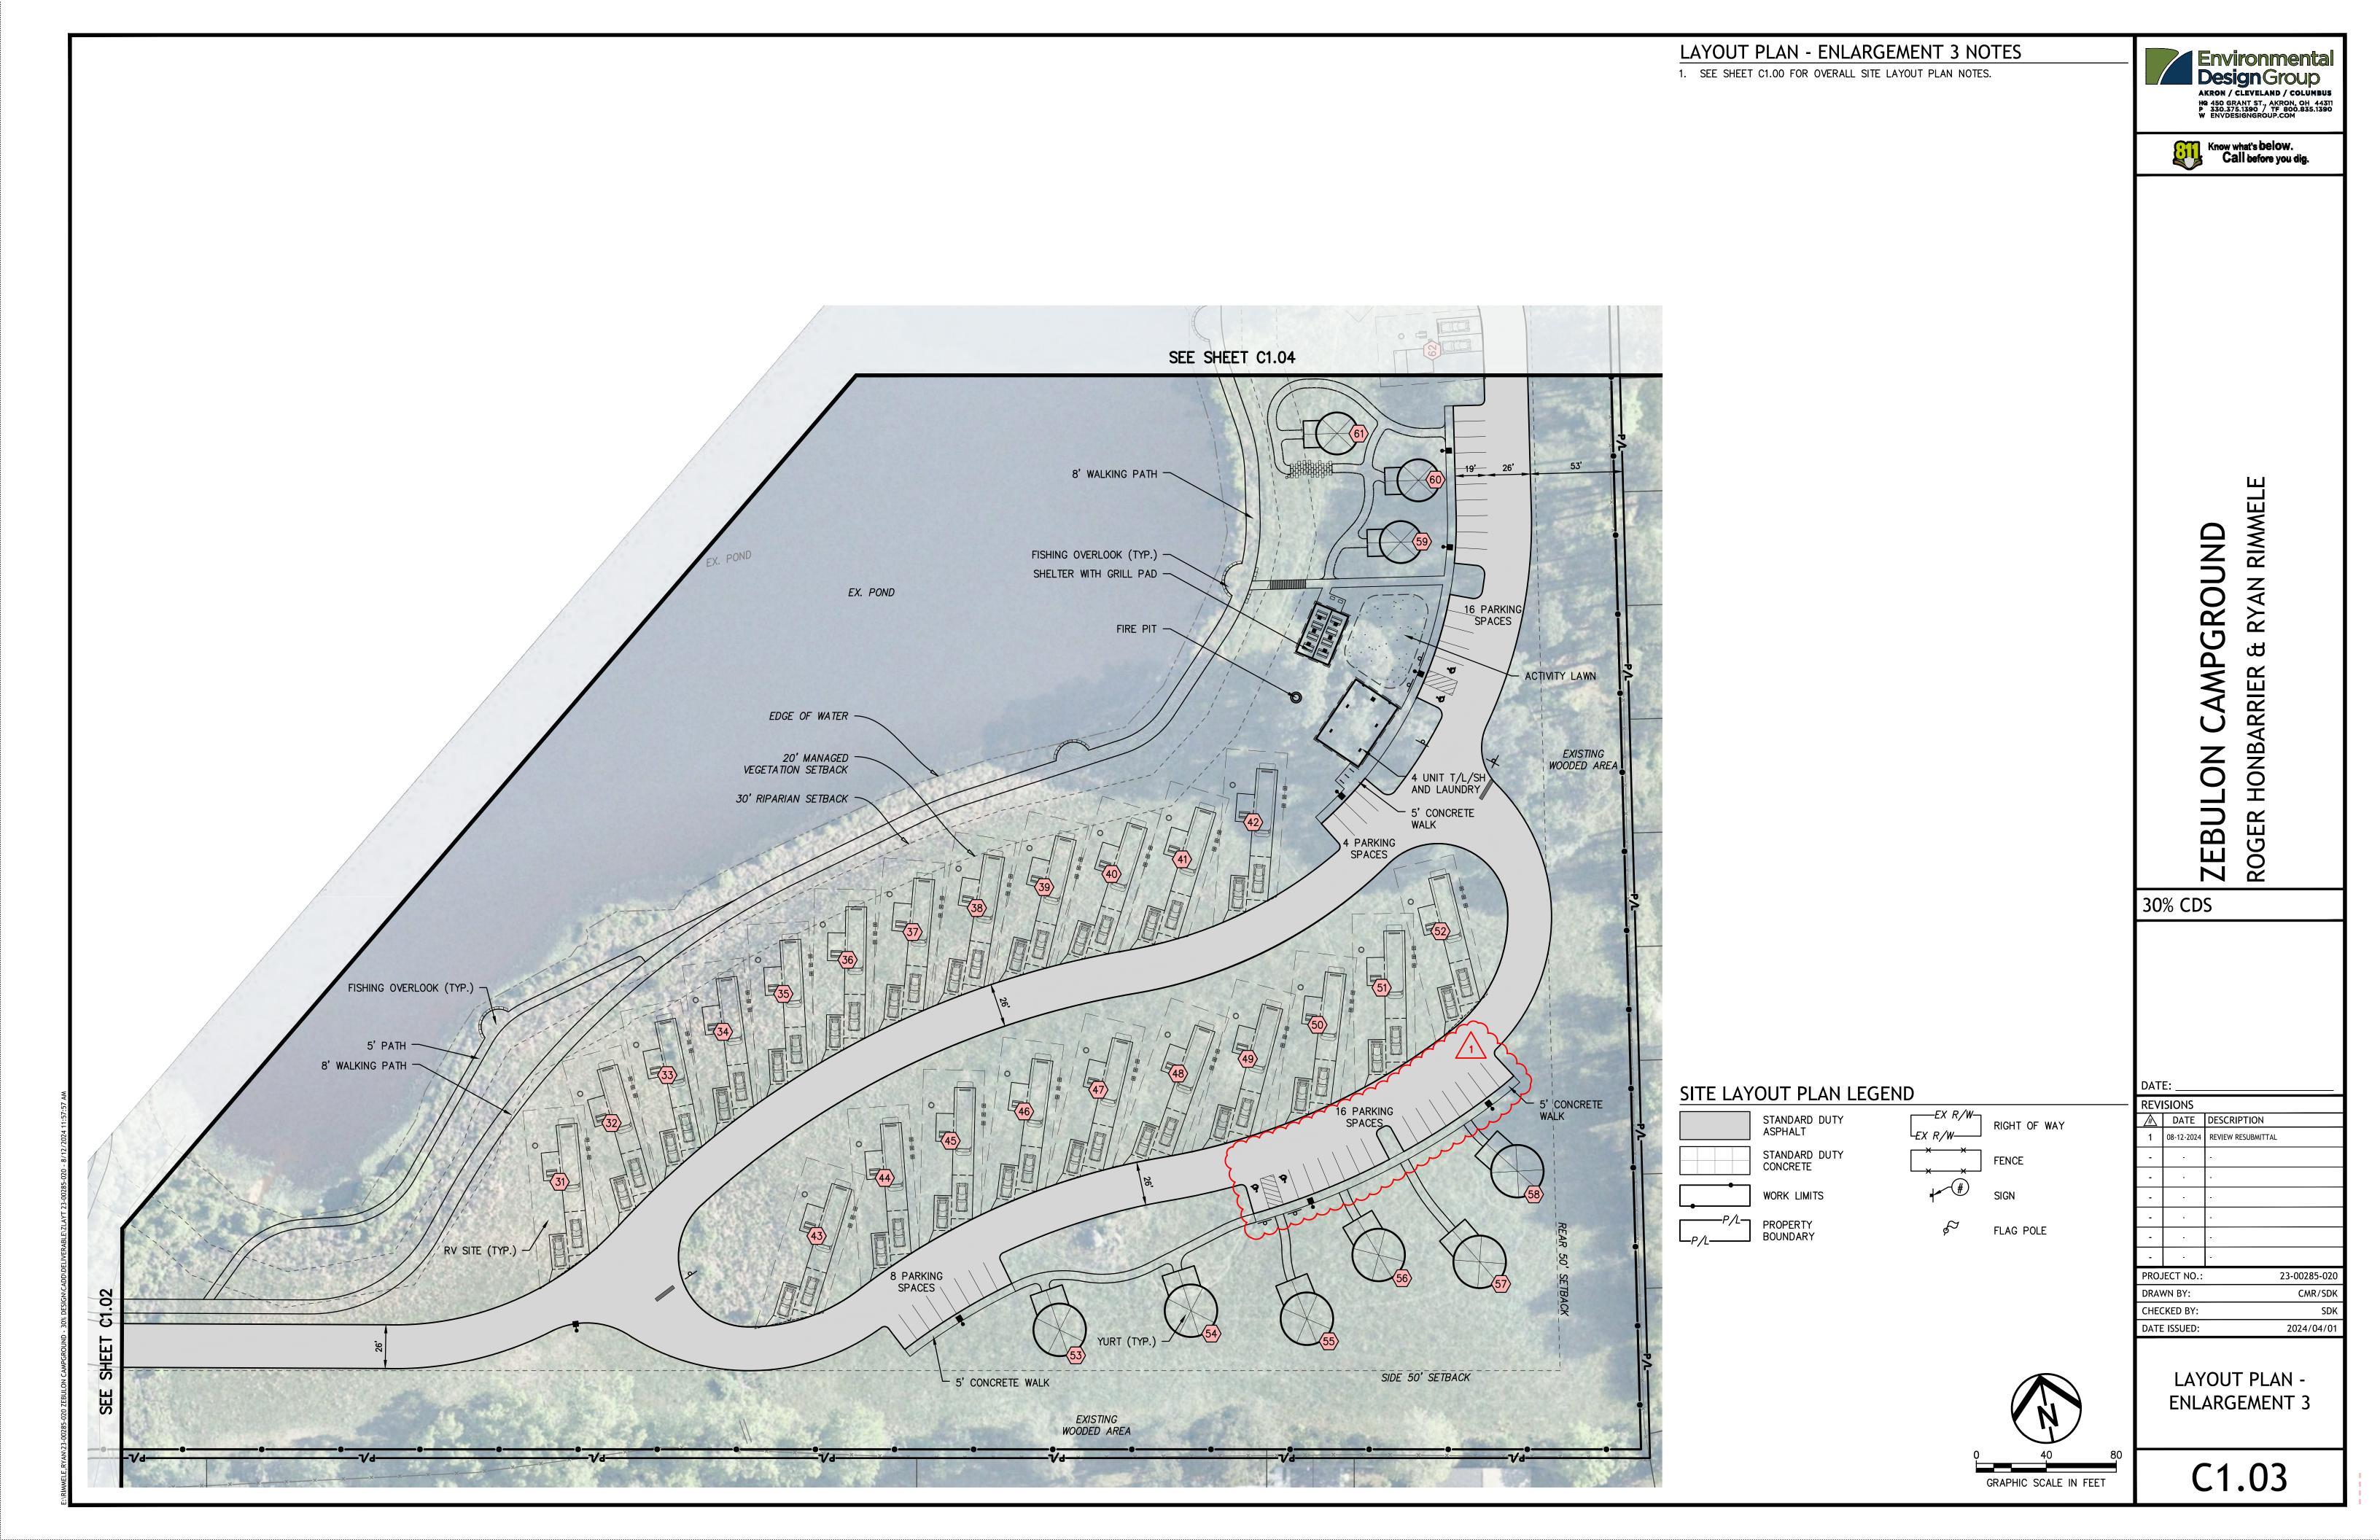

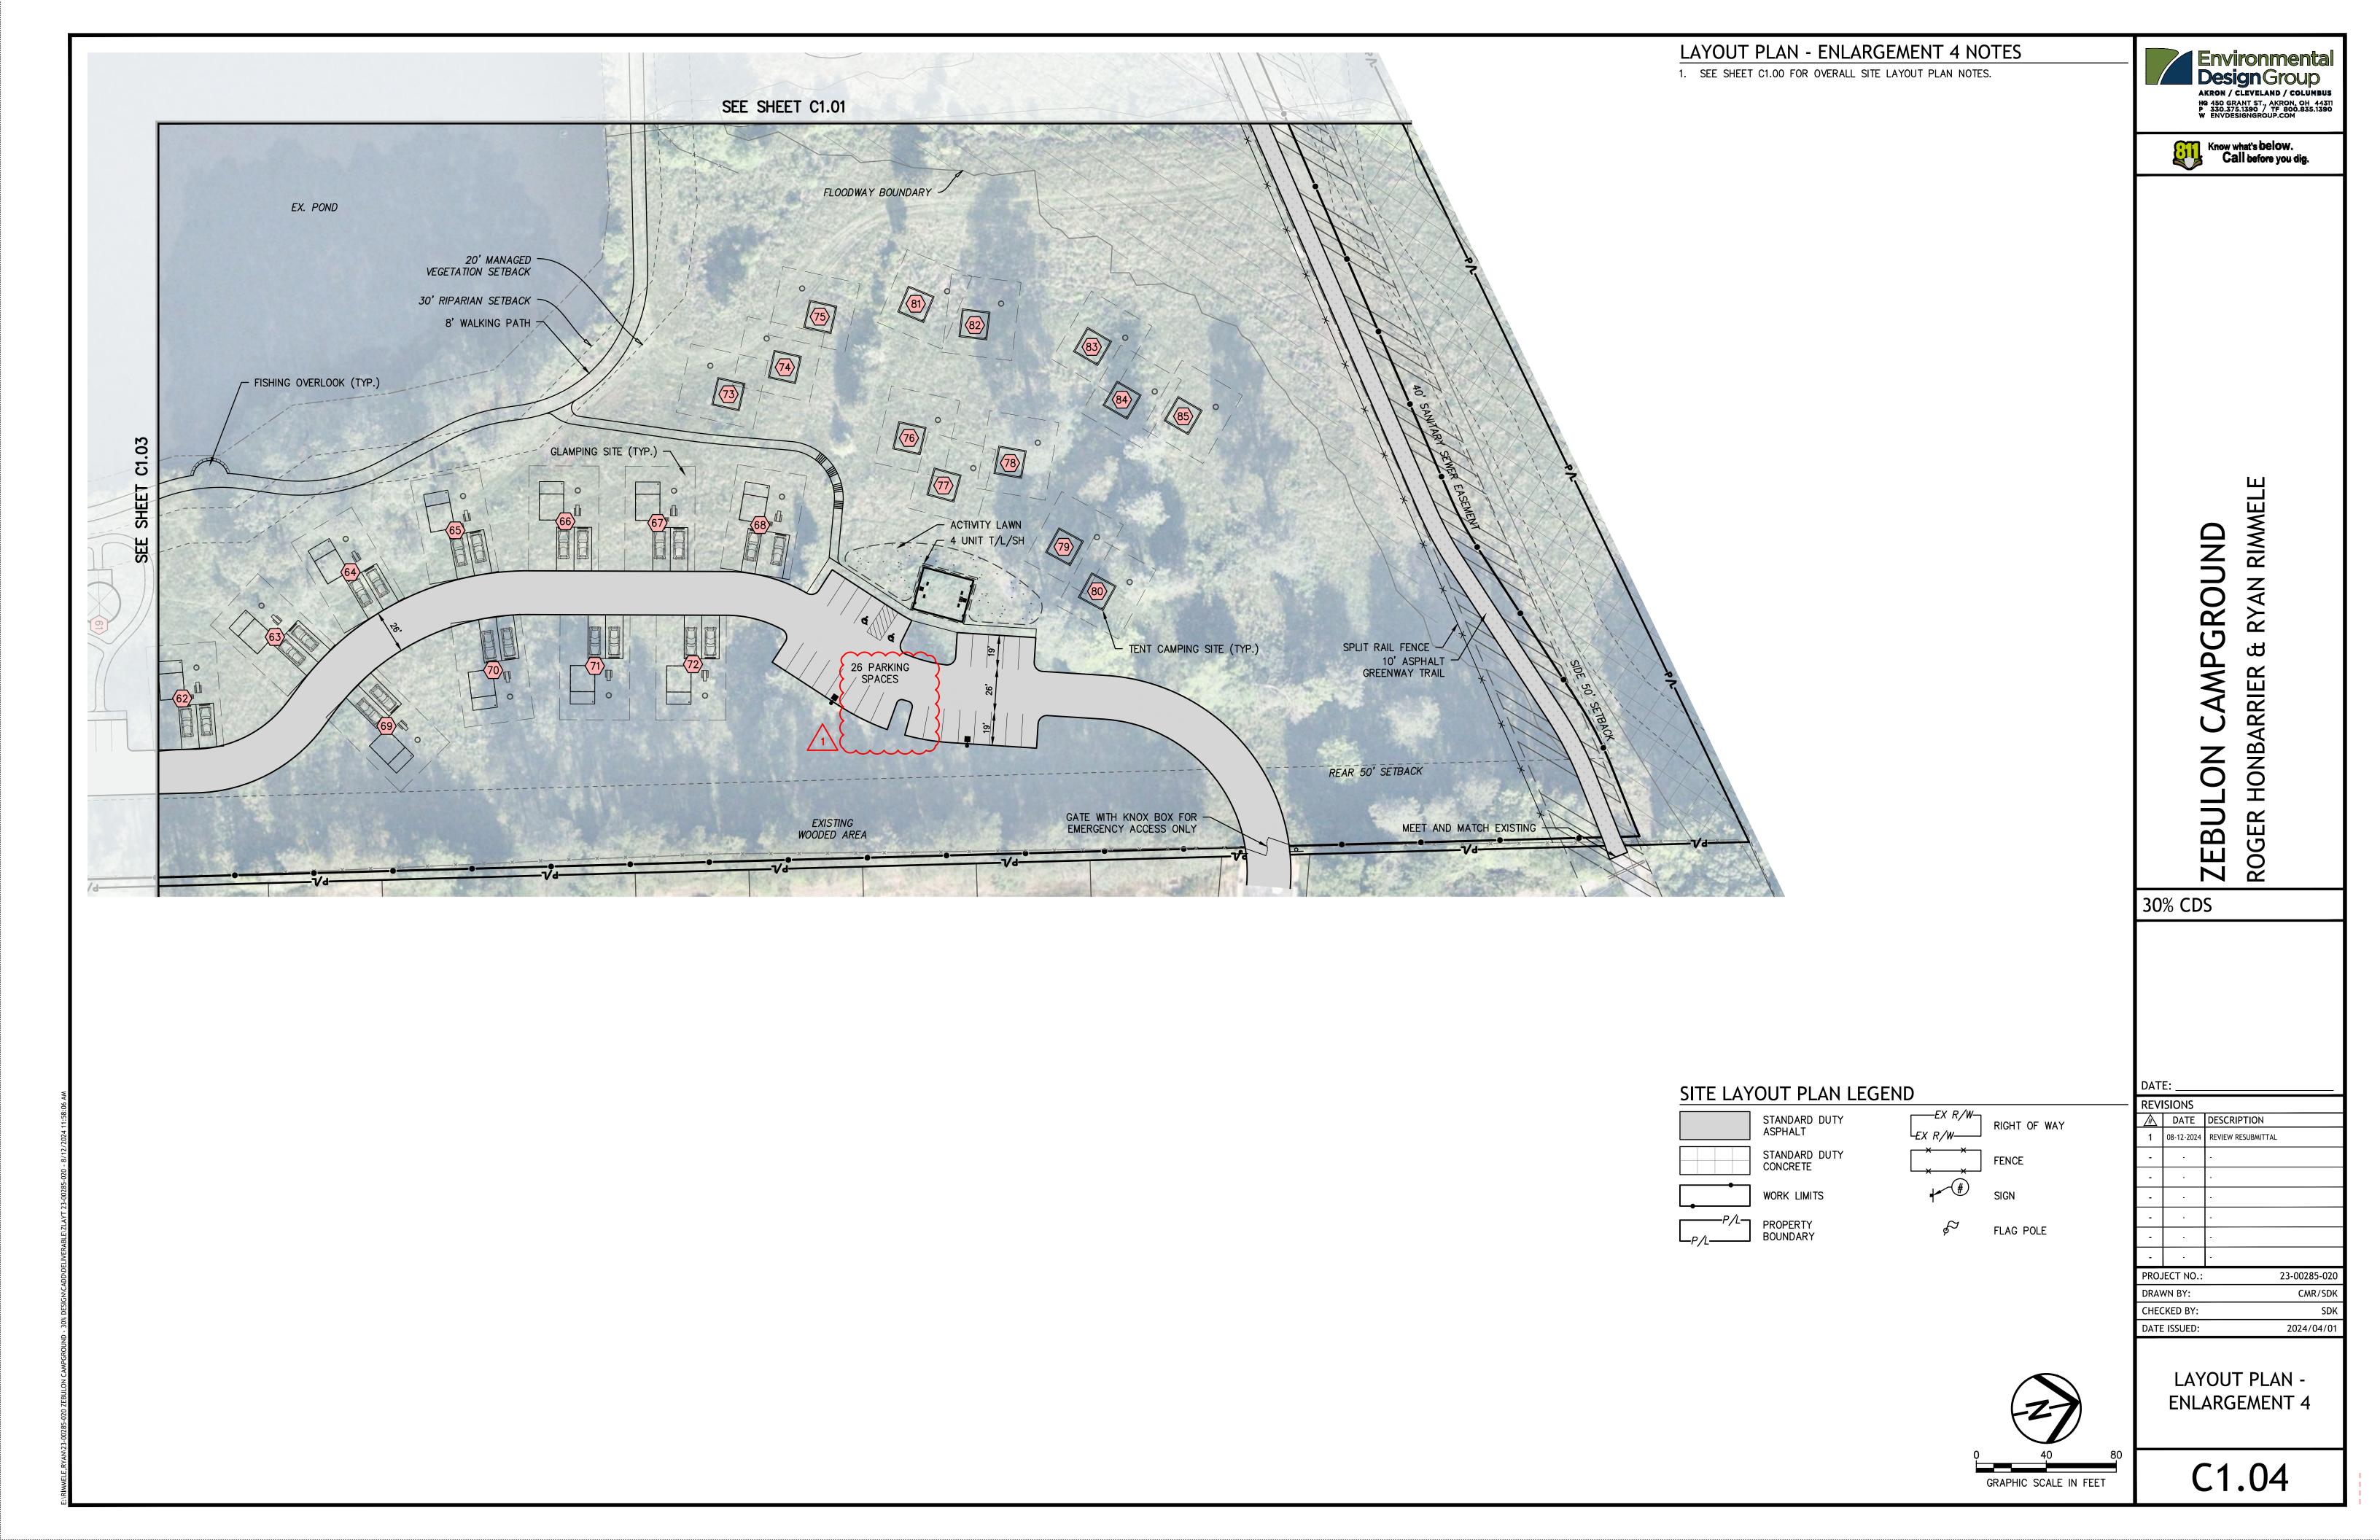

30% CDS

PROJECT NO.: 23-00285-020 CMR/SDK

DRAWN BY: CHECKED BY: DATE ISSUED: 2024/04/01


> CAMPSITE **ENLARGEMENTS**

> > C1.05

75'-0" PARKING SPACE, SURFACE TO BE DETERMINED (CONCRETE/GRAVEL) PICNIC TABLE 8' PARKING BUMPER BLOCK CONCRETE RV PAD (50'-0" X 12'-0") 8' PARKING BUMPER BLOCK ELECTRIC HOOKUP -WATER ¬ SANITARY LOCATION OF CONCRETE PARKING SPACE HOOKUP COORDINATE AT DRIVE (12'-0" x 25'-0") HOOKUP 🛨 102'-0"


### A PREMIUM RV BACK-IN CAMPSITE ENLARGED PLAN

(MINIMUM AREA: 1,500 SF PER CAMPSITE, AS SHOWN: 2,965 SF PER CAMPSITE)

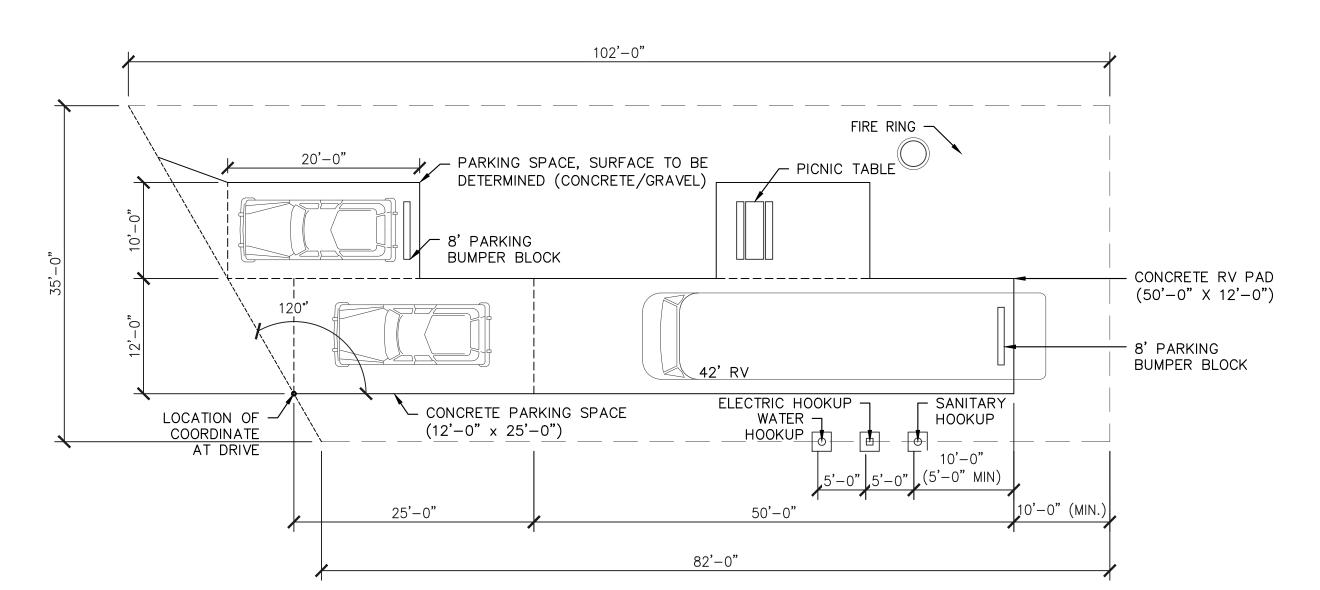


### **B PREMIUM RV BACK-IN REVERSE CAMPSITE ENLARGED PLAN**

(MINIMUM AREA: 1,500 SF PER CAMPSITE, AS SHOWN: 3,230 SF PER CAMPSITE)

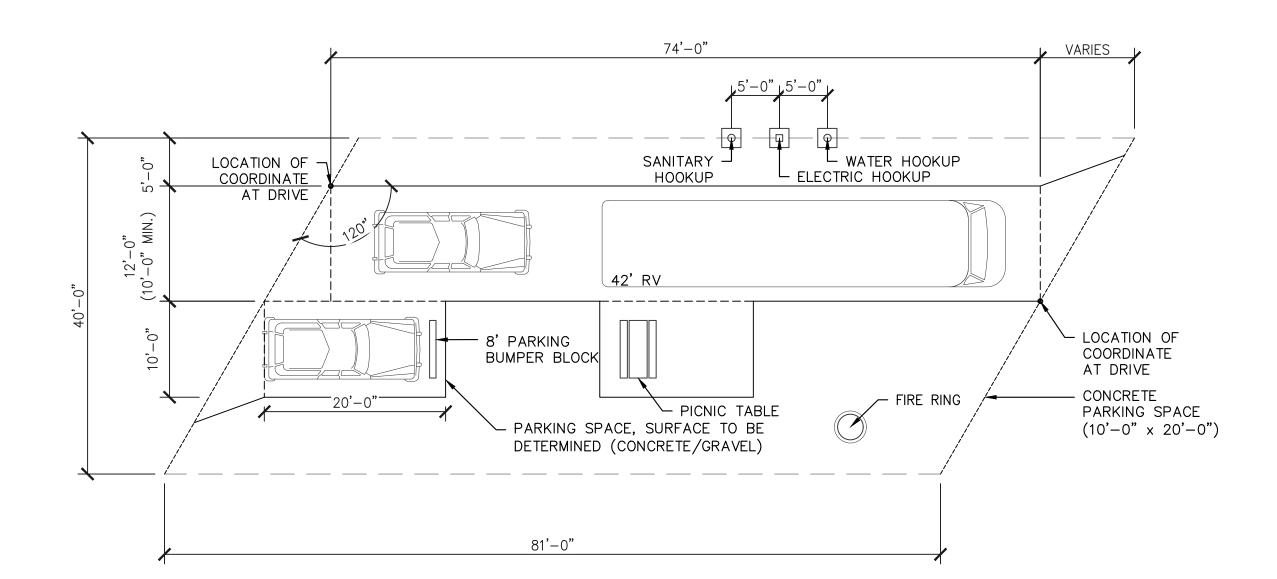

### © PREMIUM RV PULL-THROUGH CAMPSITE ENLARGED PLAN

(MINIMUM AREA: 1,500 SF PER CAMPSITE, AS SHOWN: 2,830 SF PER CAMPSITE)

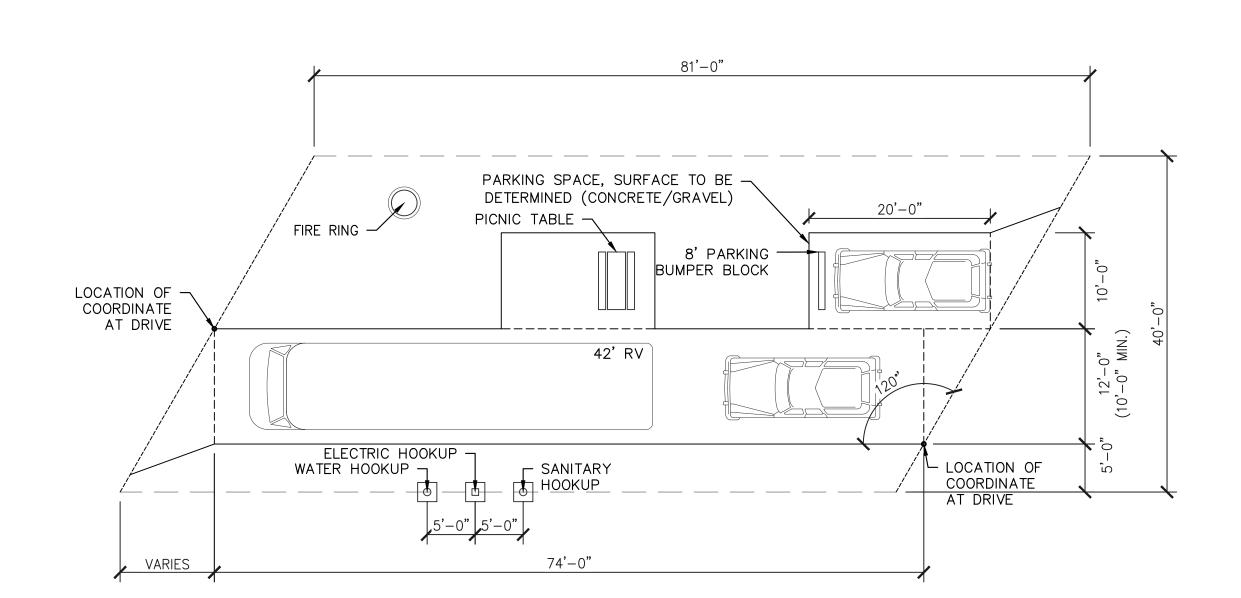


### D PREMIUM RV PULL-THROUGH REVERSE CAMPSITE ENLARGED PLAN

(MINIMUM AREA: 1,500 SF PER CAMPSITE, AS SHOWN: 2,830 SF PER CAMPSITE)

- PROVIDE MINIMUM 4'-0" CLEARANCE AROUND FIRE
- PIT ON ALL SIDES.

  2. PROVDE MINIMUM 3'-0" CLEARANCE AROUND THE PICNIC TABLE ON ALL SIDES.

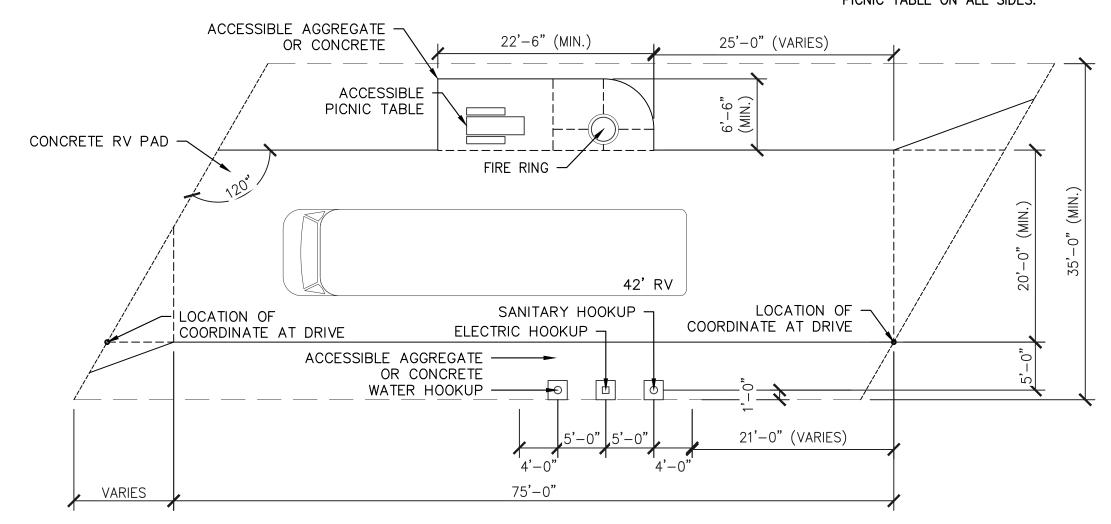


### PREMIUM ADA RV PULL-THROUGH REVERSE CAMPSITE ENLARGED PLAN

(MINIMUM AREA: 1,500 SF PER CAMPSITE, AS SHOWN: 2,830 SF PER CAMPSITE)

### NOTE


- 1. PROVIDE MINIMUM 4'-0" CLEARANCE AROUND FIRE
- PIT ON ALL SIDES.

  2. PROVDE MINIMUM 3'-0" CLEARANCE AROUND THE PICNIC TABLE ON ALL SIDES.

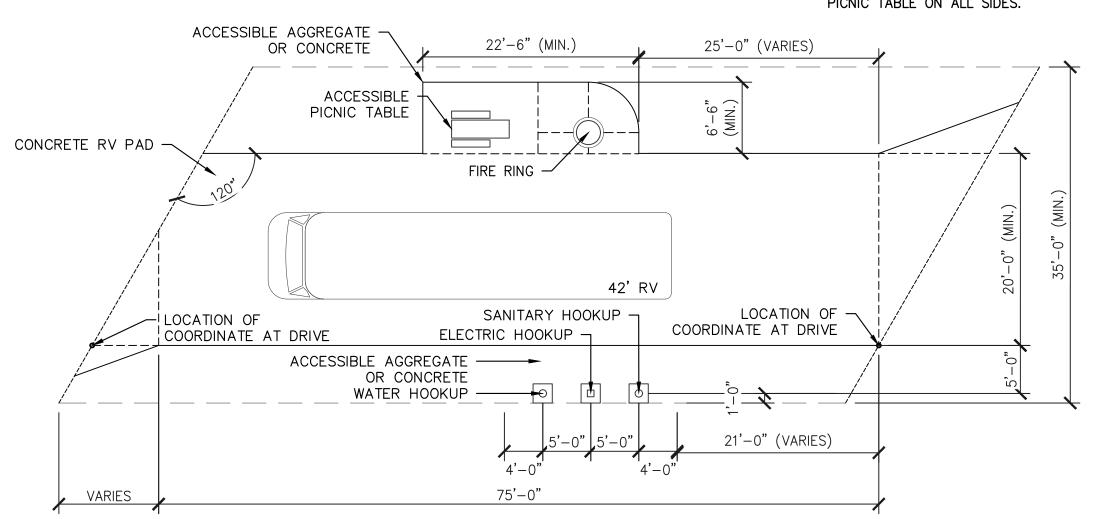


### PREMIUM ADA RV PULL-THROUGH REVERSE CAMPSITE ENLARGED PLAN

(MINIMUM AREA: 1,500 SF PER CAMPSITE, AS SHOWN: 2,830 SF PER CAMPSITE)

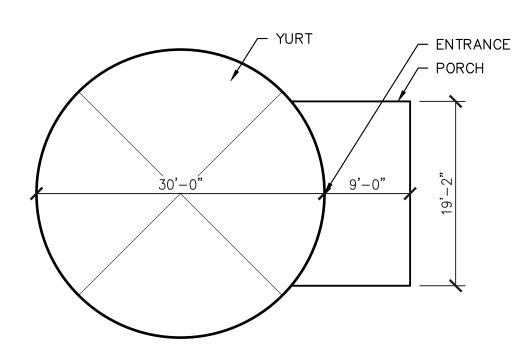

**E YURT CAMPSITE ENLARGED PLAN** 

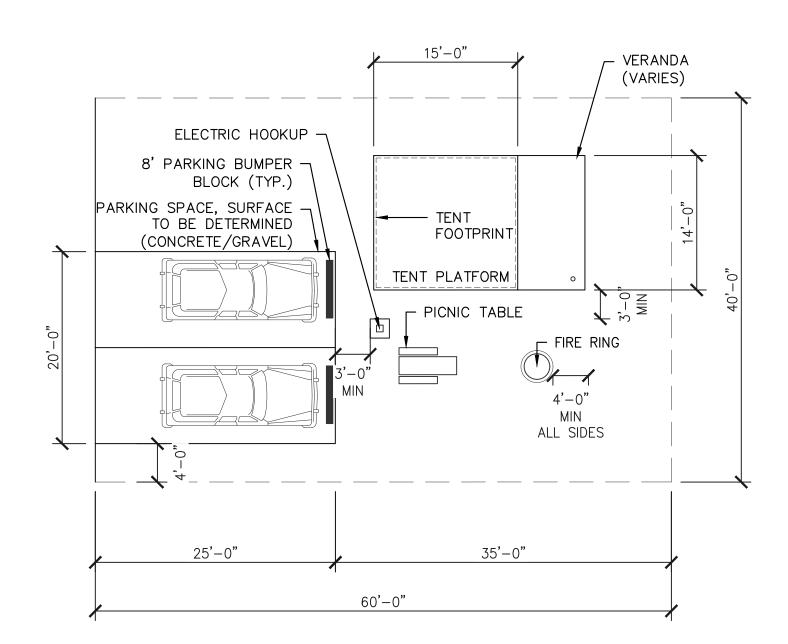

(MINIMUM AREA: 1,200 SF PER CAMPSITE, AS SHOWN: 2,400 SF PER CAMPSITE)

**F** TENTING ENLARGED PLAN

Environmental Design Group

AKRON / CLEVELAND / COLUMBUS

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P 330.375.1390 / TF 800.835.1390
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ZEBULON CAMPGROUND ROGER HONBARRIER & RYAN RIMMELE

30% CDS

PROJECT NO.: 23-00285-020


DRAWN BY: CMR/SDK

CHECKED BY: SDK

DATE ISSUED: 2024/04/01

CAMPSITE ENLARGEMENTS

C1.06

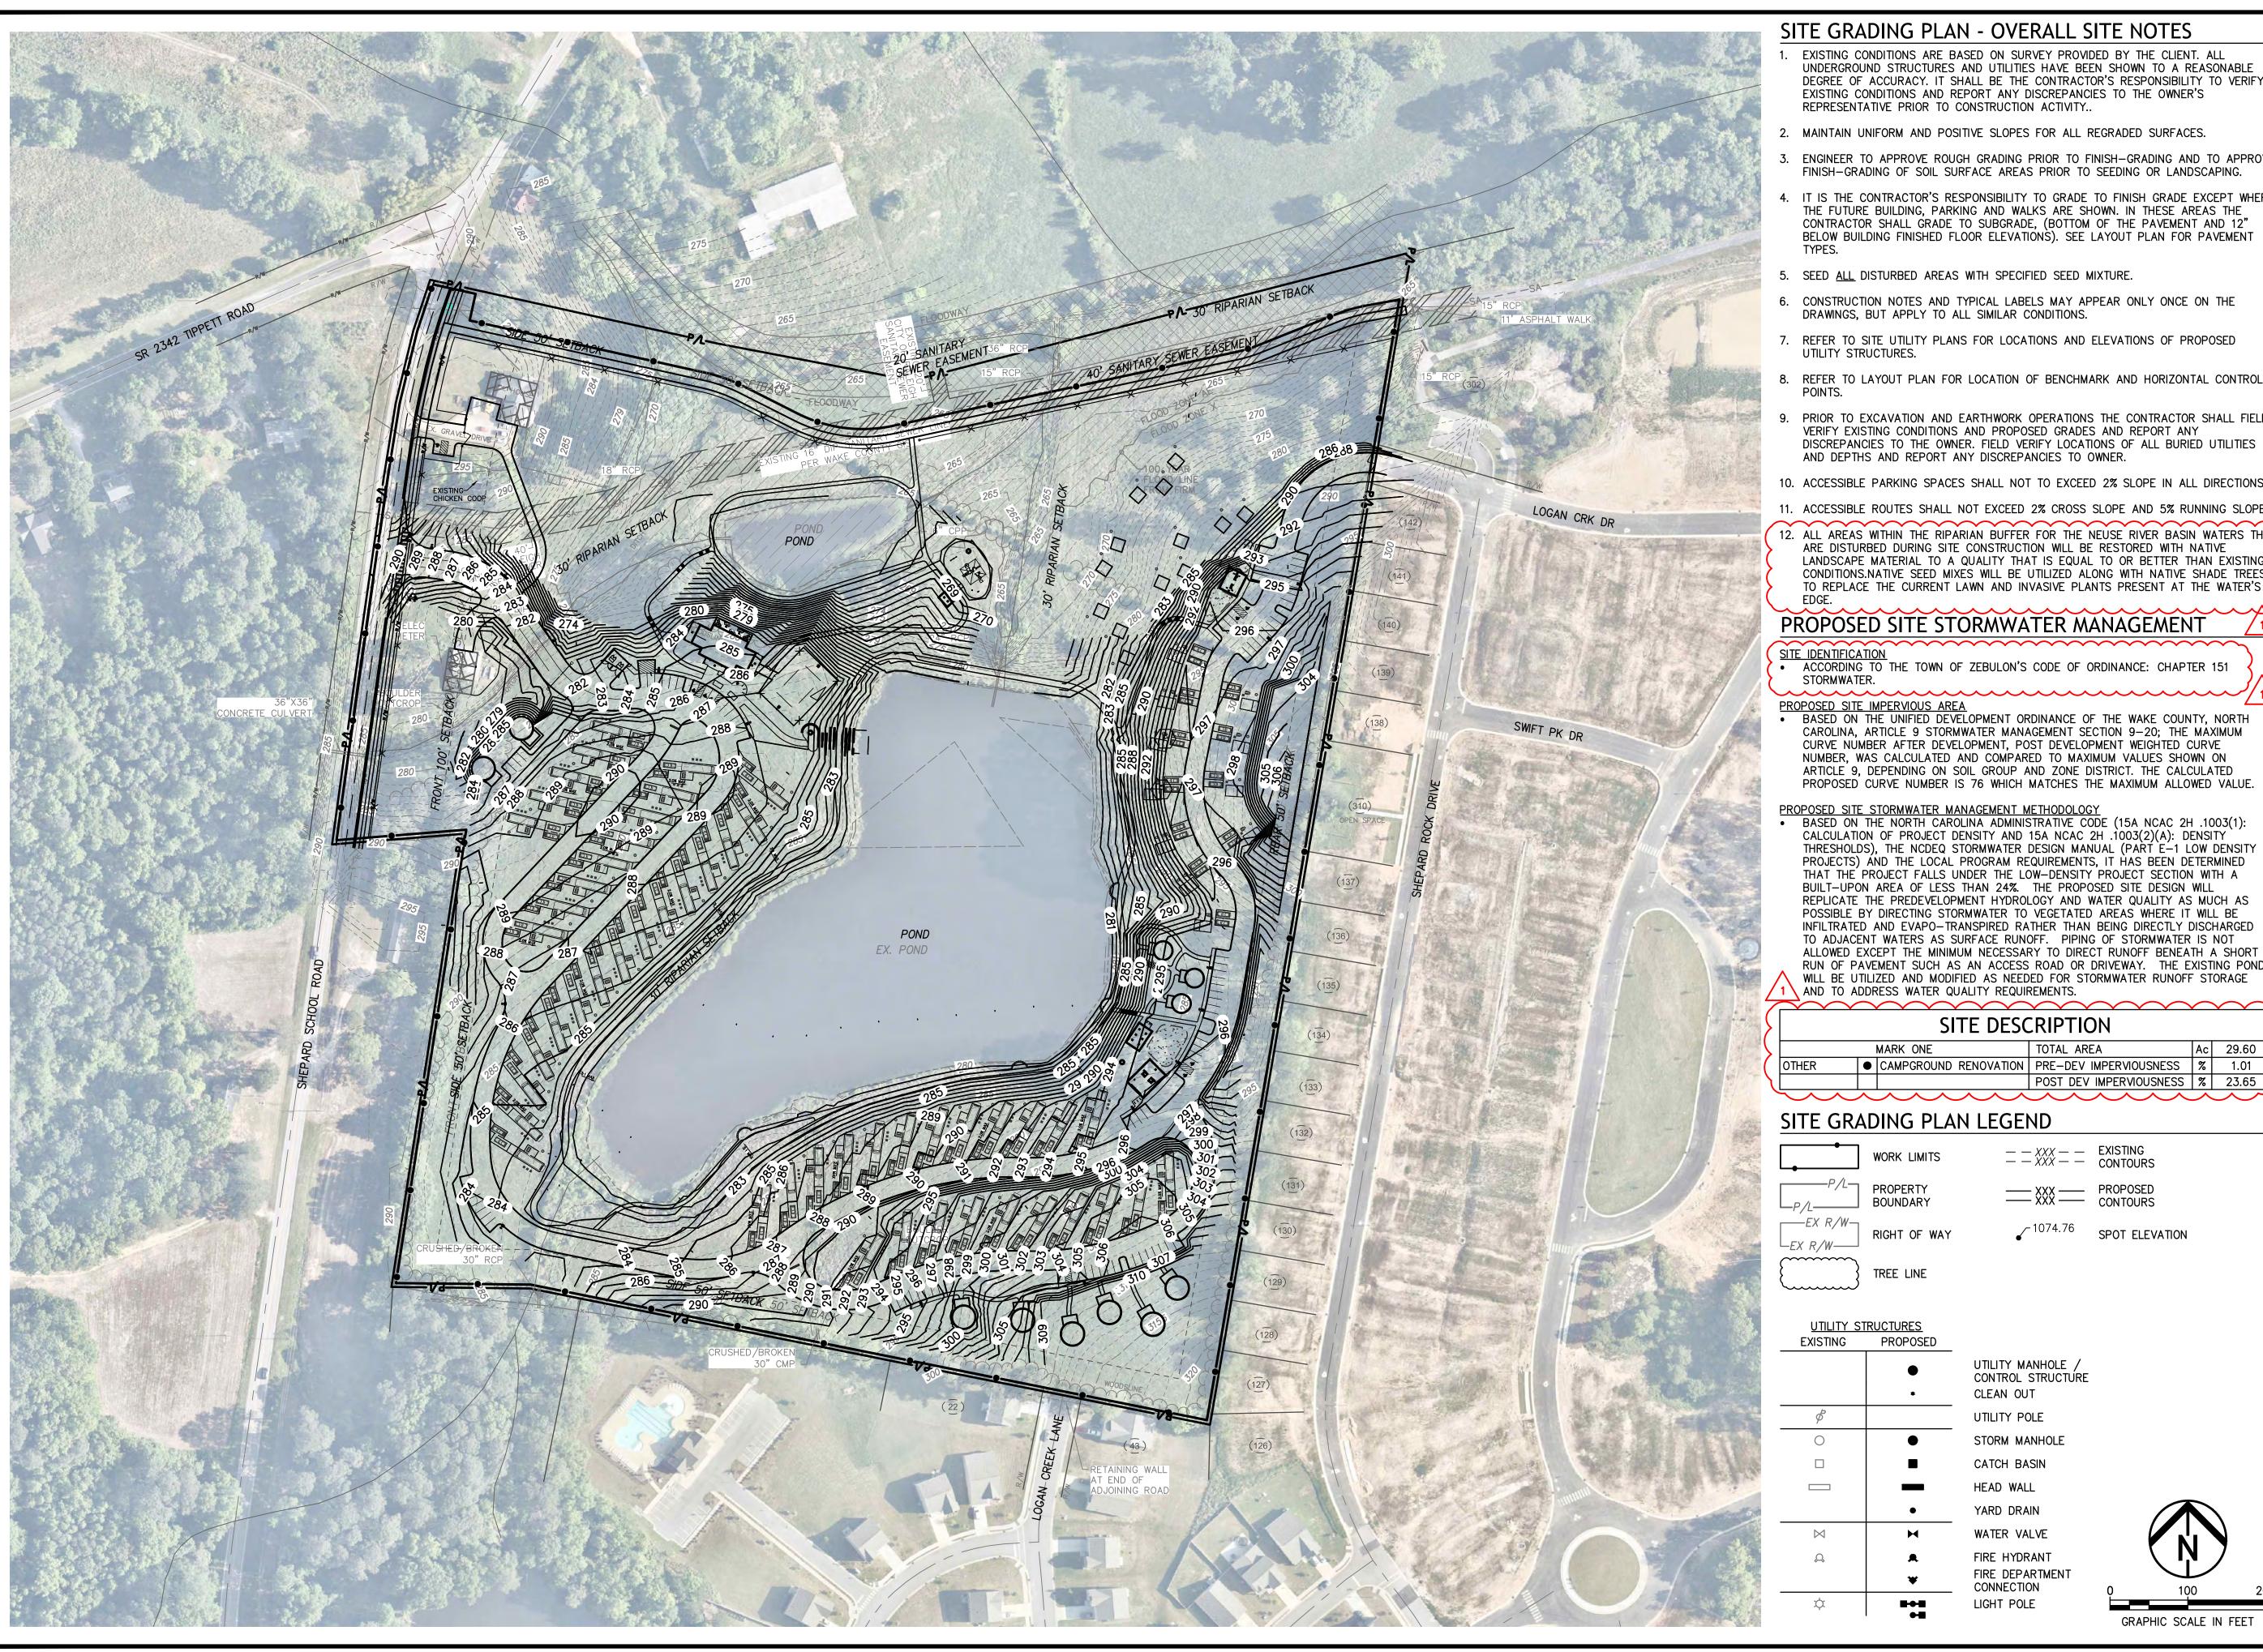

### SITE GRADING PLAN - OVERALL SITE NOTES

- EXISTING CONDITIONS ARE BASED ON SURVEY PROVIDED BY THE CLIENT. ALL UNDERGROUND STRUCTURES AND UTILITIES HAVE BEEN SHOWN TO A REASONABLE DEGREE OF ACCURACY. IT SHALL BE THE CONTRACTOR'S RESPONSIBILITY TO VERIFY EXISTING CONDITIONS AND REPORT ANY DISCREPANCIES TO THE OWNER'S REPRESENTATIVE PRIOR TO CONSTRUCTION ACTIVITY...
- 2. MAINTAIN UNIFORM AND POSITIVE SLOPES FOR ALL REGRADED SURFACES.
- 3. ENGINEER TO APPROVE ROUGH GRADING PRIOR TO FINISH-GRADING AND TO APPROVE FINISH-GRADING OF SOIL SURFACE AREAS PRIOR TO SEEDING OR LANDSCAPING.
- 4. IT IS THE CONTRACTOR'S RESPONSIBILITY TO GRADE TO FINISH GRADE EXCEPT WHERE THE FUTURE BUILDING, PARKING AND WALKS ARE SHOWN. IN THESE AREAS THE CONTRACTOR SHALL GRADE TO SUBGRADE, (BOTTOM OF THE PAVEMENT AND 12" BELOW BUILDING FINISHED FLOOR ELEVATIONS). SEE LAYOUT PLAN FOR PAVEMENT
- 5. SEED <u>ALL</u> DISTURBED AREAS WITH SPECIFIED SEED MIXTURE.
- 6. CONSTRUCTION NOTES AND TYPICAL LABELS MAY APPEAR ONLY ONCE ON THE DRAWINGS, BUT APPLY TO ALL SIMILAR CONDITIONS.
- 7. REFER TO SITE UTILITY PLANS FOR LOCATIONS AND ELEVATIONS OF PROPOSED UTILITY STRUCTURES.
- 8. REFER TO LAYOUT PLAN FOR LOCATION OF BENCHMARK AND HORIZONTAL CONTROL
- PRIOR TO EXCAVATION AND EARTHWORK OPERATIONS THE CONTRACTOR SHALL FIELD VERIFY EXISTING CONDITIONS AND PROPOSED GRADES AND REPORT ANY DISCREPANCIES TO THE OWNER. FIELD VERIFY LOCATIONS OF ALL BURIED UTILITIES AND DEPTHS AND REPORT ANY DISCREPANCIES TO OWNER.
- 10. ACCESSIBLE PARKING SPACES SHALL NOT TO EXCEED 2% SLOPE IN ALL DIRECTIONS.
- 11. ACCESSIBLE ROUTES SHALL NOT EXCEED 2% CROSS SLOPE AND 5% RUNNING SLOPE.
- 12. ALL AREAS WITHIN THE RIPARIAN BUFFER FOR THE NEUSE RIVER BASIN WATERS THAT ARE DISTURBED DURING SITE CONSTRUCTION WILL BE RESTORED WITH NATIVE LANDSCAPE MATERIAL TO A QUALITY THAT IS EQUAL TO OR BETTER THAN EXISTING CONDITIONS.NATIVE SEED MIXES WILL BE UTILIZED ALONG WITH NATIVE SHADE TREES TO REPLACE THE CURRENT LAWN AND INVASIVE PLANTS PRESENT AT THE WATER'S

### PROPOSED SITE STORMWATER MANAGEMENT

SITE IDENTIFICATION

• ACCORDING TO THE TOWN OF ZEBULON'S CODE OF ORDINANCE: CHAPTER 151 STORMWATER.

PROPOSED SITE IMPERVIOUS AREA

BASED ON THE UNIFIED DEVELOPMENT ORDINANCE OF THE WAKE COUNTY, NORTH CAROLINA, ARTICLE 9 STORMWATER MANAGEMENT SECTION 9-20; THE MAXIMUM CURVE NUMBER AFTER DEVELOPMENT, POST DEVELOPMENT WEIGHTED CURVE NUMBER, WAS CALCULATED AND COMPARED TO MAXIMUM VALUES SHOWN ON ARTICLE 9, DEPENDING ON SOIL GROUP AND ZONE DISTRICT. THE CALCULATED PROPOSED CURVE NUMBER IS 76 WHICH MATCHES THE MAXIMUM ALLOWED VALUE.


PROPOSED SITE STORMWATER MANAGEMENT METHODOLOGY

• BASED ON THE NORTH CAROLINA ADMINISTRATIVE CODE (15A NCAC 2H .1003(1): CALCULATION OF PROJECT DENSITY AND 15A NCAC 2H .1003(2)(A): DENSITY THRESHOLDS), THE NCDEQ STORMWATER DESIGN MANUAL (PART E-1 LOW DENSITY PROJECTS) AND THE LOCAL PROGRAM REQUIREMENTS, IT HAS BEEN DETERMINED THAT THE PROJECT FALLS UNDER THE LOW-DENSITY PROJECT SECTION WITH A BUILT-UPON AREA OF LESS THAN 24%. THE PROPOSED SITE DESIGN WILL REPLICATE THE PREDEVELOPMENT HYDROLOGY AND WATER QUALITY AS MUCH AS POSSIBLE BY DIRECTING STORMWATER TO VEGETATED AREAS WHERE IT WILL BE INFILTRATED AND EVAPO-TRANSPIRED RATHER THAN BEING DIRECTLY DISCHARGED TO ADJACENT WATERS AS SURFACE RUNOFF. PIPING OF STORMWATER IS NOT ALLOWED EXCEPT THE MINIMUM NECESSARY TO DIRECT RUNOFF BENEATH A SHORT RUN OF PAVEMENT SUCH AS AN ACCESS ROAD OR DRIVEWAY. THE EXISTING POND WILL BE UTILIZED AND MODIFIED AS NEEDED FOR STORMWATER RUNOFF STORAGE AND TO ADDRESS WATER QUALITY REQUIREMENTS.

### SITE DESCRIPTION

7		SITE DESCRIPTION					
\			MARK ONE	TOTAL AREA	Ac	29.60	] .
	OTHER	•	CAMPGROUND RENOVATION	PRE-DEV IMPERVIOUSNESS	%	1.01	] `
١				POST DEV IMPERVIOUSNESS	%	23.65	],


### SITE GRADING PLAN LEGEND

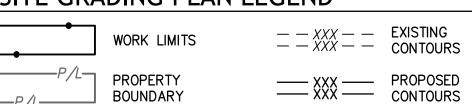

✓ 1074.76 SPOT ELEVATION RIGHT OF WAY TREE LINE

UTILITY	STRUCTURES
EXISTING	PROPOSED

<u>UTILITY ST</u>	RUCTURES	
EXISTING	PROPOSED	
	•	UTILITY MANHOLE / CONTROL STRUCTURE
	*	CLEAN OUT
ø		UTILITY POLE
0	•	STORM MANHOLE
		CATCH BASIN
	_	HEAD WALL
	•	YARD DRAIN
$\bowtie$	×	WATER VALVE
Ω		FIRE HYDRANT
	*	FIRE DEPARTMENT

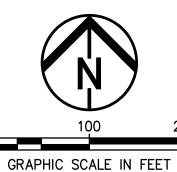

DRAWN BY: CMR/SDK CHECKED BY: DATE ISSUED: 2024/04/01

23-00285-020

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**Design**Group

Know what's below.
Call before you dig.

RIMM

HONB,

AMPGROUND

EBU

30% CDS

**REVISIONS** 


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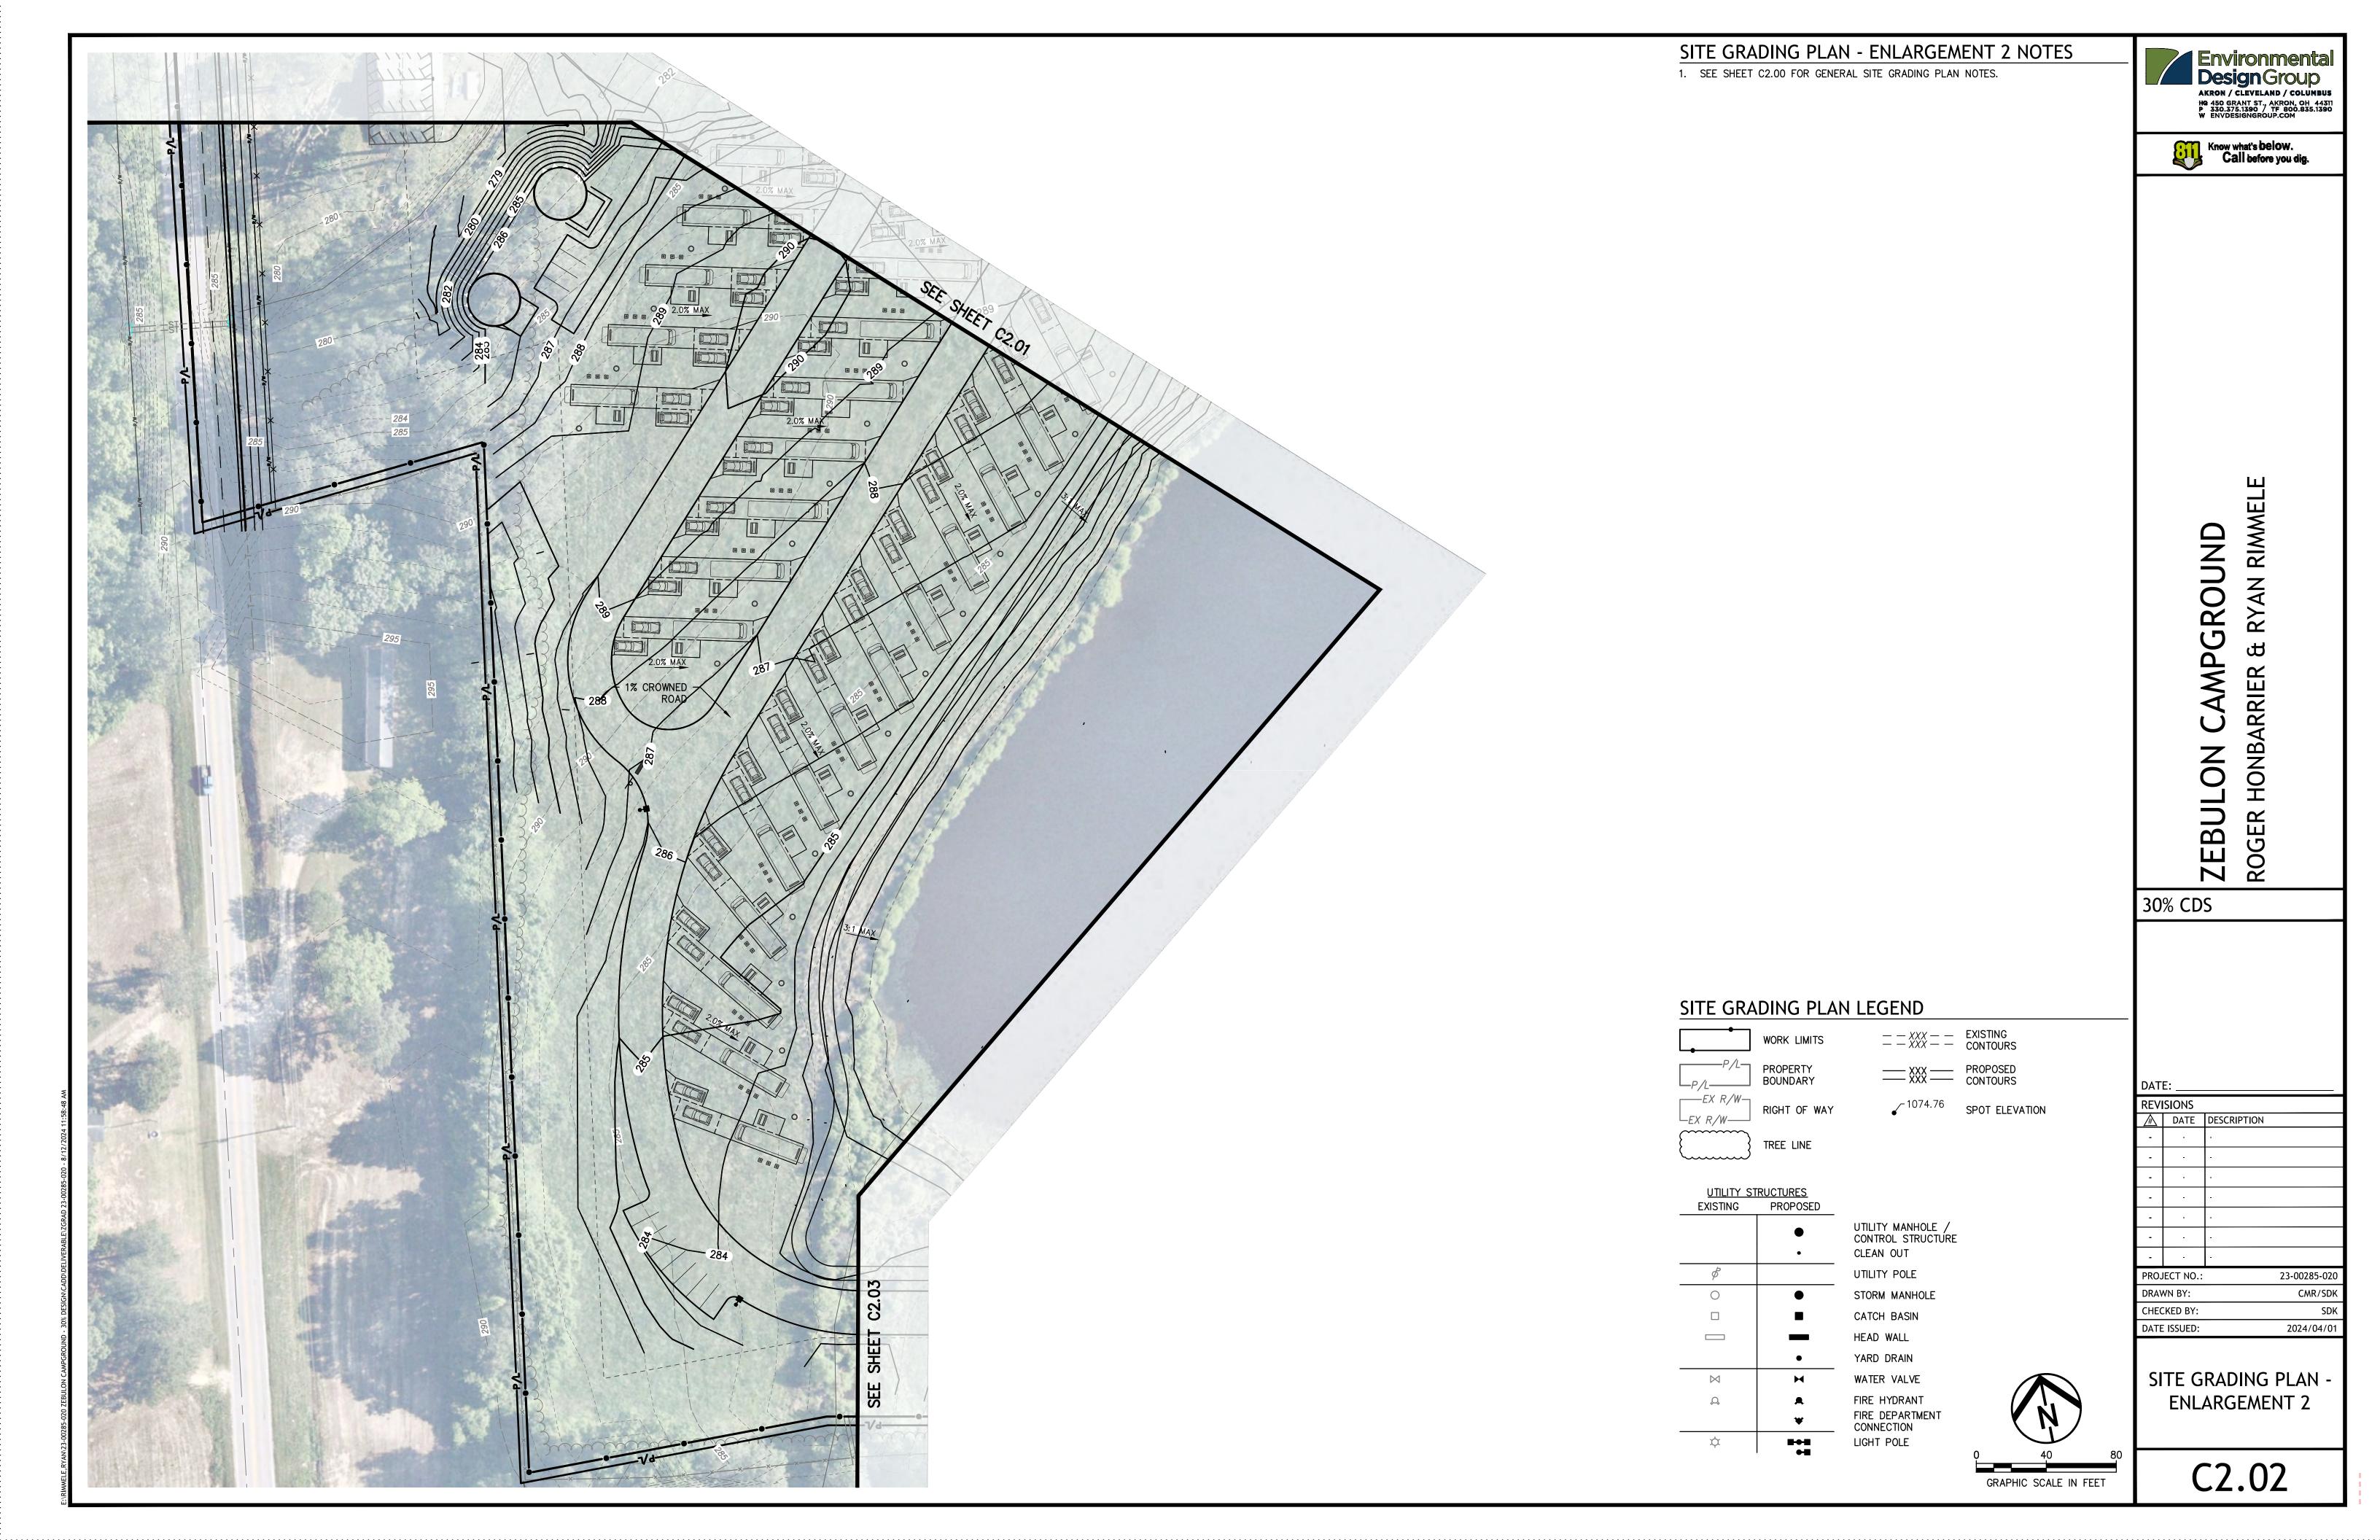
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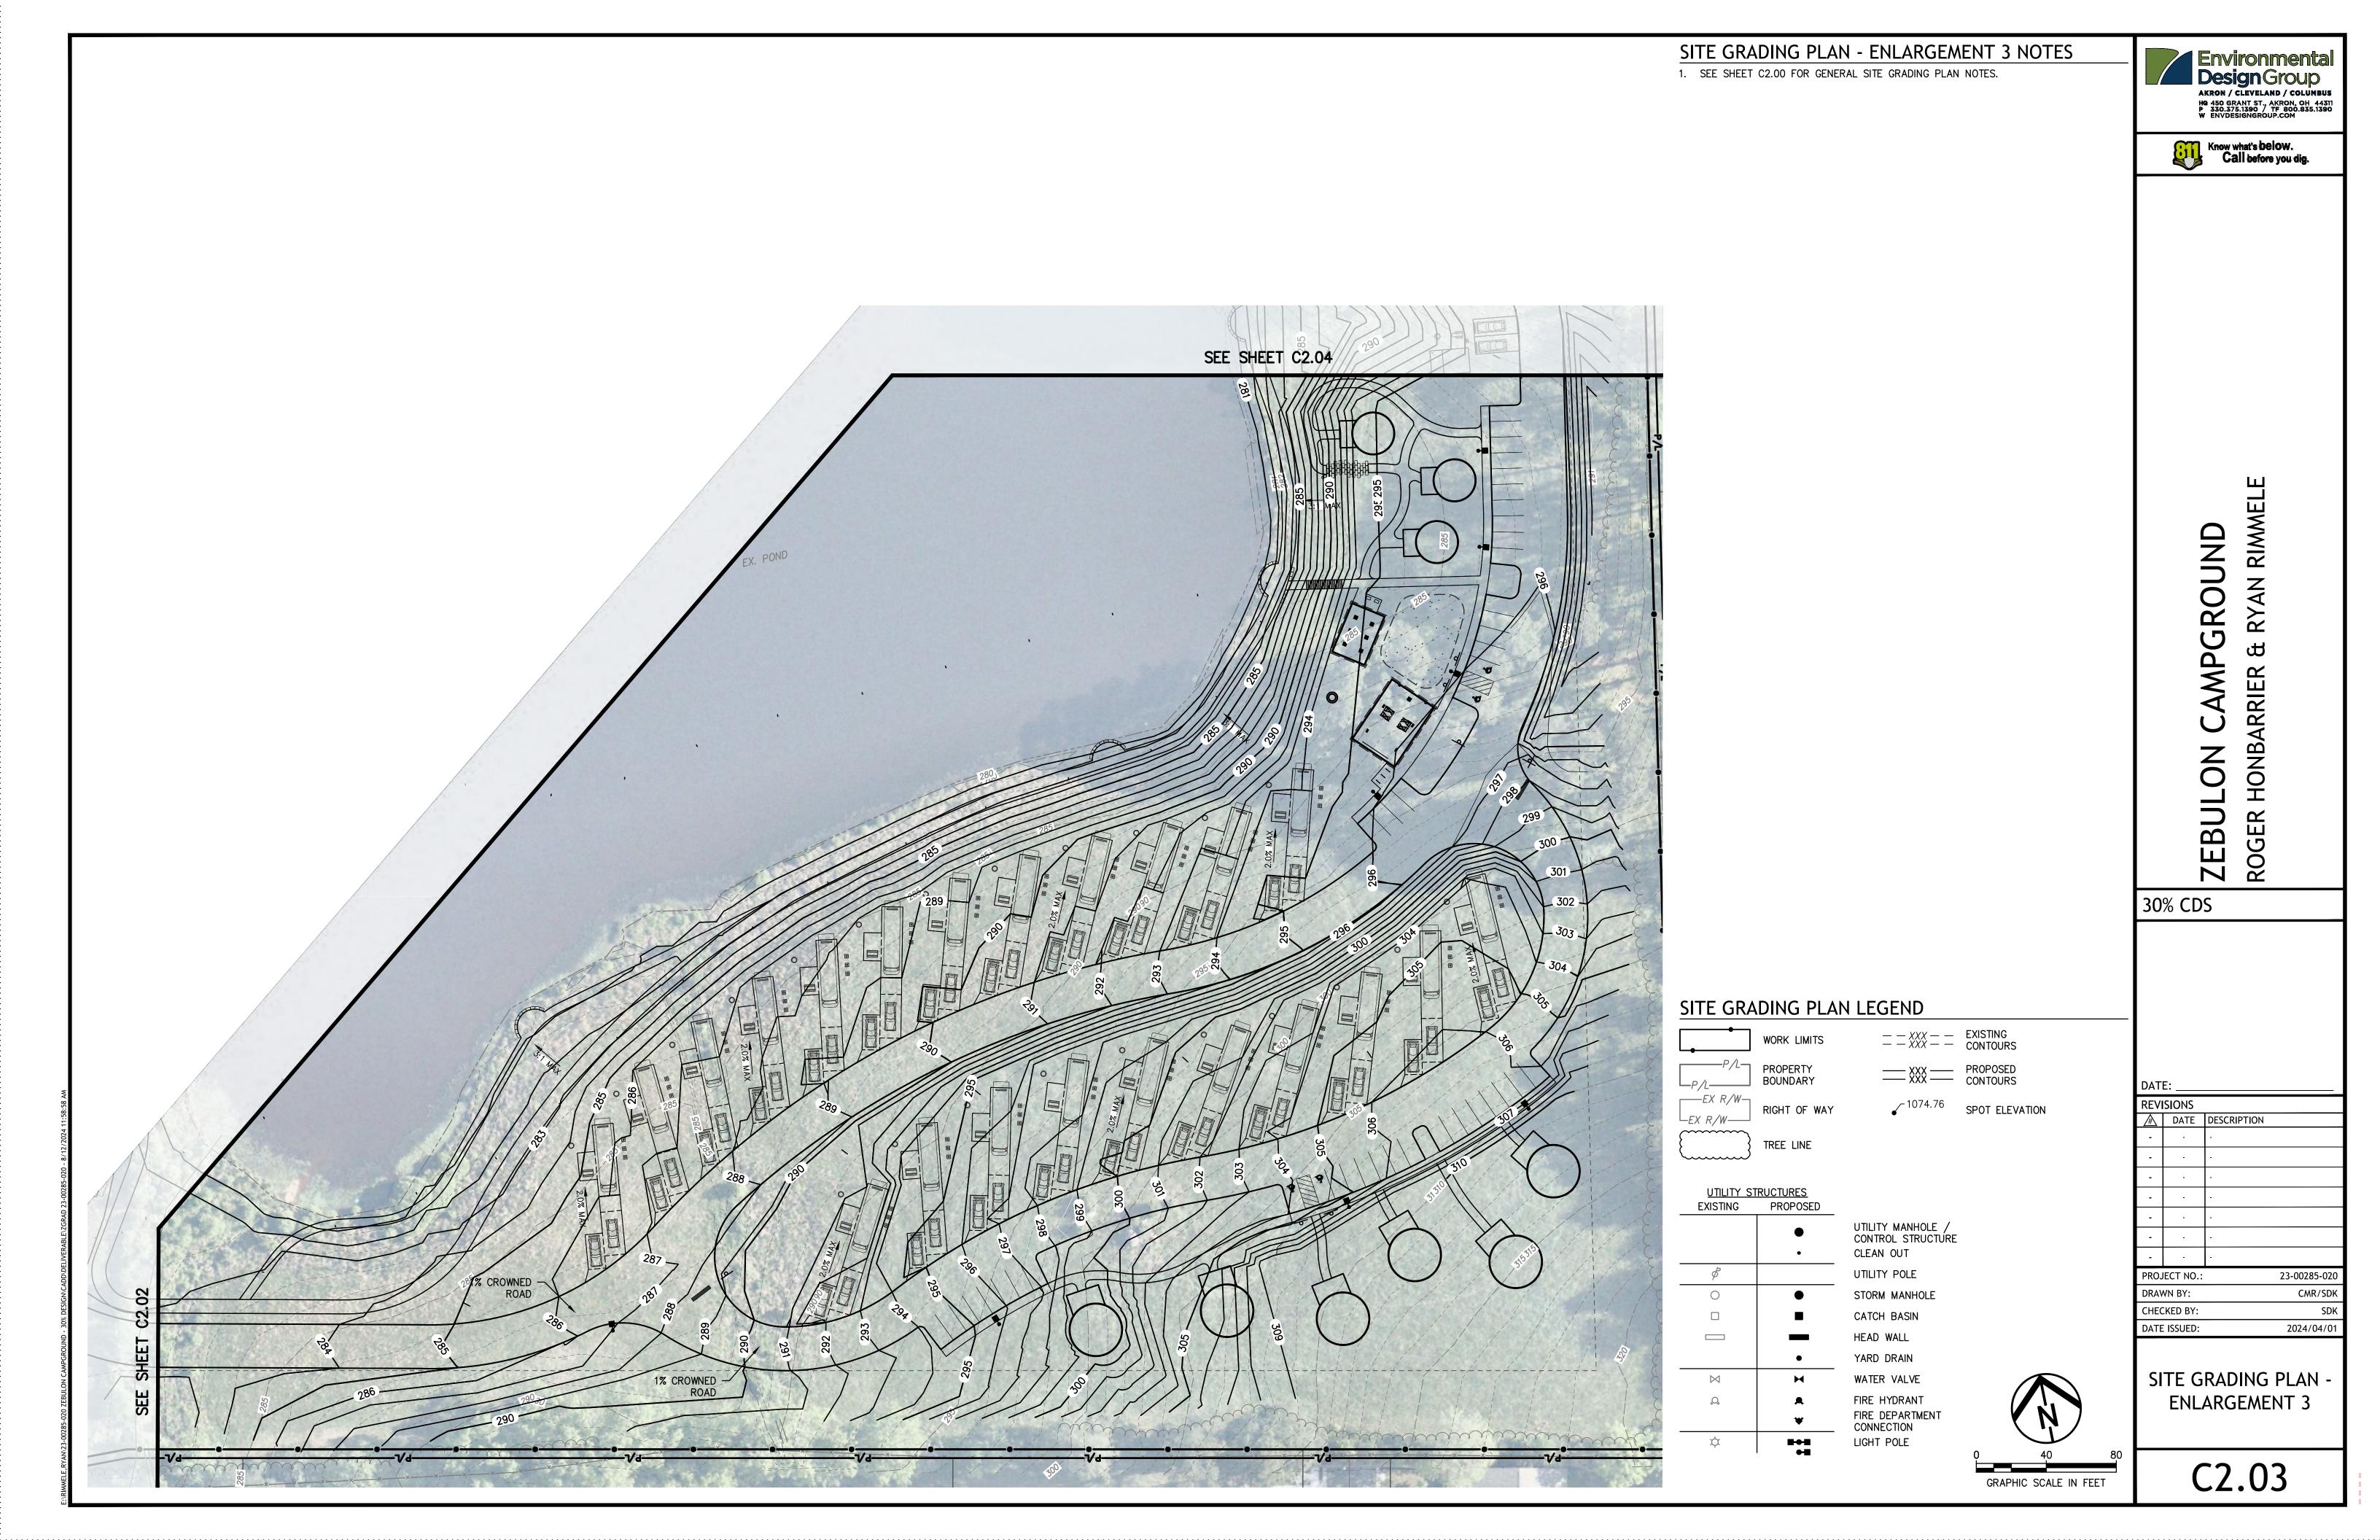
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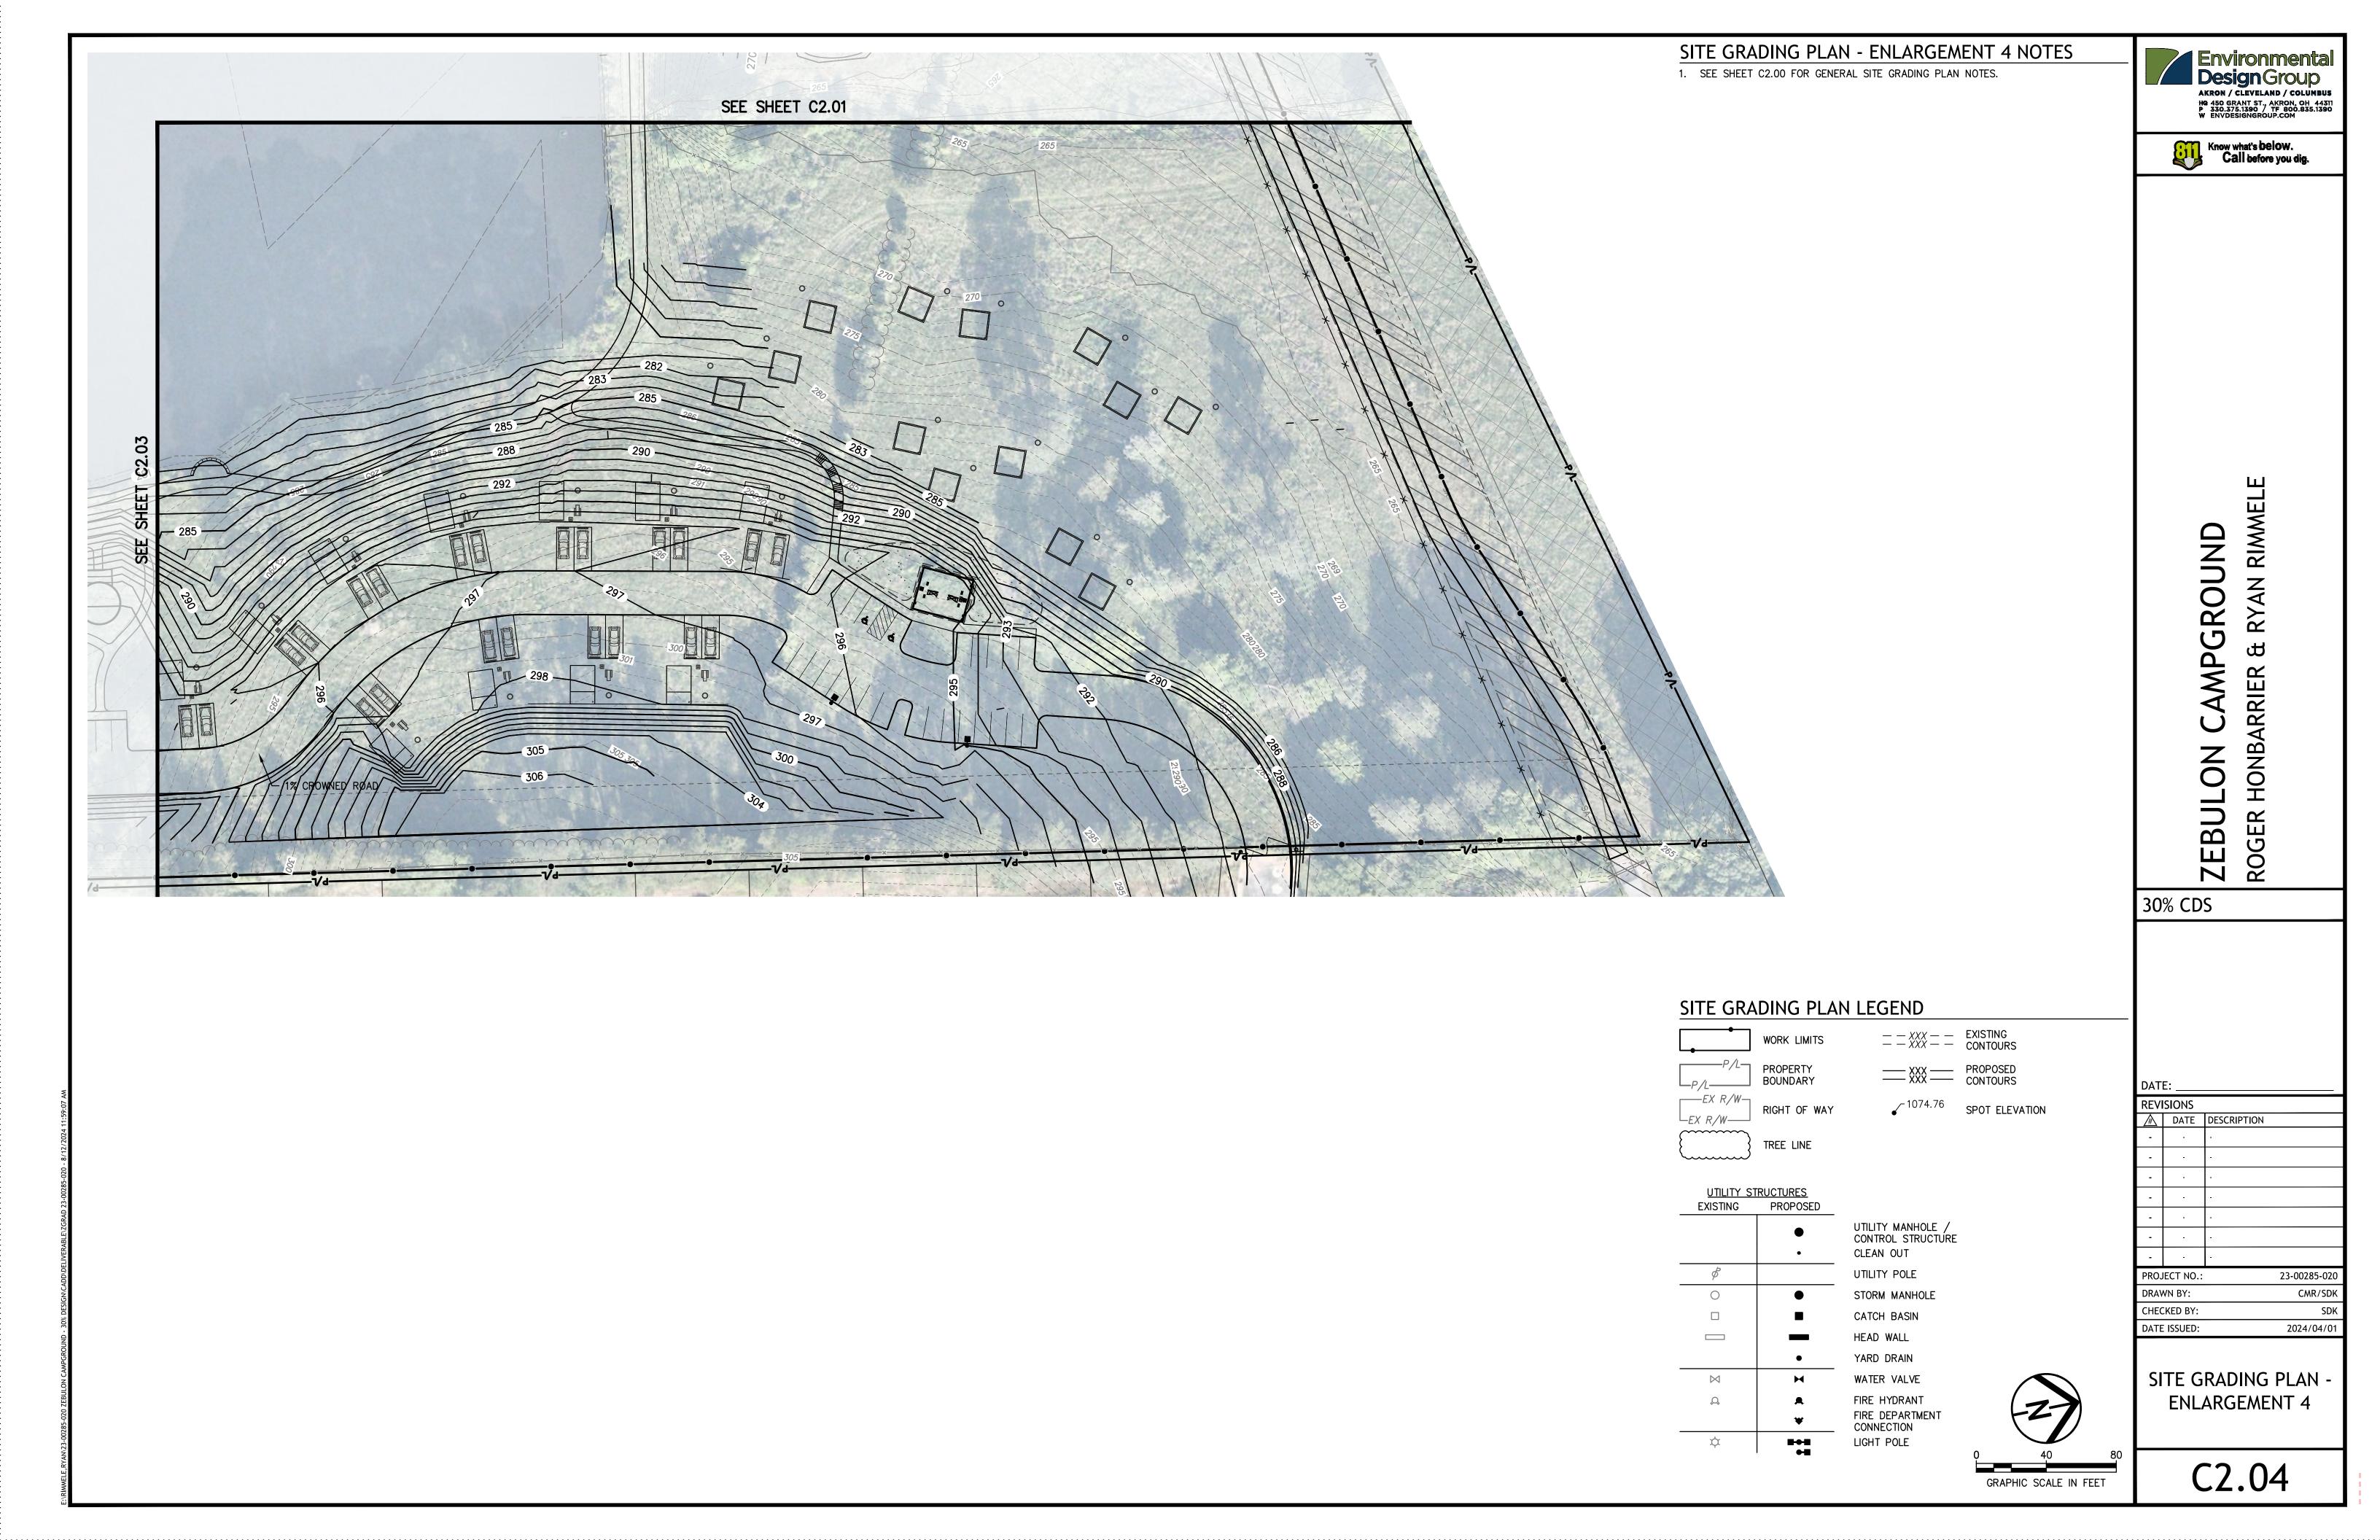
SITE GRADING PLAN **OVERALL SITE** 


C2.00







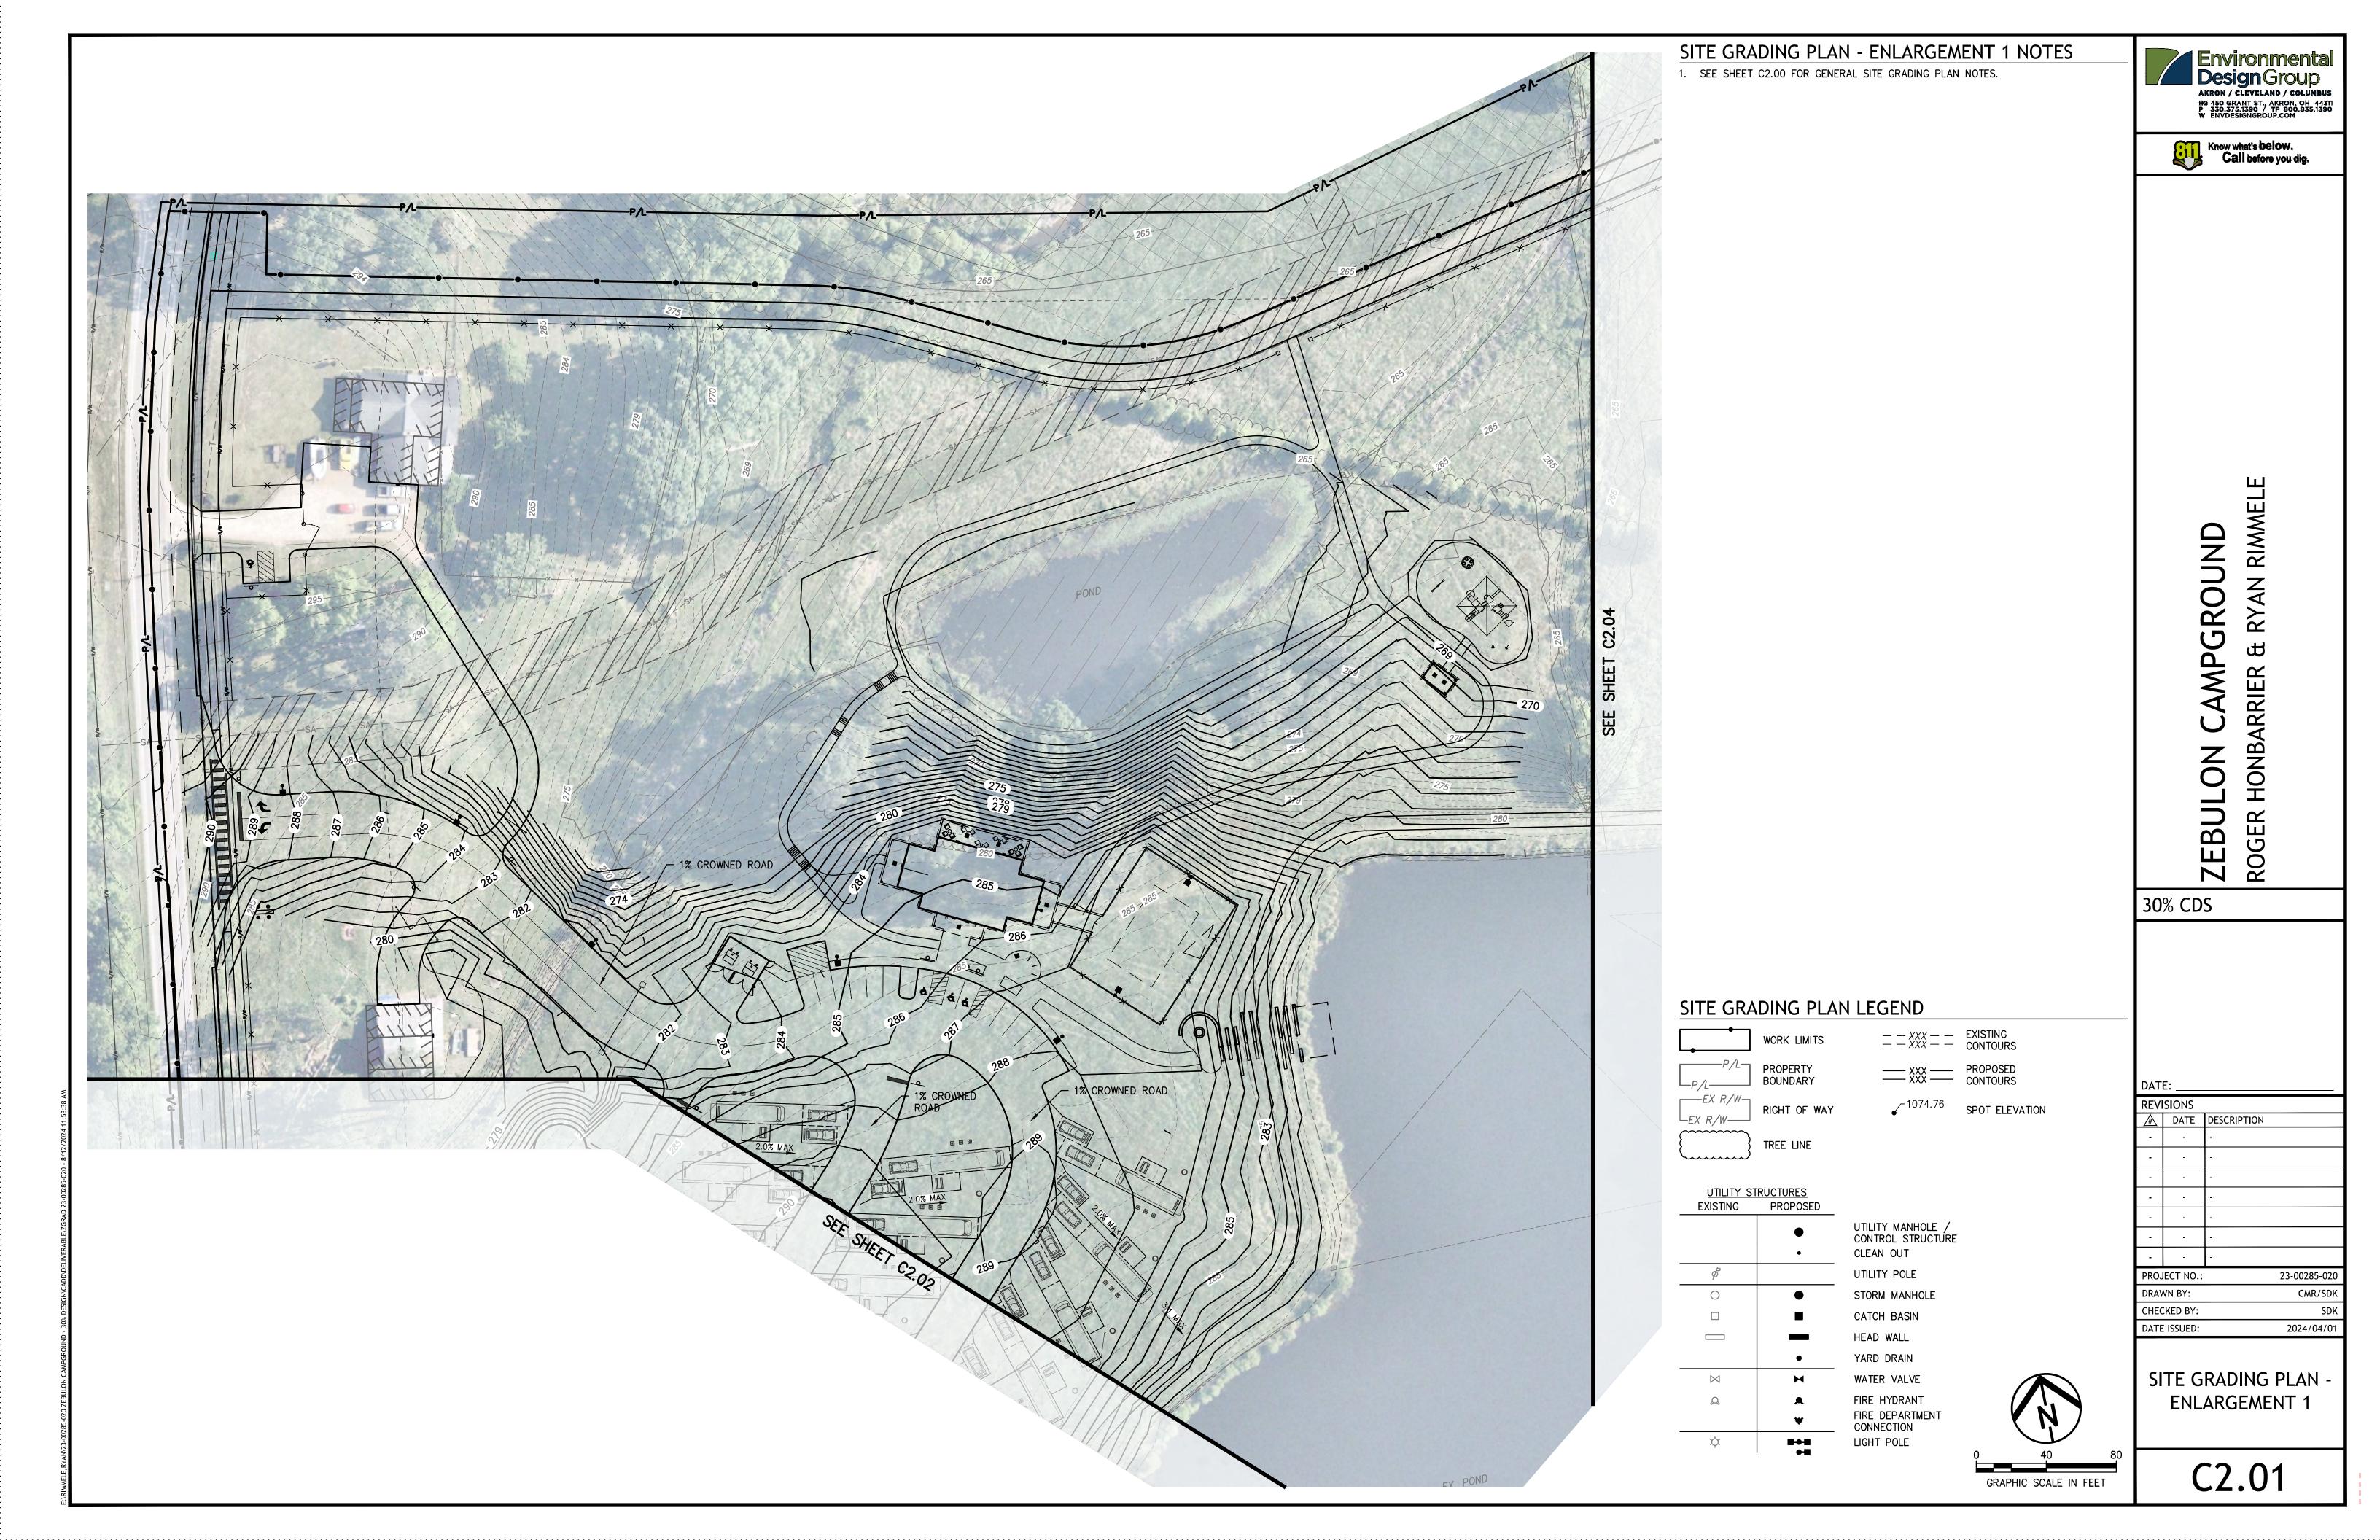

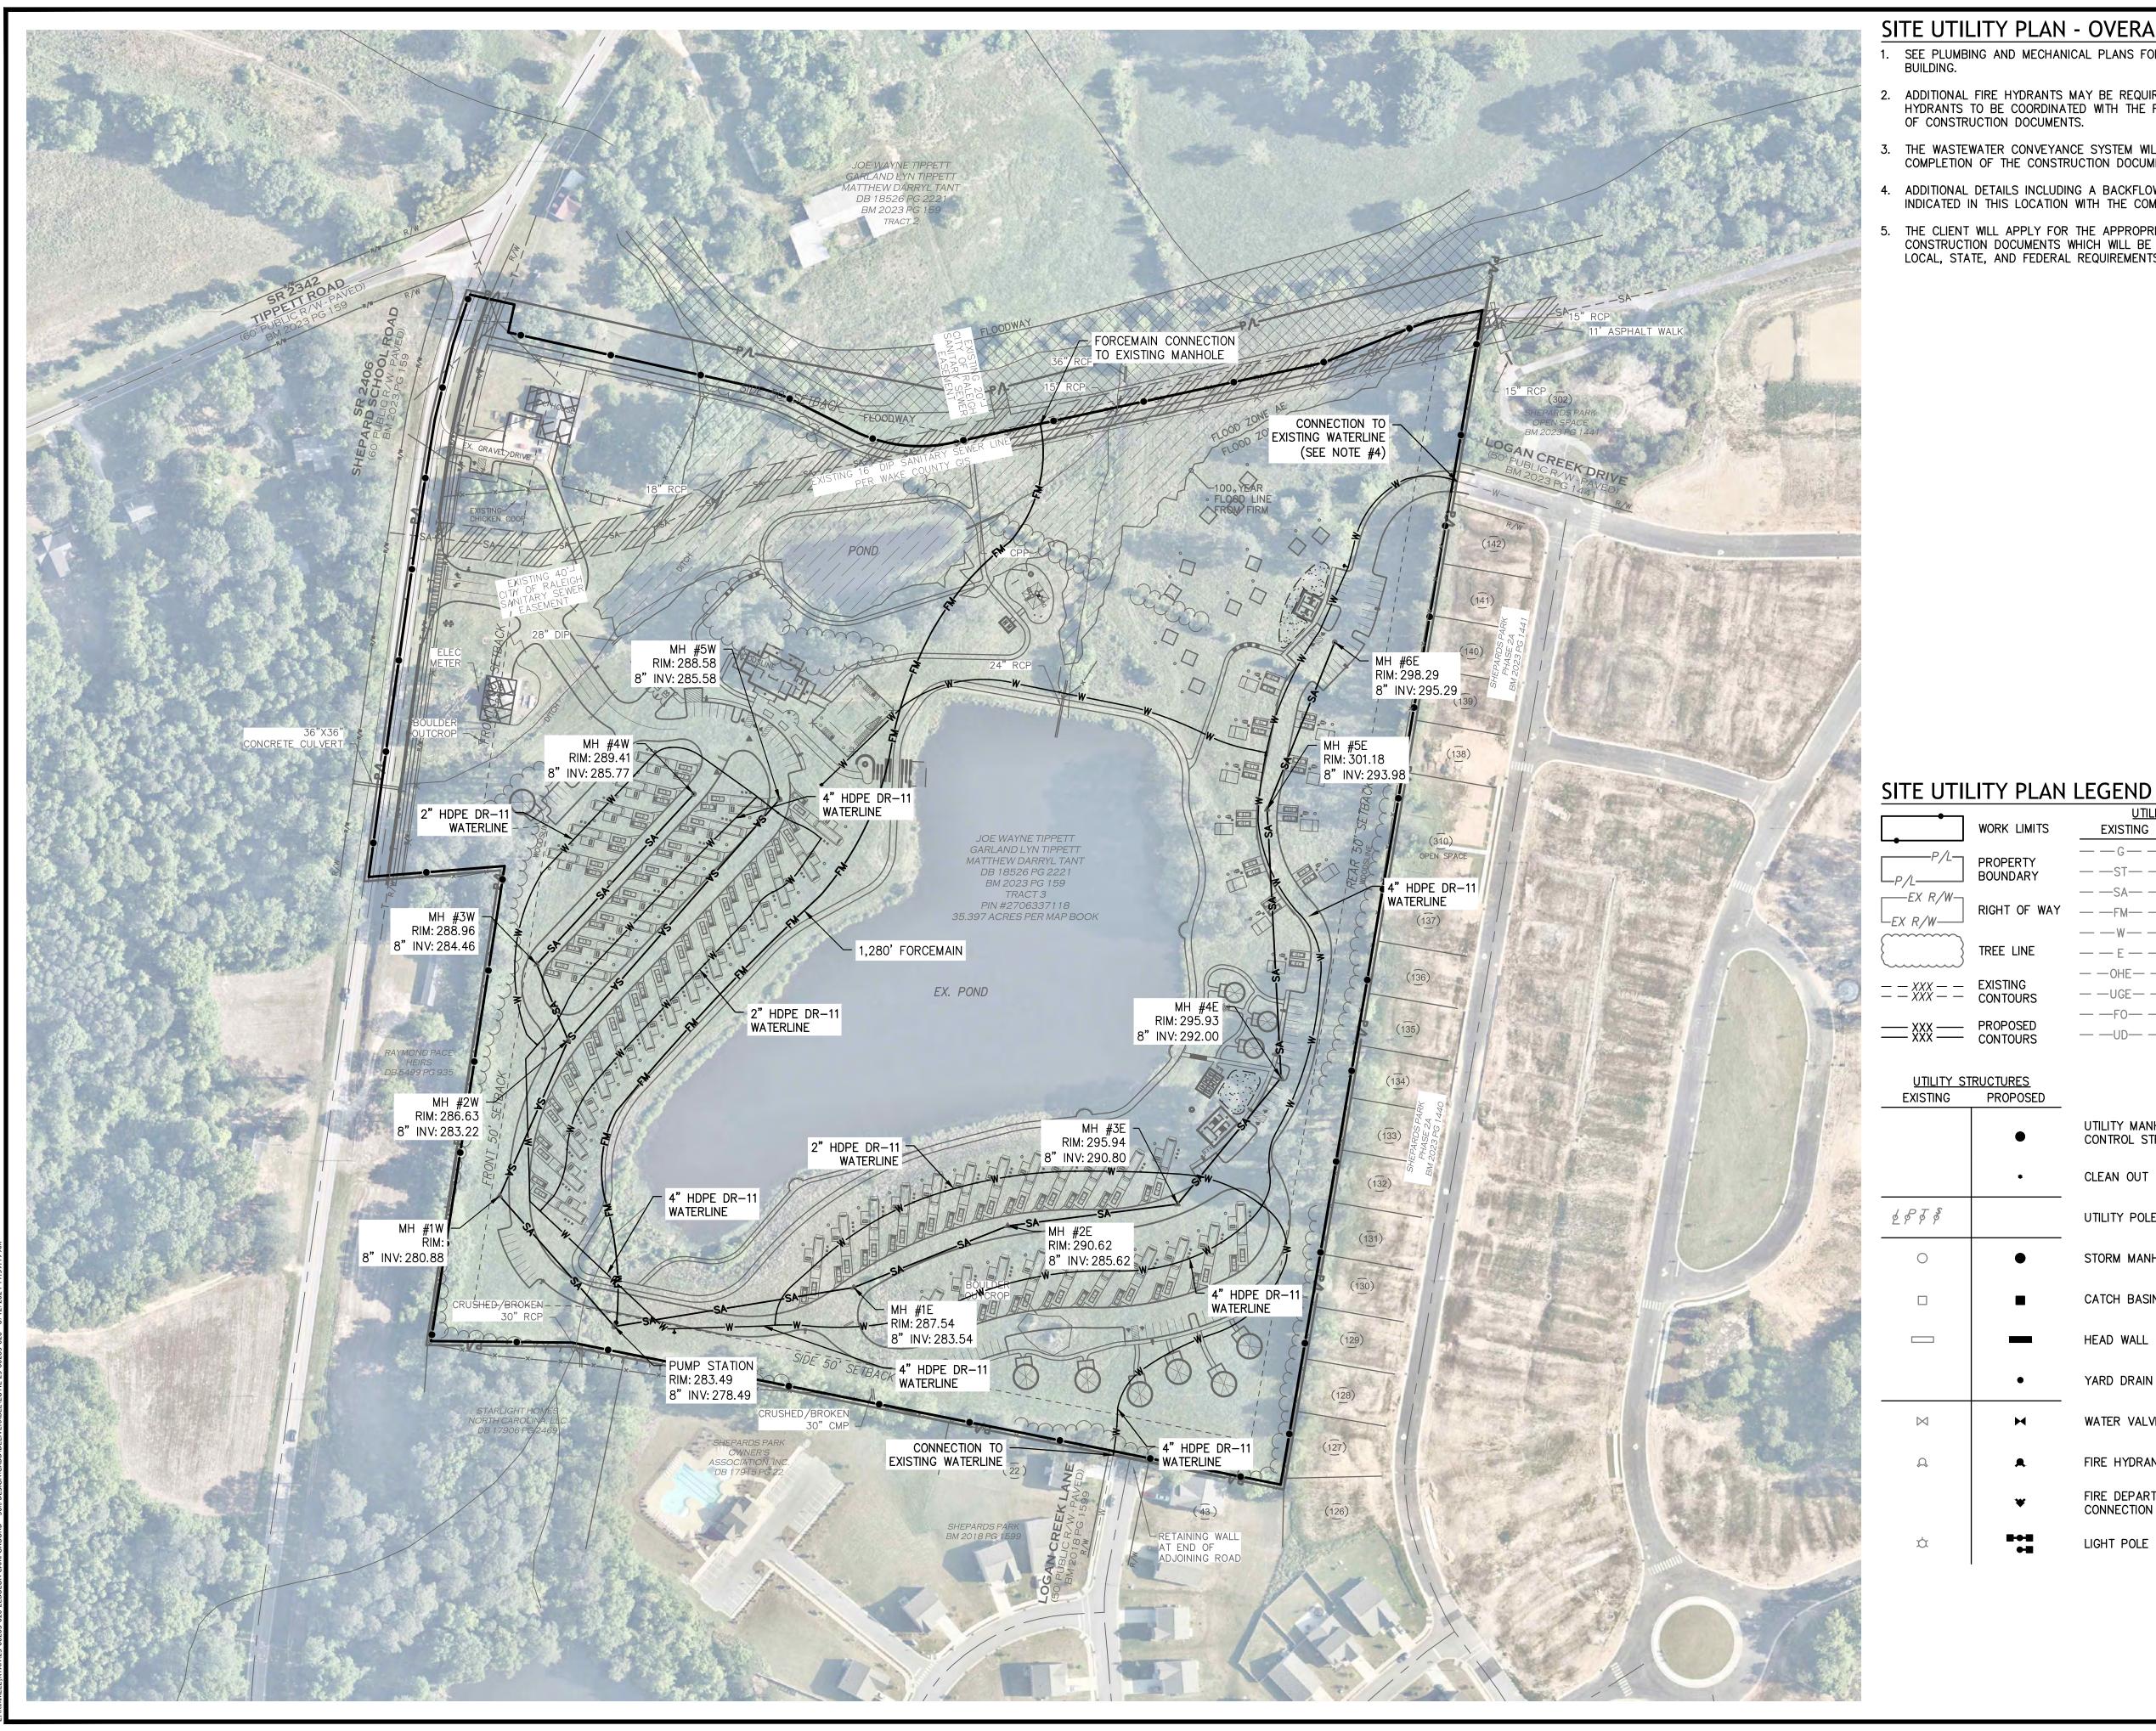

### SITE UTILITY PLAN - OVERALL SITE NOTES

- 1. SEE PLUMBING AND MECHANICAL PLANS FOR UTILITY WORK WITHIN 5' OF THE
- 2. ADDITIONAL FIRE HYDRANTS MAY BE REQUIRED. LOCATION AND NUMBER OF FIRE HYDRANTS TO BE COORDINATED WITH THE FIRE DEPARTMENT WITH THE COMPLETION OF CONSTRUCTION DOCUMENTS.
- 3. THE WASTEWATER CONVEYANCE SYSTEM WILL BE FURTHER ANALYZED WITH COMPLETION OF THE CONSTRUCTION DOCUMENTS.
- 4. ADDITIONAL DETAILS INCLUDING A BACKFLOW PREVENTOR AND METER TO BE INDICATED IN THIS LOCATION WITH THE COMPLETION OF CONSTRUCTION DOCUMENTS.
- 5. THE CLIENT WILL APPLY FOR THE APPROPRIATE SUBMITTALS UPON COMPLETION OF CONSTRUCTION DOCUMENTS WHICH WILL BE DEVELOPED IN ACCORDANCE WITH THE LOCAL, STATE, AND FEDERAL REQUIREMENTS.

UTILITY LINES

EXISTING

UTILITY MANHOLE / CONTROL STRUCTURE

CLEAN OUT

UTILITY POLE

STORM MANHOLE

CATCH BASIN

HEAD WALL

YARD DRAIN

WATER VALVE

FIRE HYDRANT

CONNECTION

LIGHT POLE

FIRE DEPARTMENT

WORK LIMITS

PROPERTY

BOUNDARY

PROPOSED

-- UGE-- UGE-- UG ELECTRIC

E ELECTRIC

——OHE—— OH ELECTRIC

——FO—— ROOF DRAIN

——UD—— UNDERDRAIN

GRAPHIC SCALE IN FEET

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# AMPGROUND HONB, EBUL 17 12

**REVISIONS** 

30% CDS

⚠ DATE DESCRIPTION

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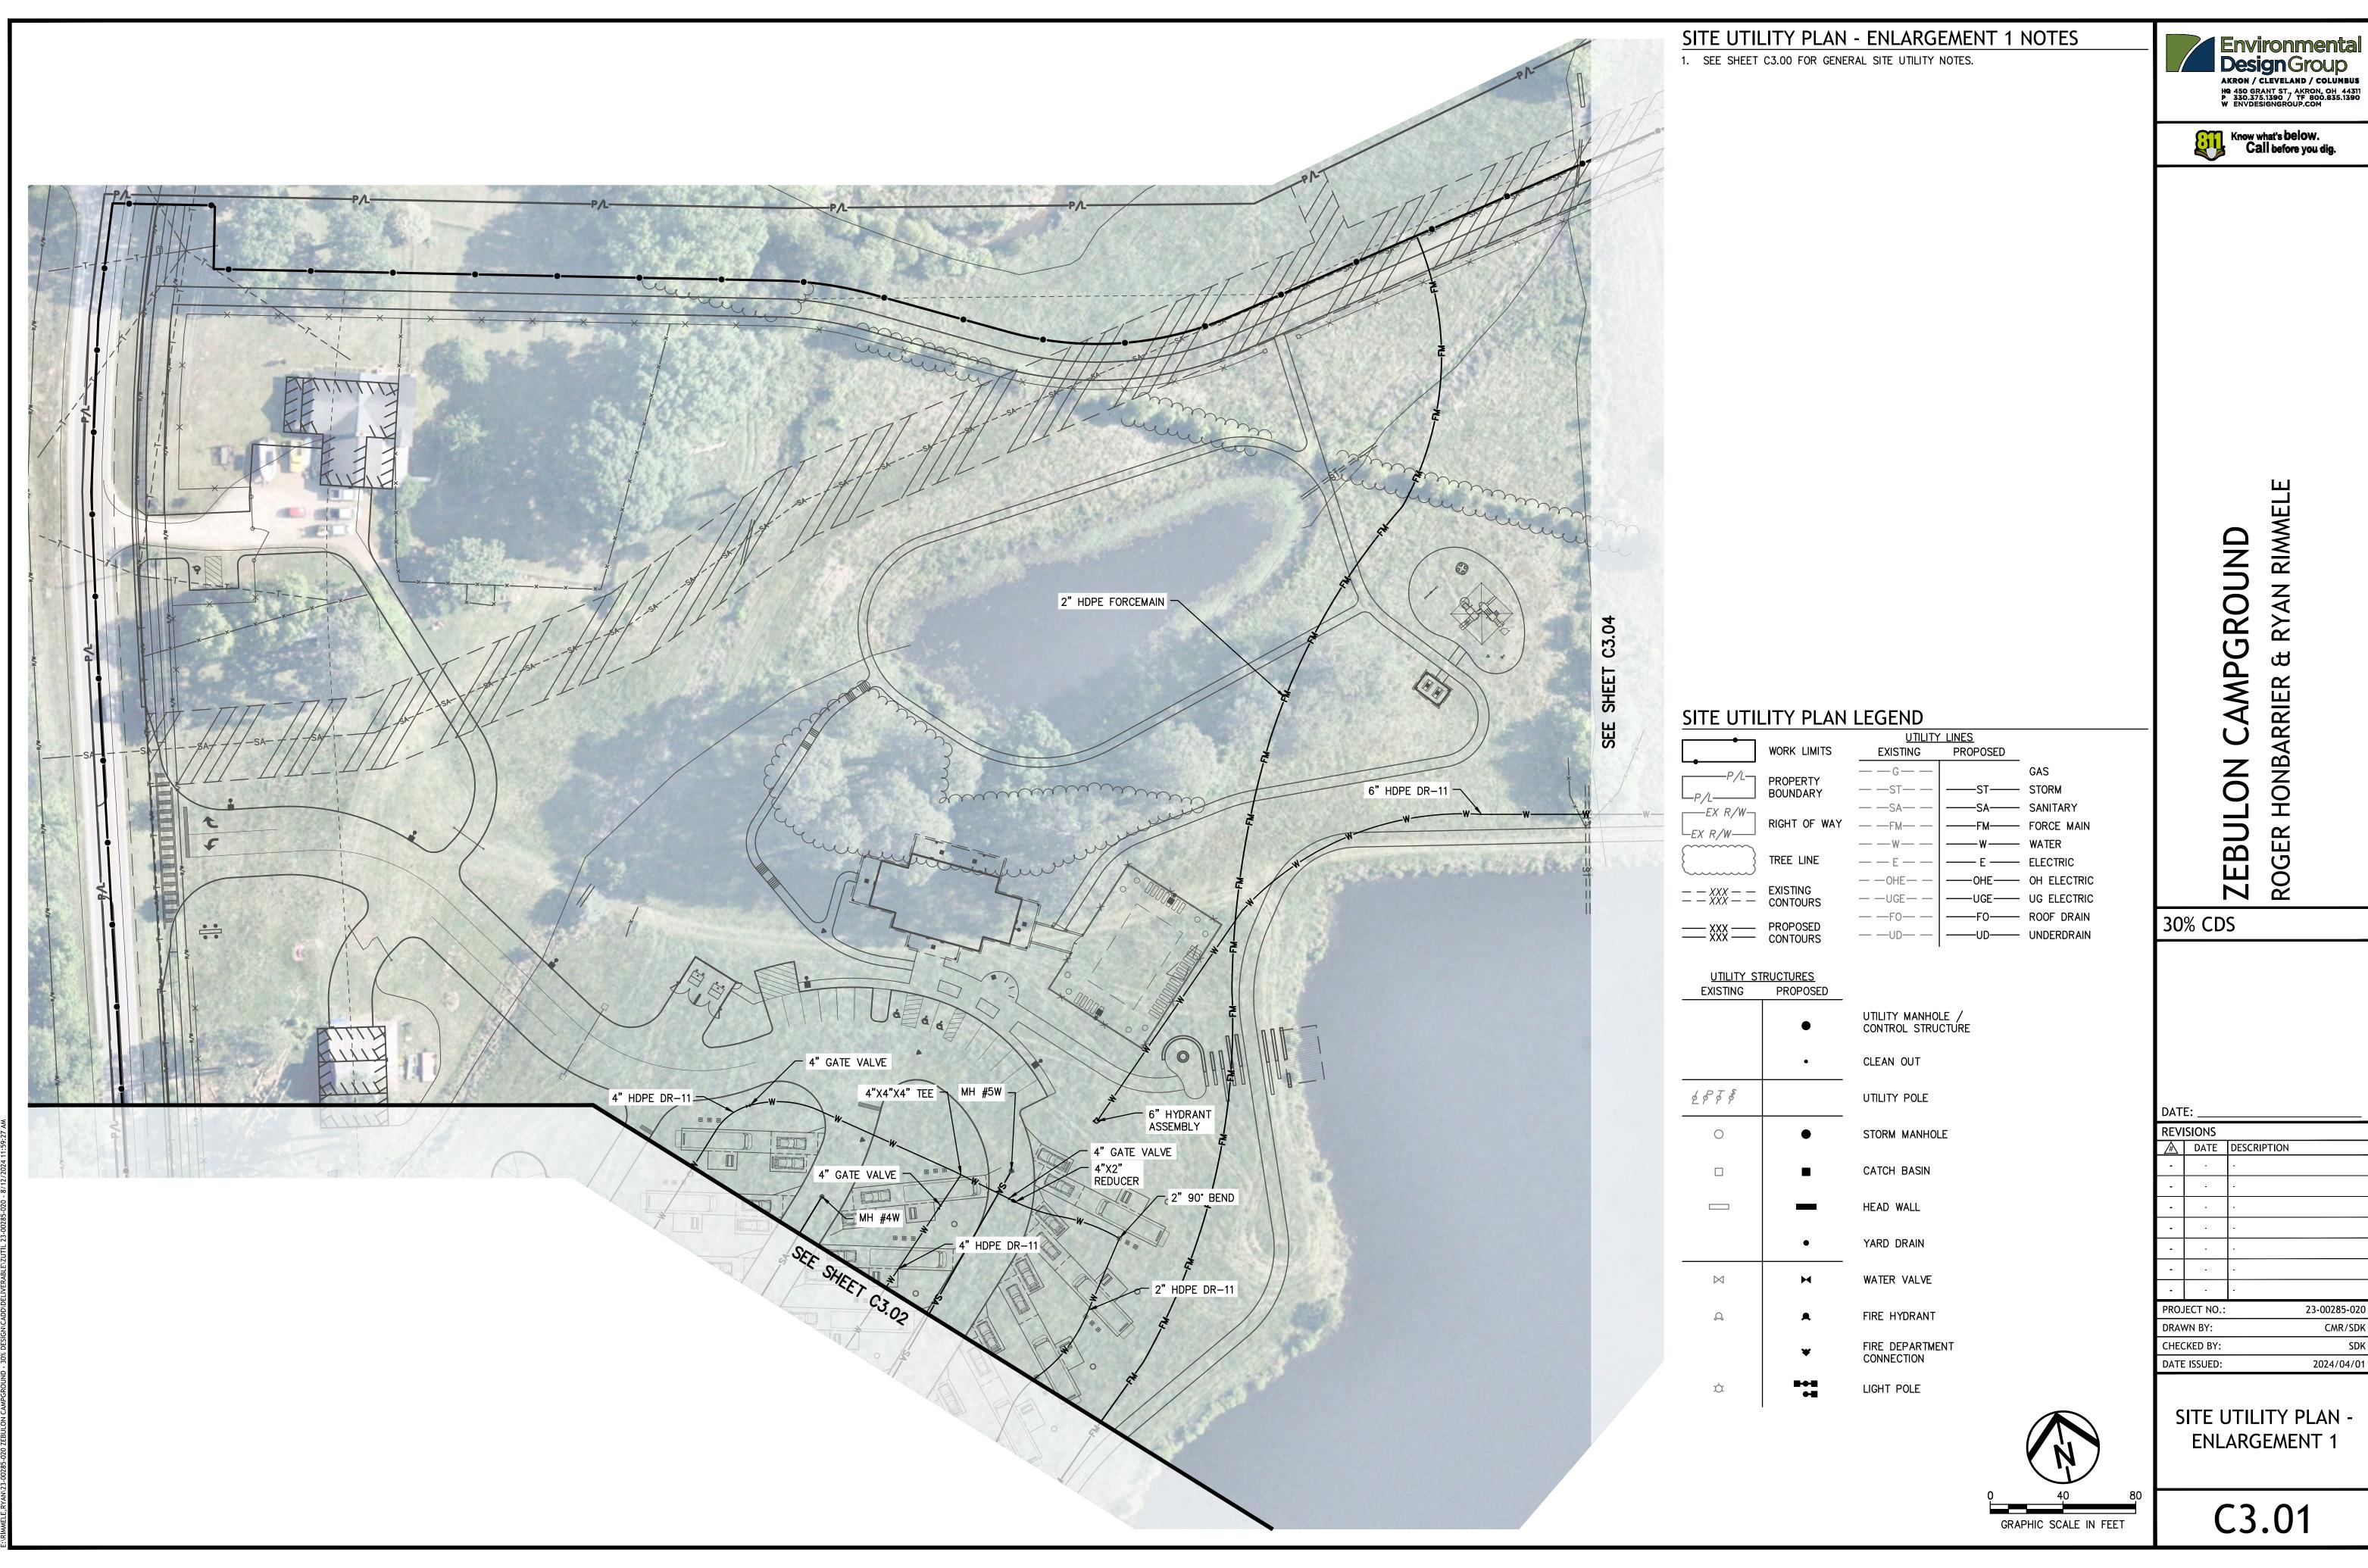
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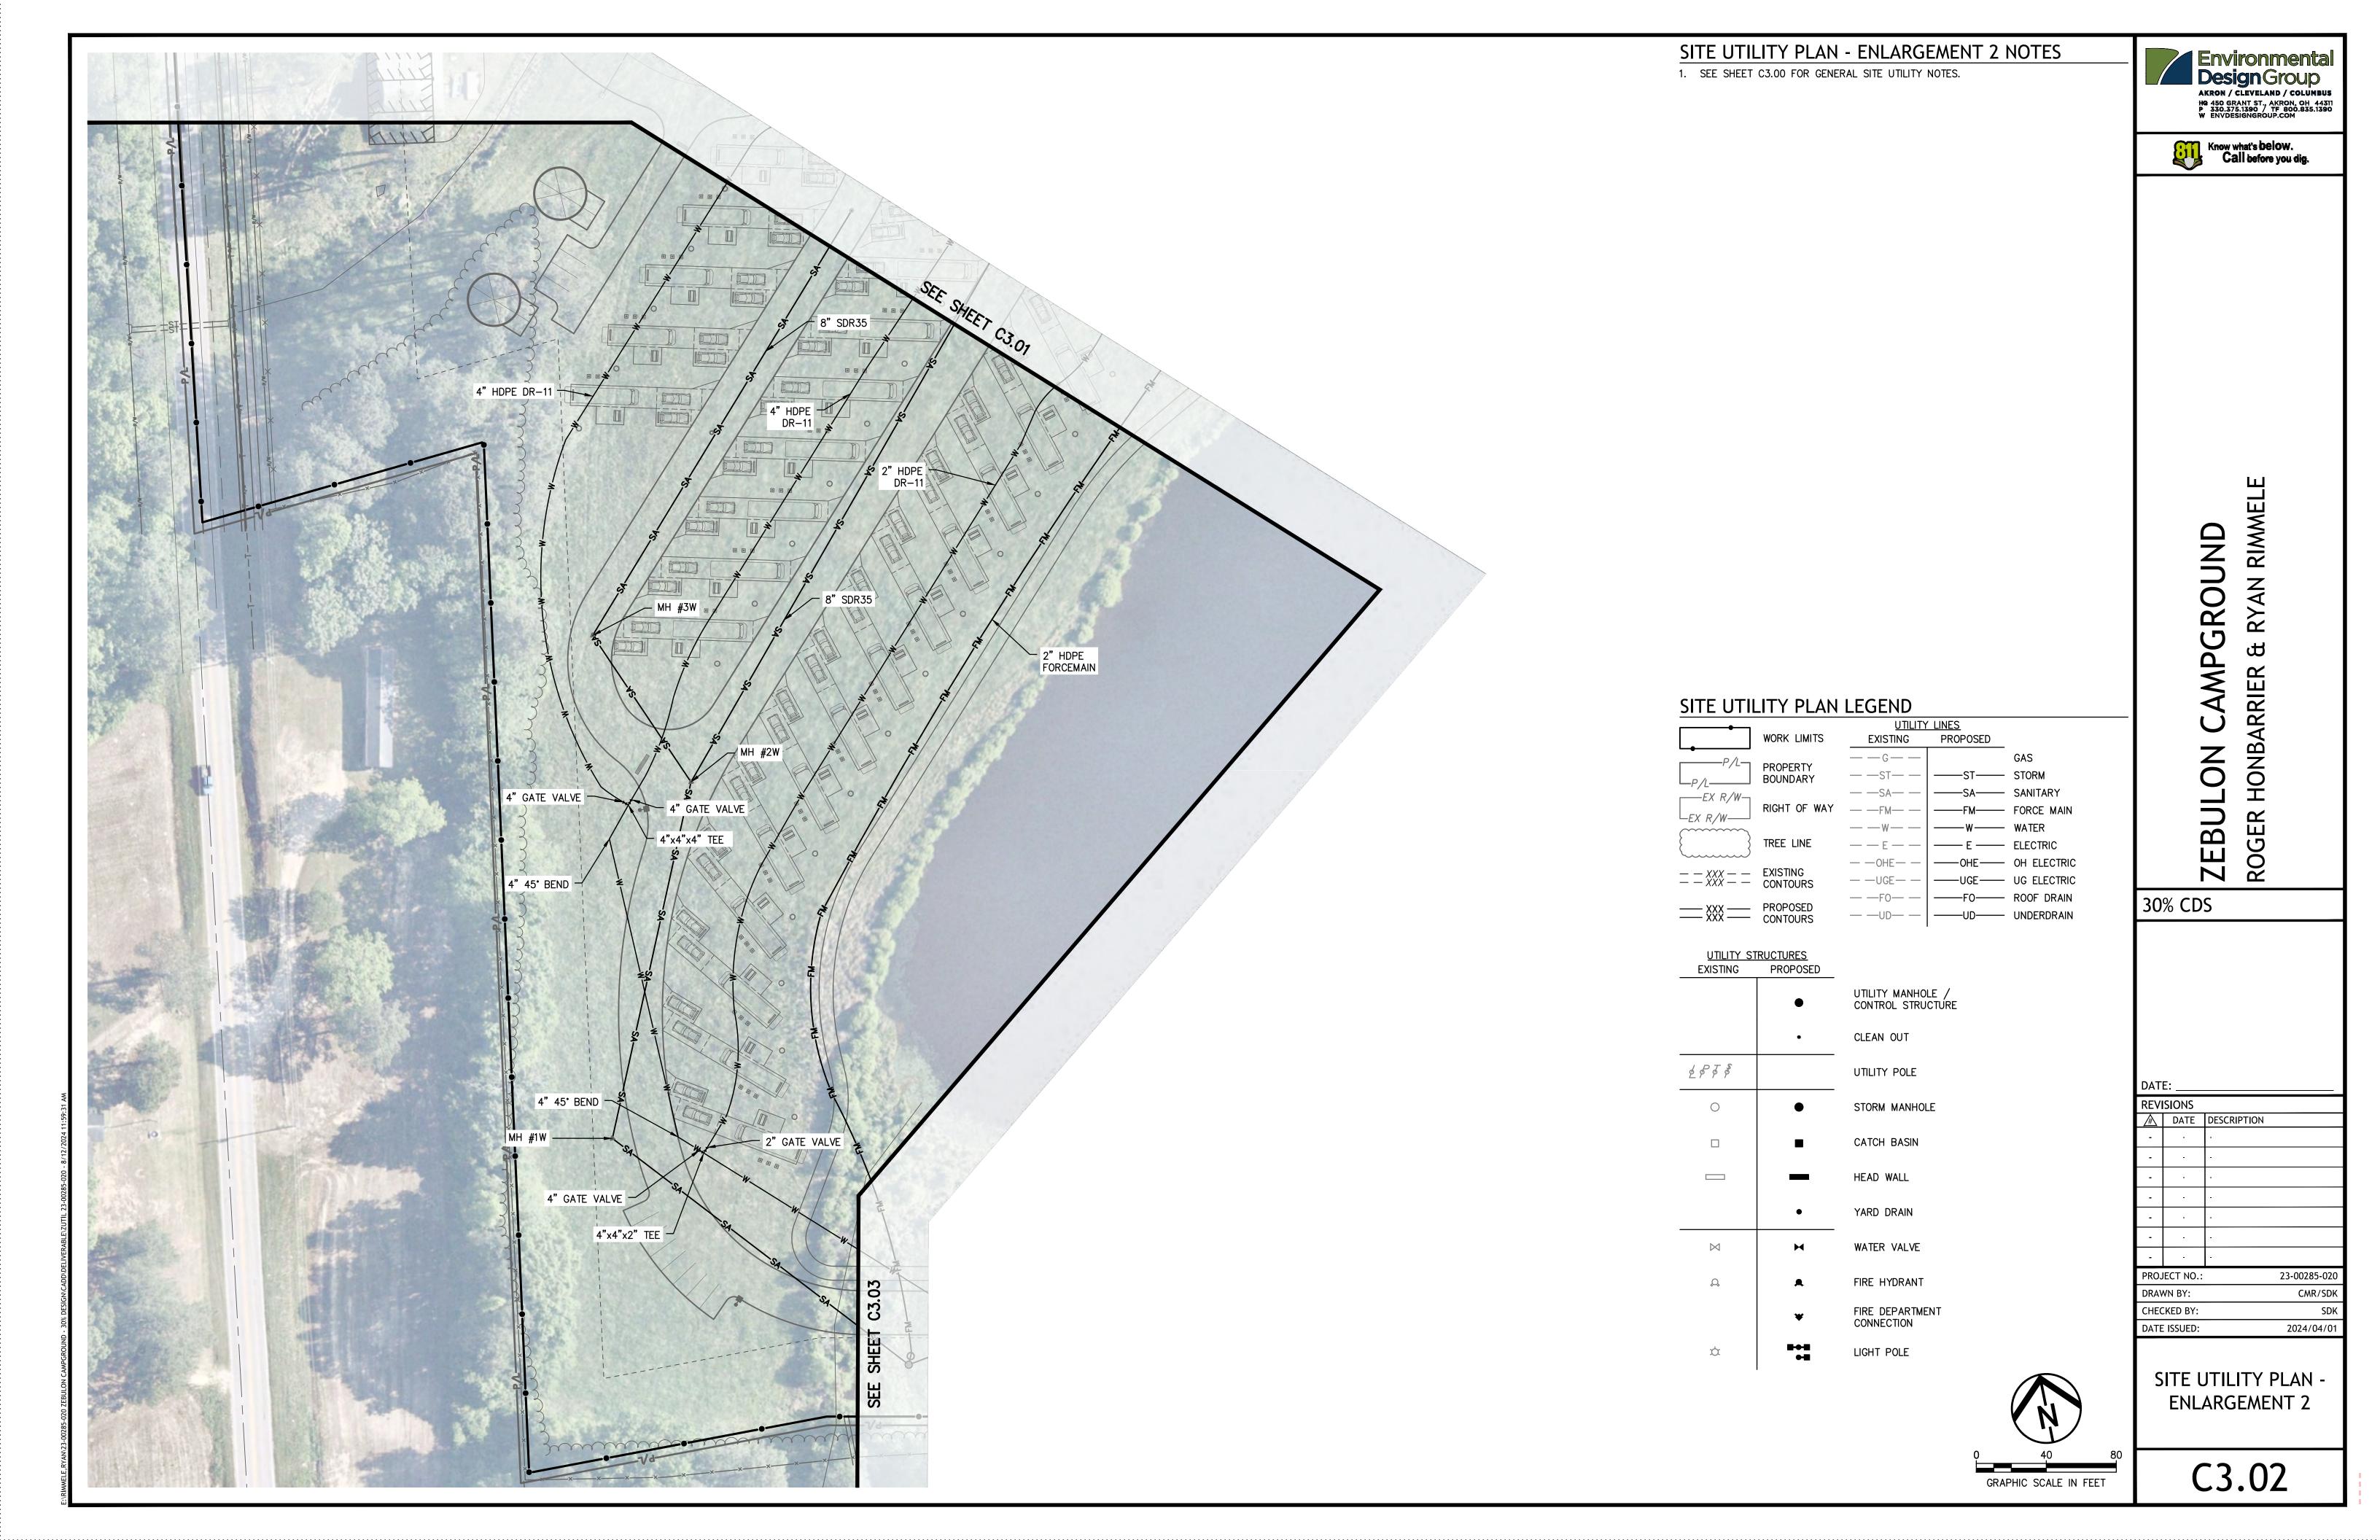
DATE ISSUED: 2024/04/01 SITE UTILITY PLAN -


**OVERALL SITE** 

CMR/SDK

C3.00





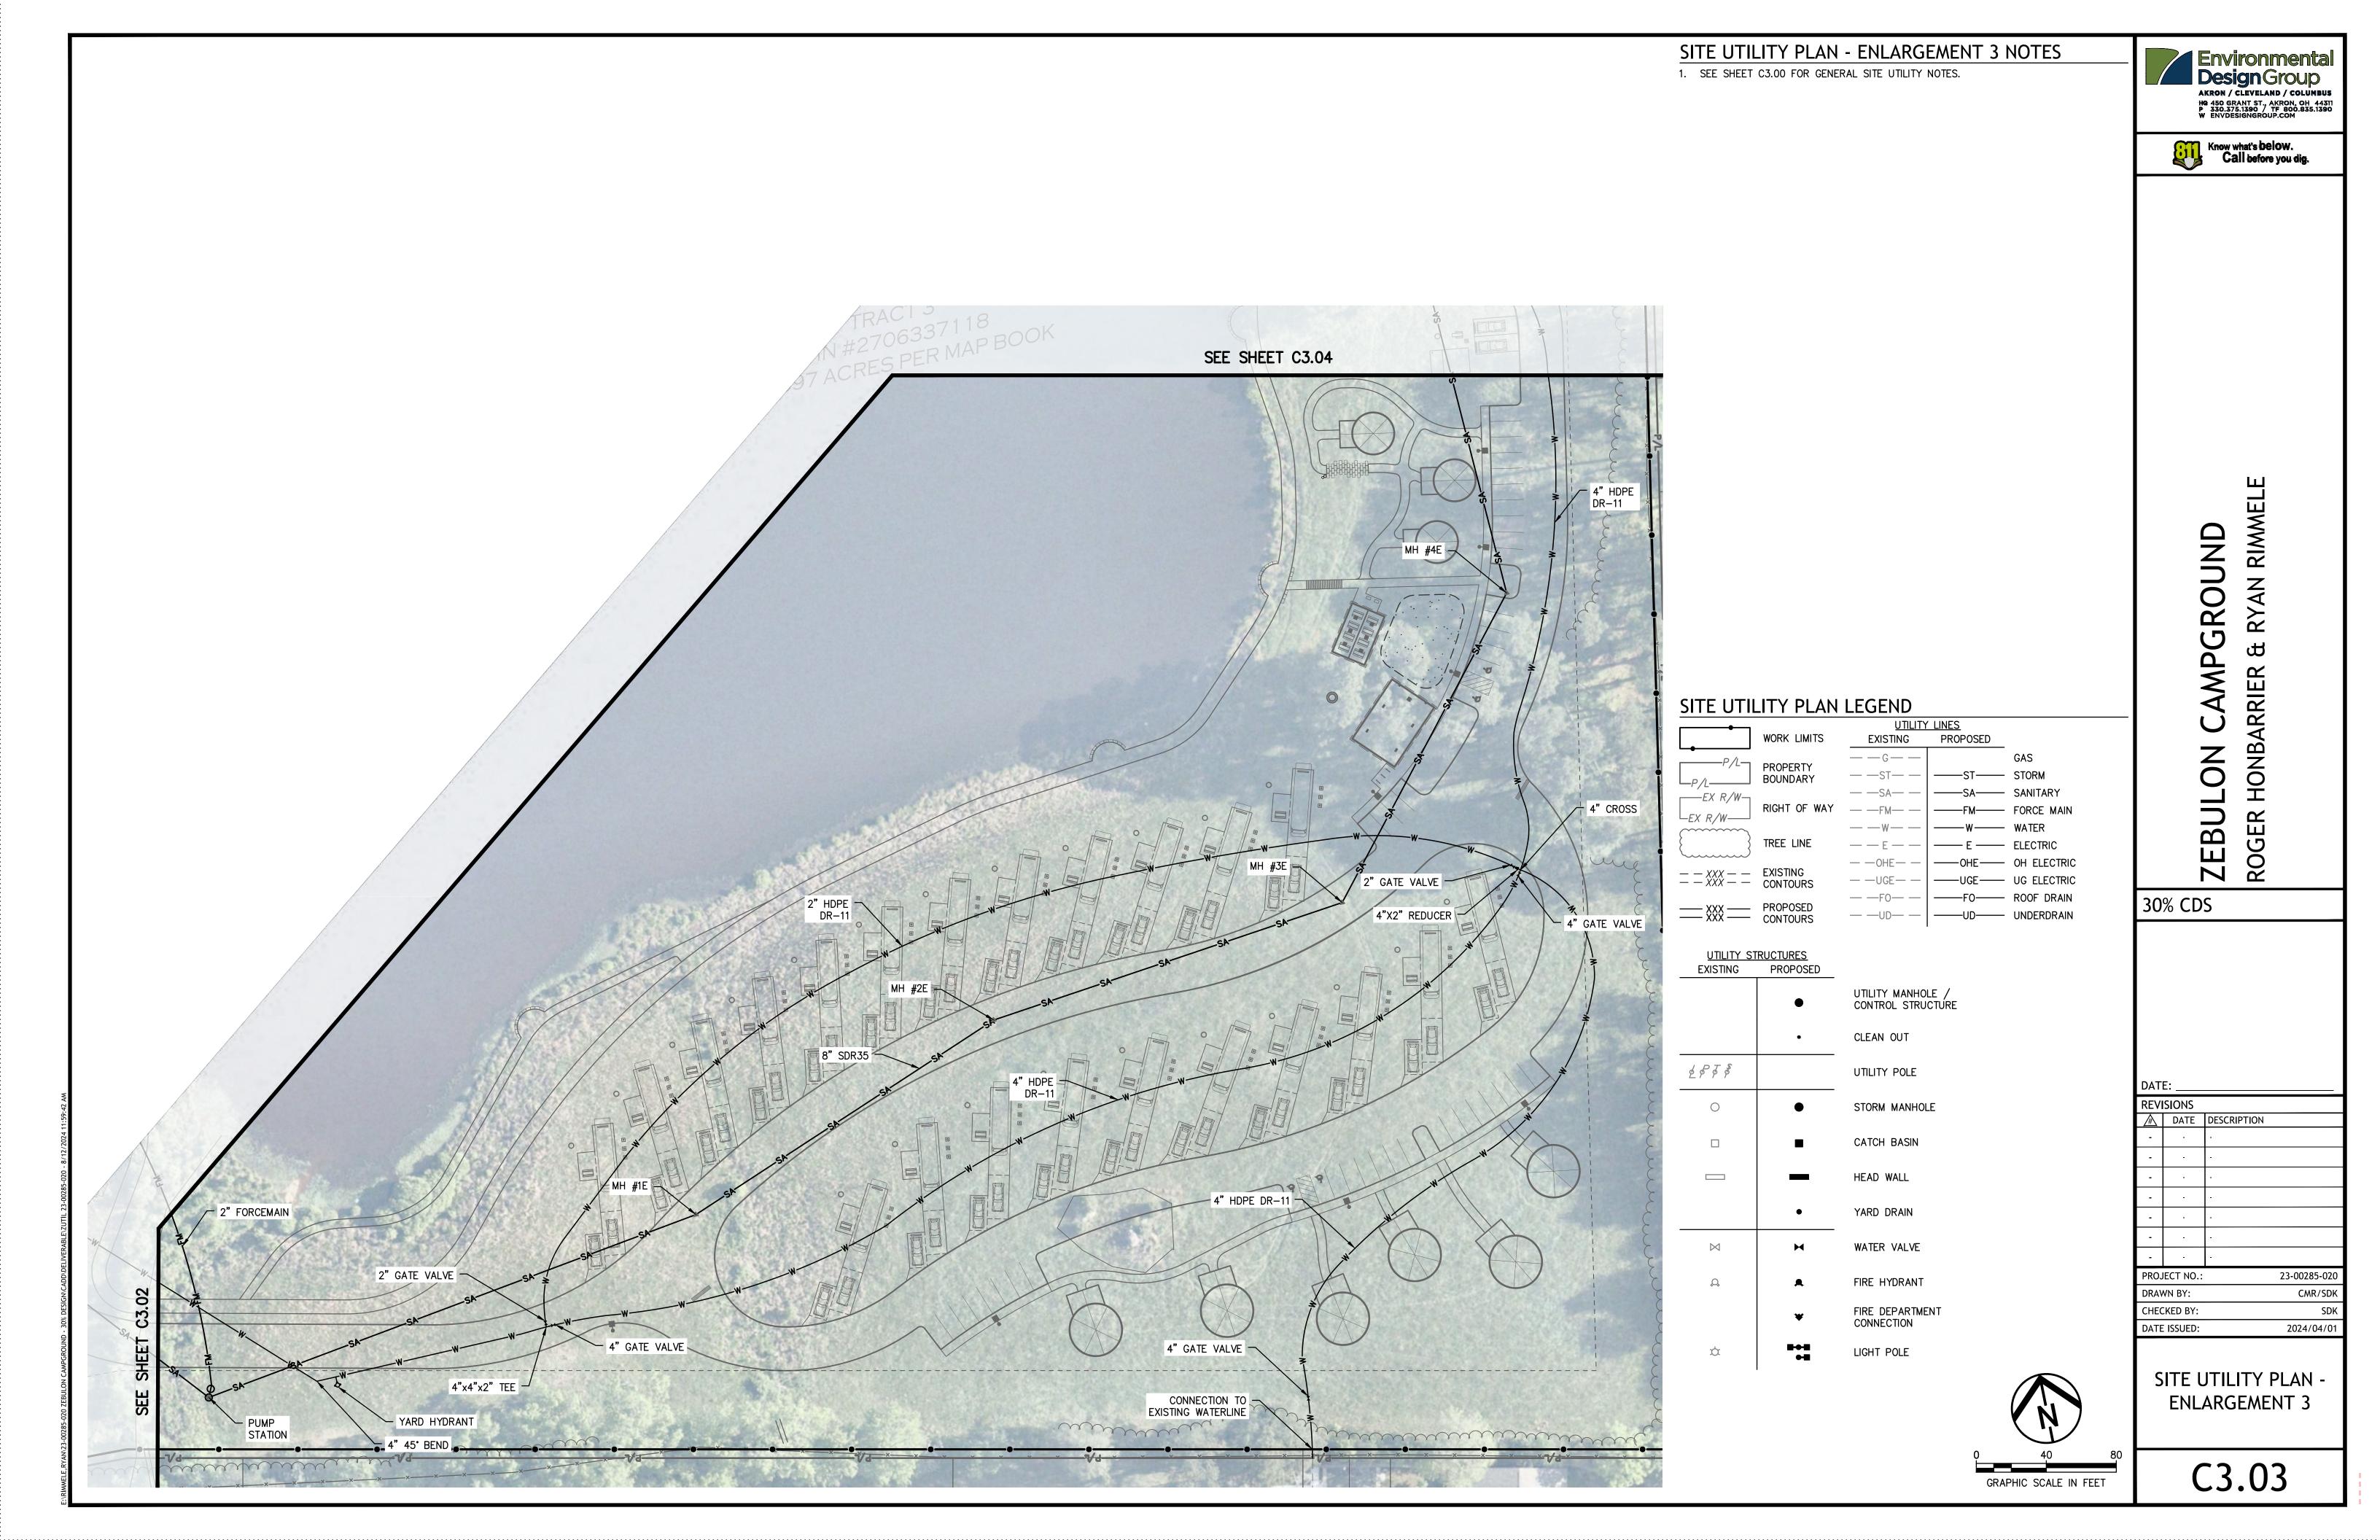



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### SIGNAGE AND PAVEMENT MARKING PLAN NOTES

. CLIENT WILL APPLY FOR THE APPROPRIATE SUBMITTALS UPON COMPLETION OF CONSTRUCTION DOCUMENTS WHICH WILL BE DEVELOPED IN ACCORDANCE WITH THE LOCAL, STATE, AND FEDERAL REQUIREMENTS.






CAMPGROUND HONBARRIER ZEBULON ROGER HONBA 30% CDS

### SIGNAGE AND PAVEMENT MARKING PLAN LEGEND


- CL CENTER LINE, DOUBLE SOLID, YELLOW
- CH CHANNELIZING LINE, 8" WHITE
- DL DIAGONAL LINE, 4" WHITE
- SL STOP LINE, WHITE, 24" WIDE
- PL PARKING LINE, WHITE, 4" WIDE
- AD RESERVED ADA PAVEMENT MARKING
- SS R1-1 STOP SIGN (24"X24")
- HC R7-8 RESERVED ADA PARKING SIGN
- PV PASSENGER VEHICLES ONLY BEYOND THIS POINT
- SD SERVICE DRIVE
- CA CAMPSITE HOST, SERVICE VEHICLES ONLY
- EV EMERGENCY VEHICLE ACCESS ONLY

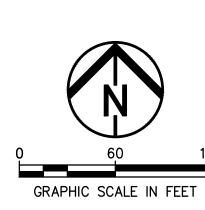


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SIGNAGE AND PAVEMENT MARKING PLAN

C4.00



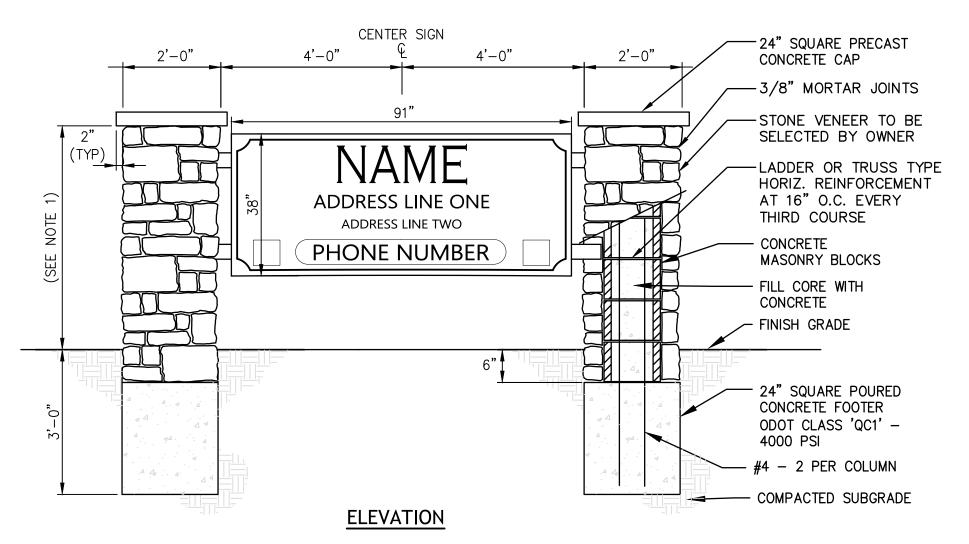

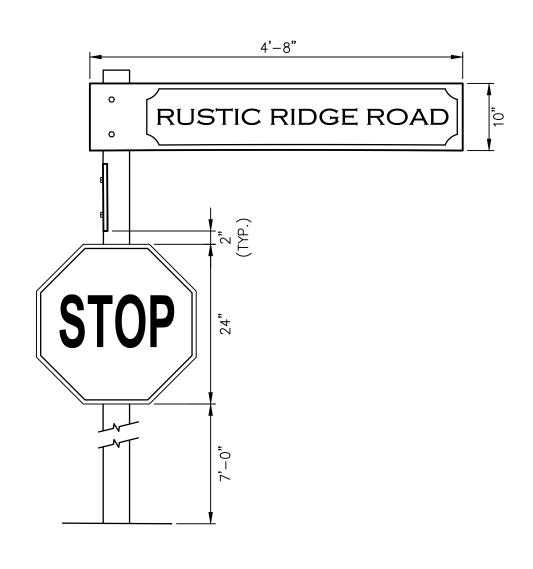

CAMPSITE HOST, SERVICET VEHICLES ONLY 3" TEXT TO EDGE OF SIGN 1" TYP. SIGN SCHEDULE C4.01 NOT TO SCALE

TYPICAL SIGN FACE

18"

NOTES:

1. DESIGN OF SIGNS TO BE CONFIRMED AT A LATER DATE. DIMENSIONS AND LOCATION FROM MINIMUM SETBACK TO ALIGN WITH OTHER NEIGHBORHOOD SIGNS

4"x 6"x - 8'-6" WOOD POST BURY

3'-6" DEEP

3'-6" DEEP

-FINISH GRADE

IN THE AREA.

2. THE CLIENT WILL APPLY FOR THE APPROPRIATE SUBMITTALS UPON COMPLETION OF CONSTRUCTION DOCUMENTS WHICH WILL BE DEVELOPED IN ACCORDANCE WITH THE LOCAL, STATE, AND FEDERAL REQUIREMENT.

TYPICAL SIGN FACE

SINGLE POST

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NOTES:

1. SEE SITE LAYOUT PLAN
FOR SIGN LOCATIONS
PERTAINING TO THIS

. SIGN A, C, & D SHALL BE SINGLE POST

LOCATED MINIMUM 3'

OFF PAVEMENT EDGE.

LOCATIONS TO BE FIELD

INSTALLATION ALL SIGNS

FINISH GRADE

COMPACTED SUBGRADE

SCHEDULE.

DESIGN. 3. ALL SIGNS TO BE

VERIFIED.

4. TYPICAL POST



CAMPGROUND & RYAN HONBARRIER ( ZEBULON (
ROGER HONBA
RIMMELE


30% CDS				
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SIGNAGE AND PAVEMENT MARKING PLAN DETAILS

C4.01

**ENTRY MONUMENT SIGN** C4.01 NOT TO SCALE



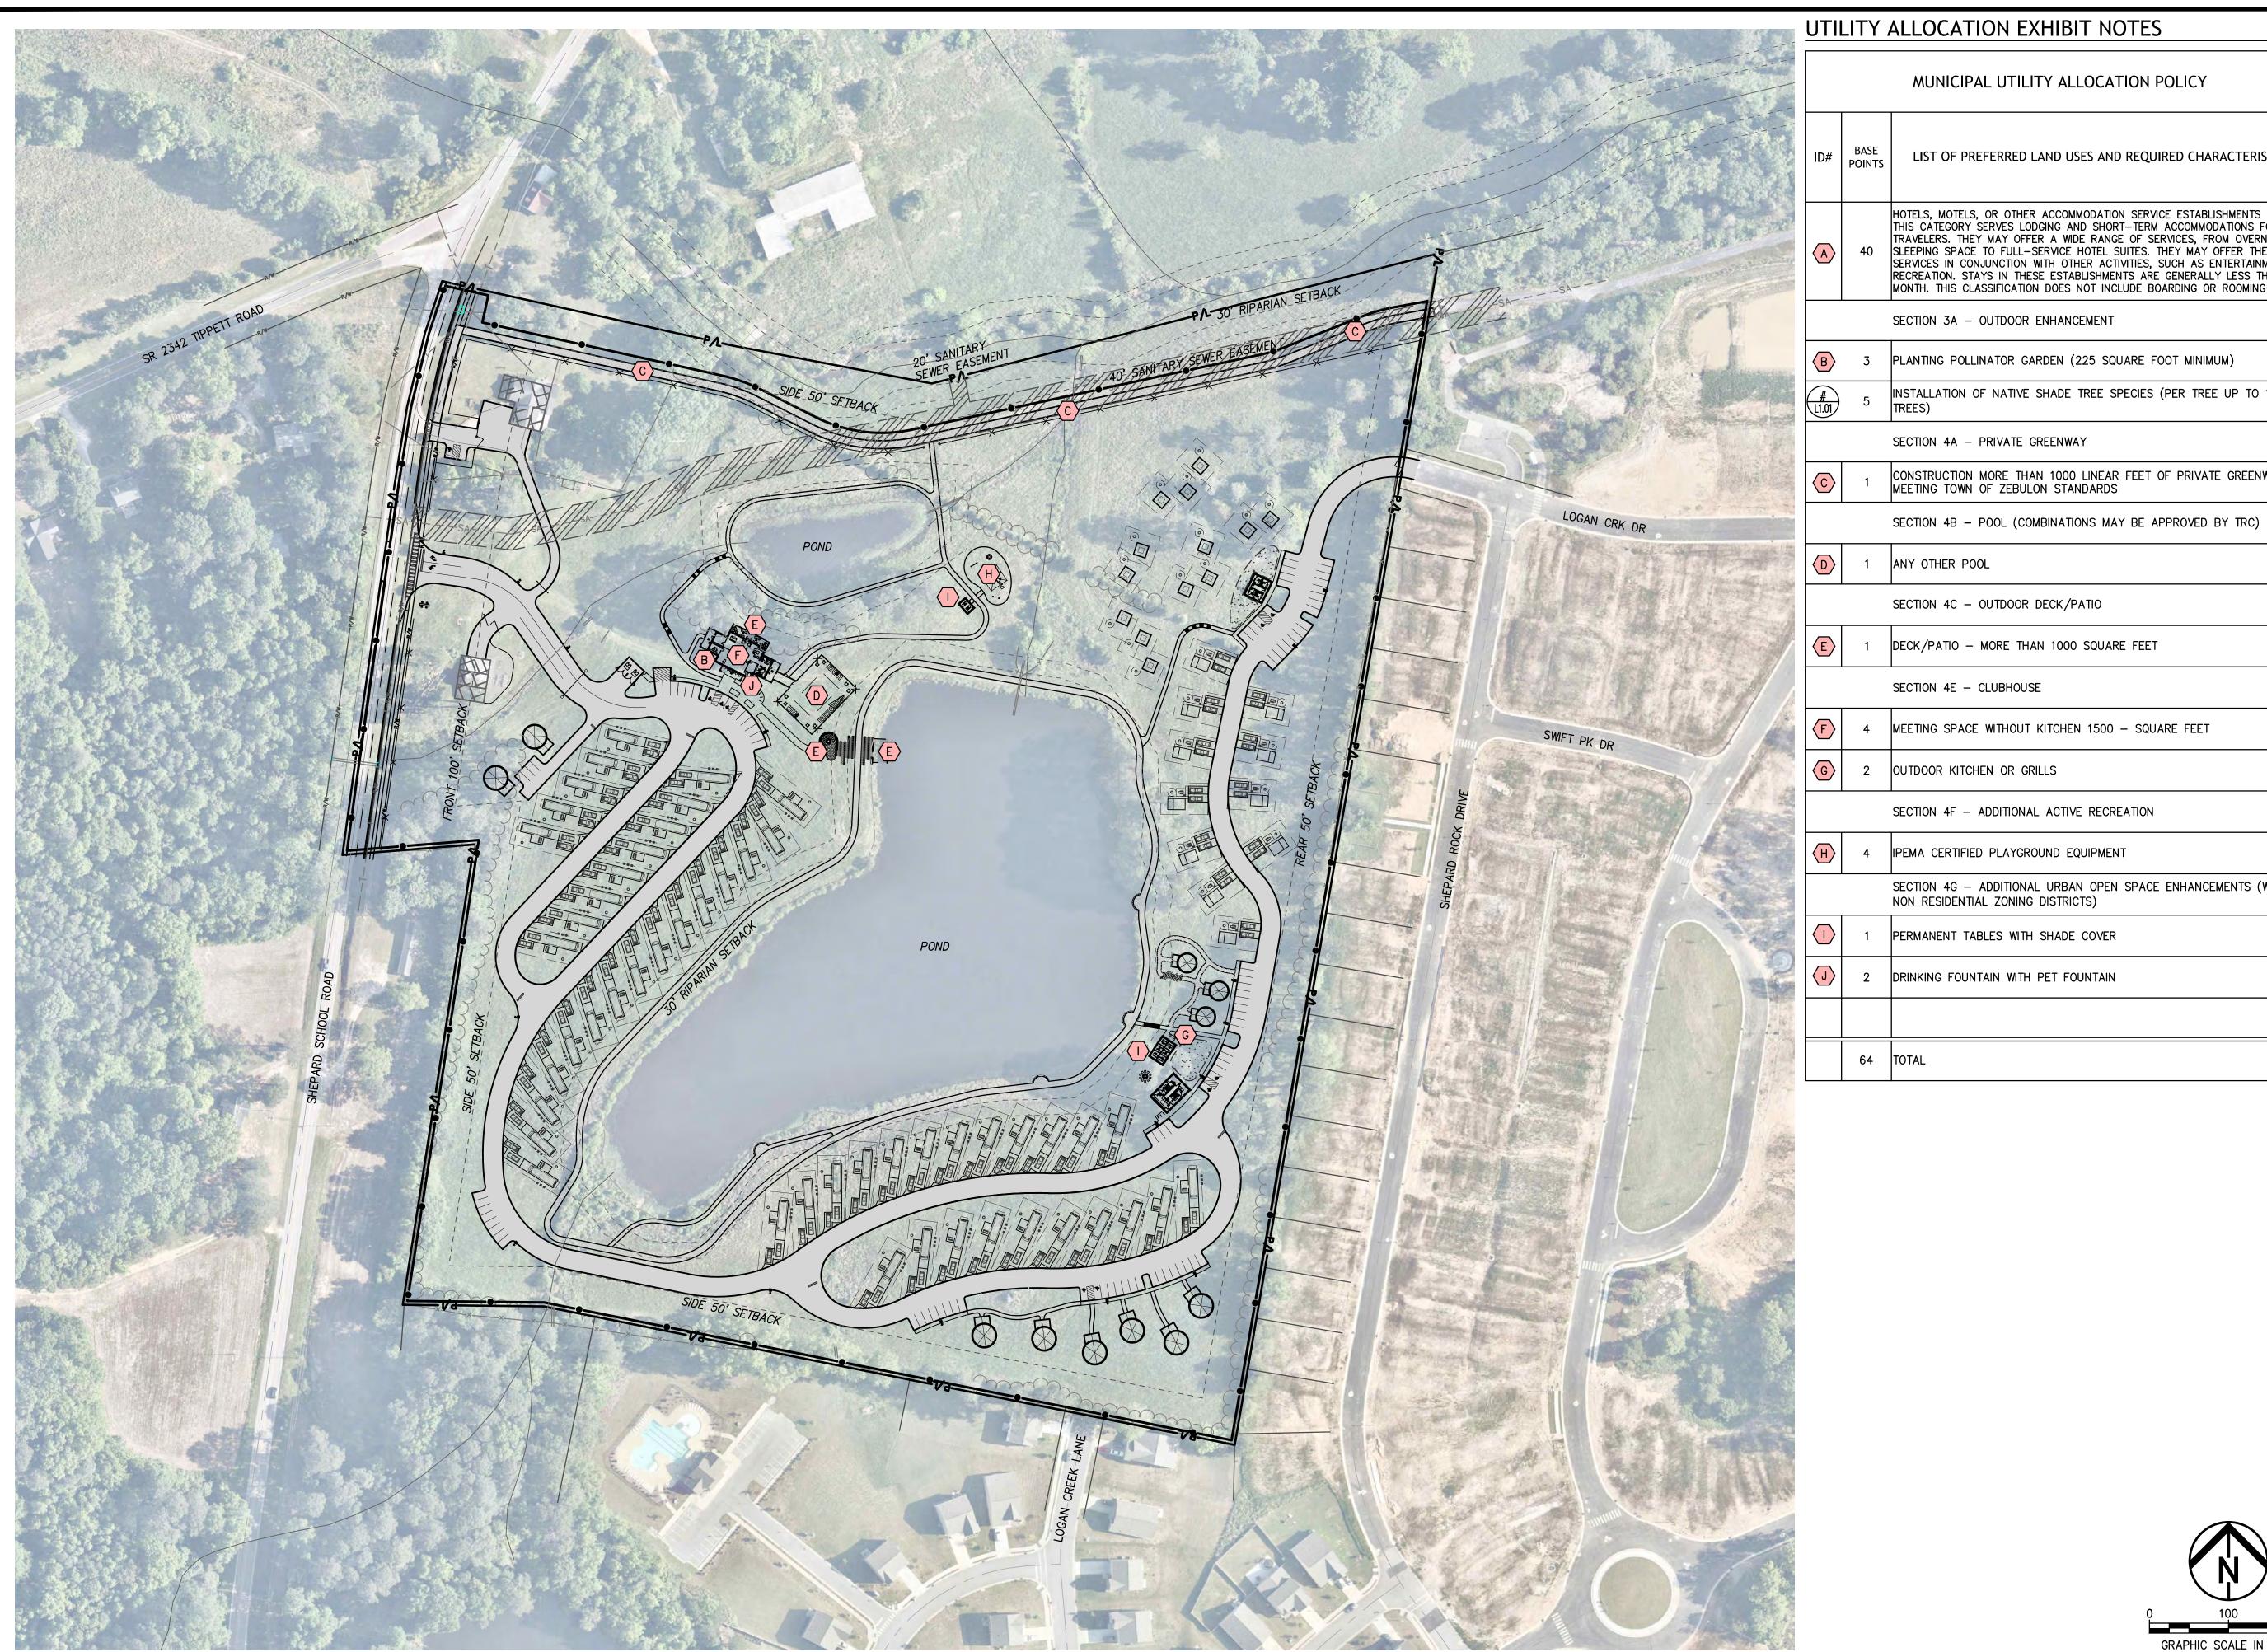

UTILITY ALLOCATION EXHIBIT NOTES

MUNICIPAL UTILITY ALLOCATION POLICY

LIST OF PREFERRED LAND USES AND REQUIRED CHARACTERISTICS

THIS CATEGORY SERVES LODGING AND SHORT-TERM ACCOMMODATIONS FOR TRAVELERS. THEY MAY OFFER A WIDE RANGE OF SERVICES, FROM OVERNIGHT SLEEPING SPACE TO FULL-SERVICE HOTEL SUITES. THEY MAY OFFER THESE SERVICES IN CONJUNCTION WITH OTHER ACTIVITIES, SUCH AS ENTERTAINMENT OR RECREATION. STAYS IN THESE ESTABLISHMENTS ARE GENERALLY LESS THAN ONE MONTH. THIS CLASSIFICATION DOES NOT INCLUDE BOARDING OR ROOMING HOUSES.

SECTION 3A - OUTDOOR ENHANCEMENT

PLANTING POLLINATOR GARDEN (225 SQUARE FOOT MINIMUM)

INSTALLATION OF NATIVE SHADE TREE SPECIES (PER TREE UP TO 10

SECTION 4A - PRIVATE GREENWAY

CONSTRUCTION MORE THAN 1000 LINEAR FEET OF PRIVATE GREENWAY MEETING TOWN OF ZEBULON STANDARDS

SECTION 4B - POOL (COMBINATIONS MAY BE APPROVED BY TRC)

ANY OTHER POOL

SECTION 4C - OUTDOOR DECK/PATIO

DECK/PATIO - MORE THAN 1000 SQUARE FEET

SECTION 4E - CLUBHOUSE

MEETING SPACE WITHOUT KITCHEN 1500 - SQUARE FEET

2 OUTDOOR KITCHEN OR GRILLS

SECTION 4F - ADDITIONAL ACTIVE RECREATION

IPEMA CERTIFIED PLAYGROUND EQUIPMENT

SECTION 4G - ADDITIONAL URBAN OPEN SPACE ENHANCEMENTS (WITHIN NON RESIDENTIAL ZONING DISTRICTS)

PERMANENT TABLES WITH SHADE COVER

2 DRINKING FOUNTAIN WITH PET FOUNTAIN

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RIWMEL CAMPGROUND HONBARRIER NO. ZEBUL( 30% CDS

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**REVISIONS** 


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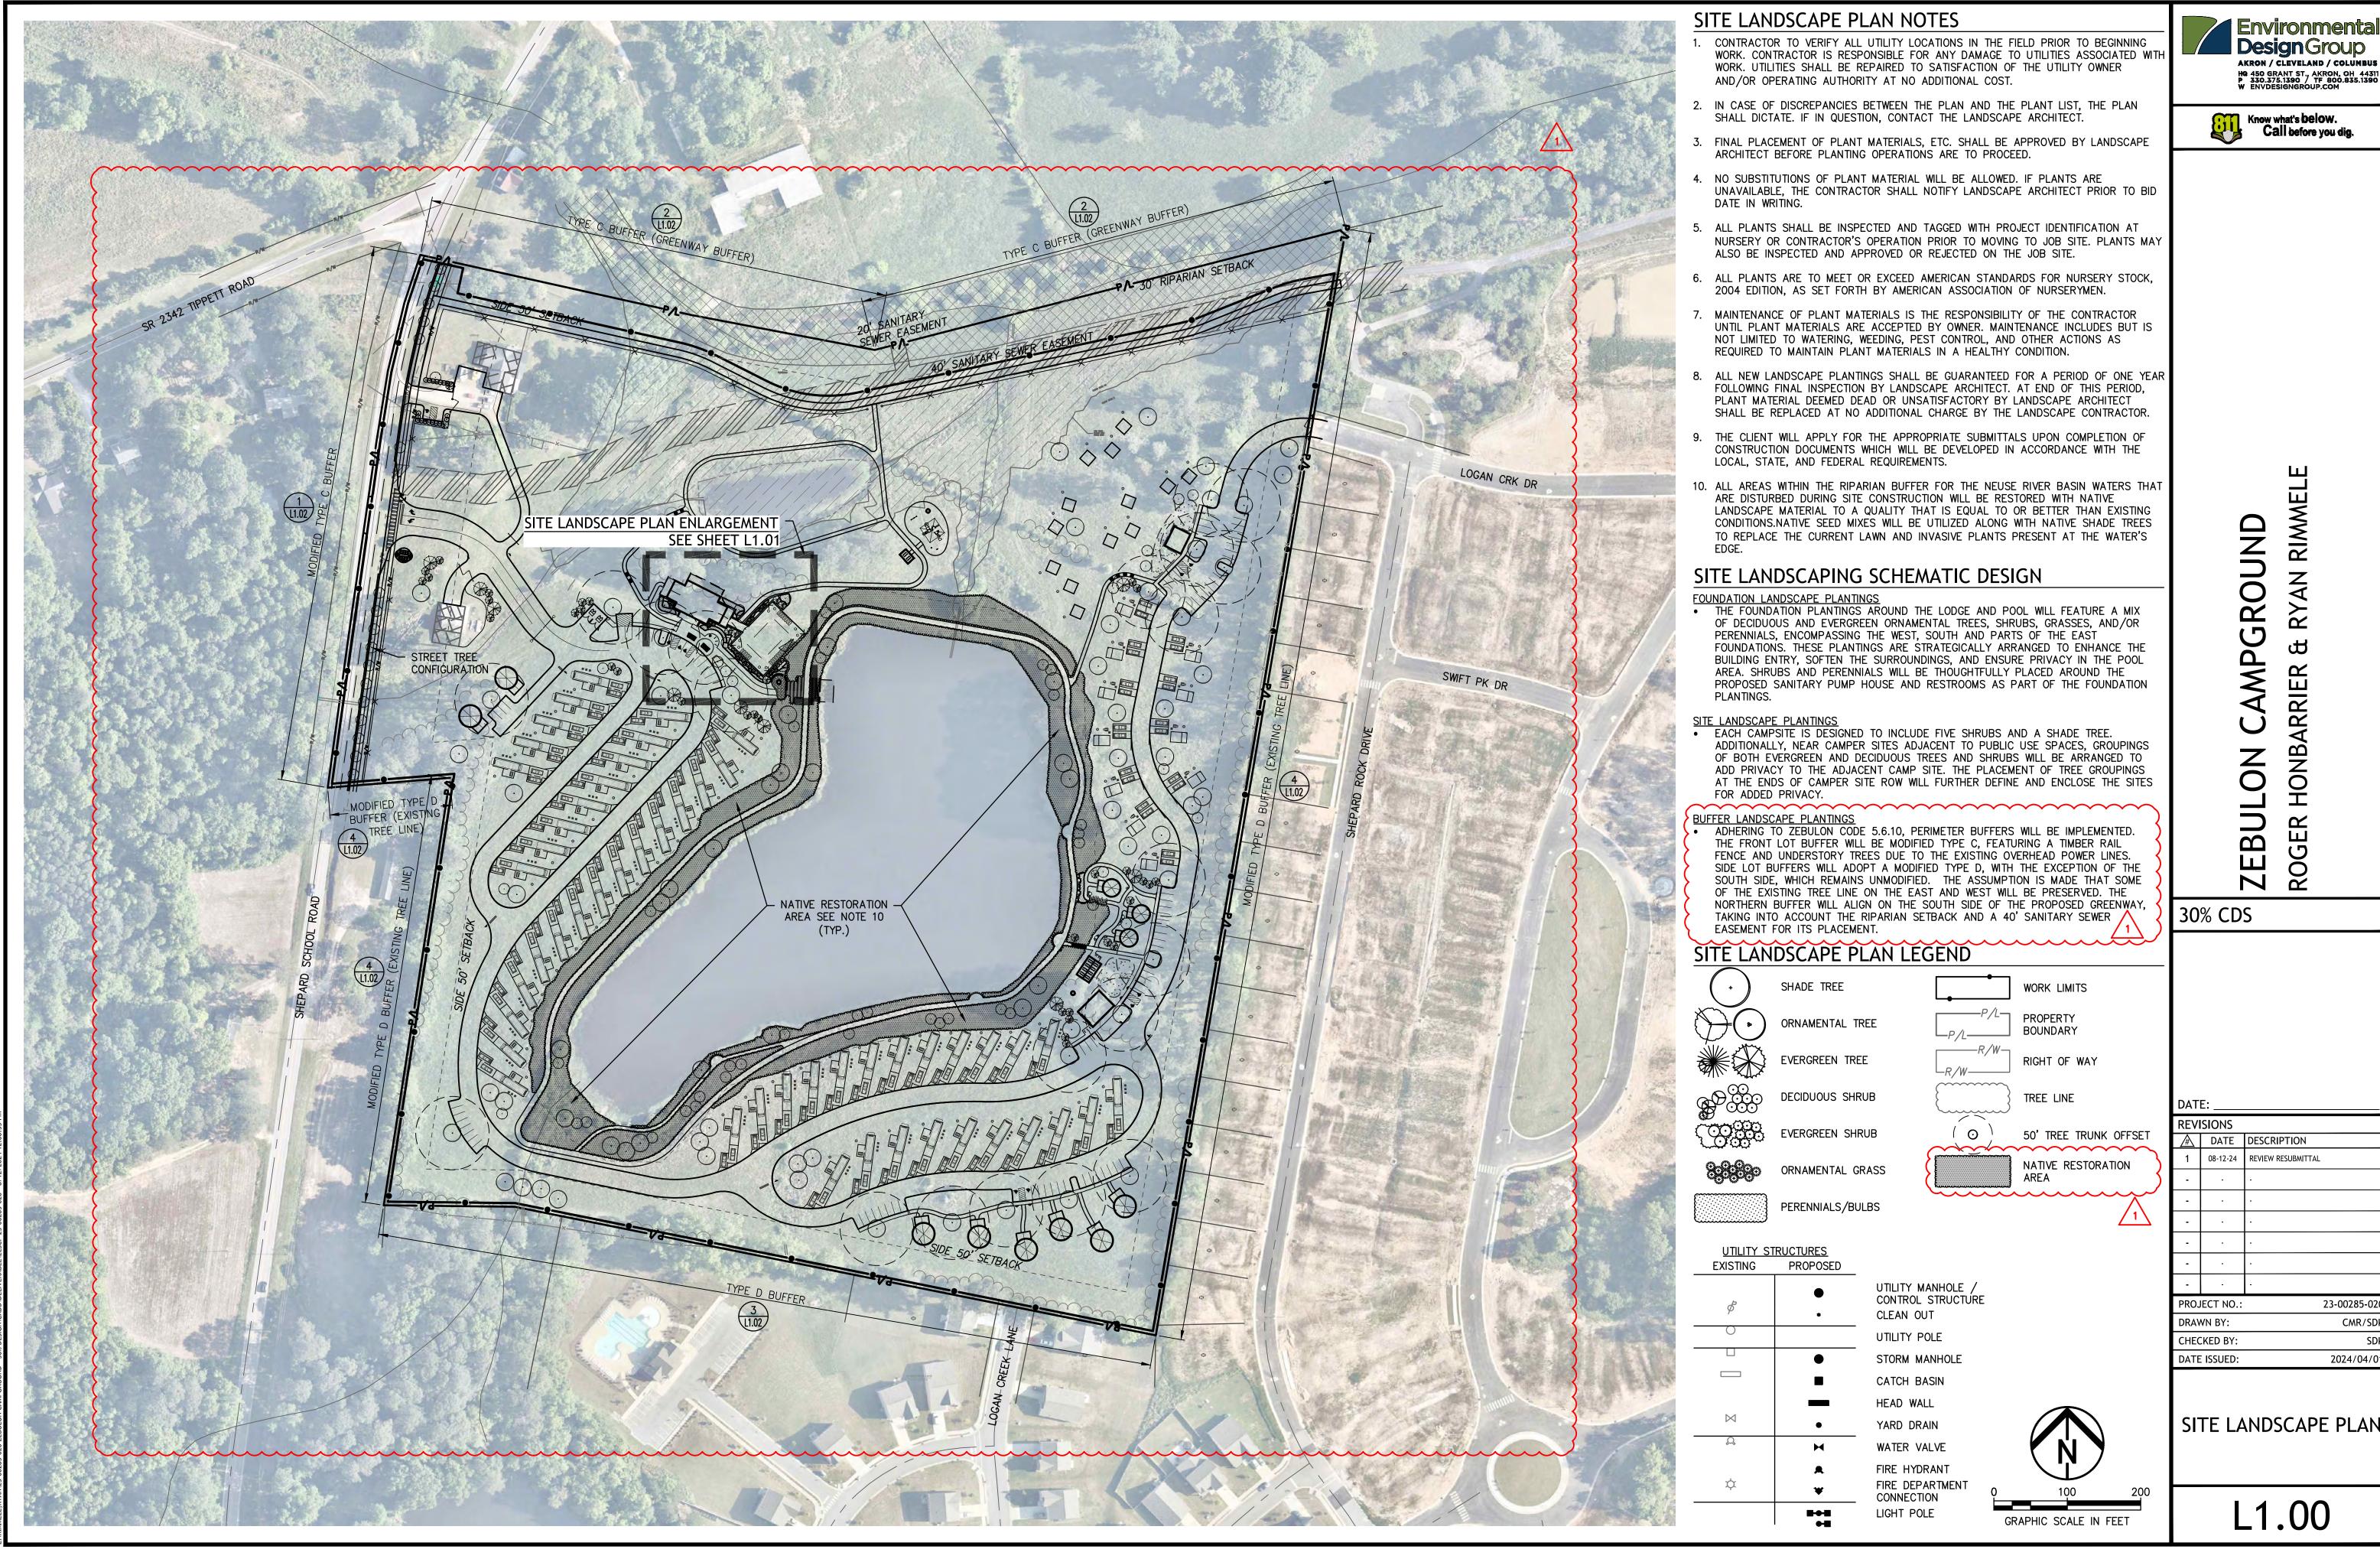
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UTILITY ALLOCATION **EXHIBIT** 

2024/04/01

C5.00



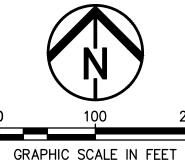



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23-00285-020 CMR/SDK 2024/04/01

SITE LANDSCAPE PLAN



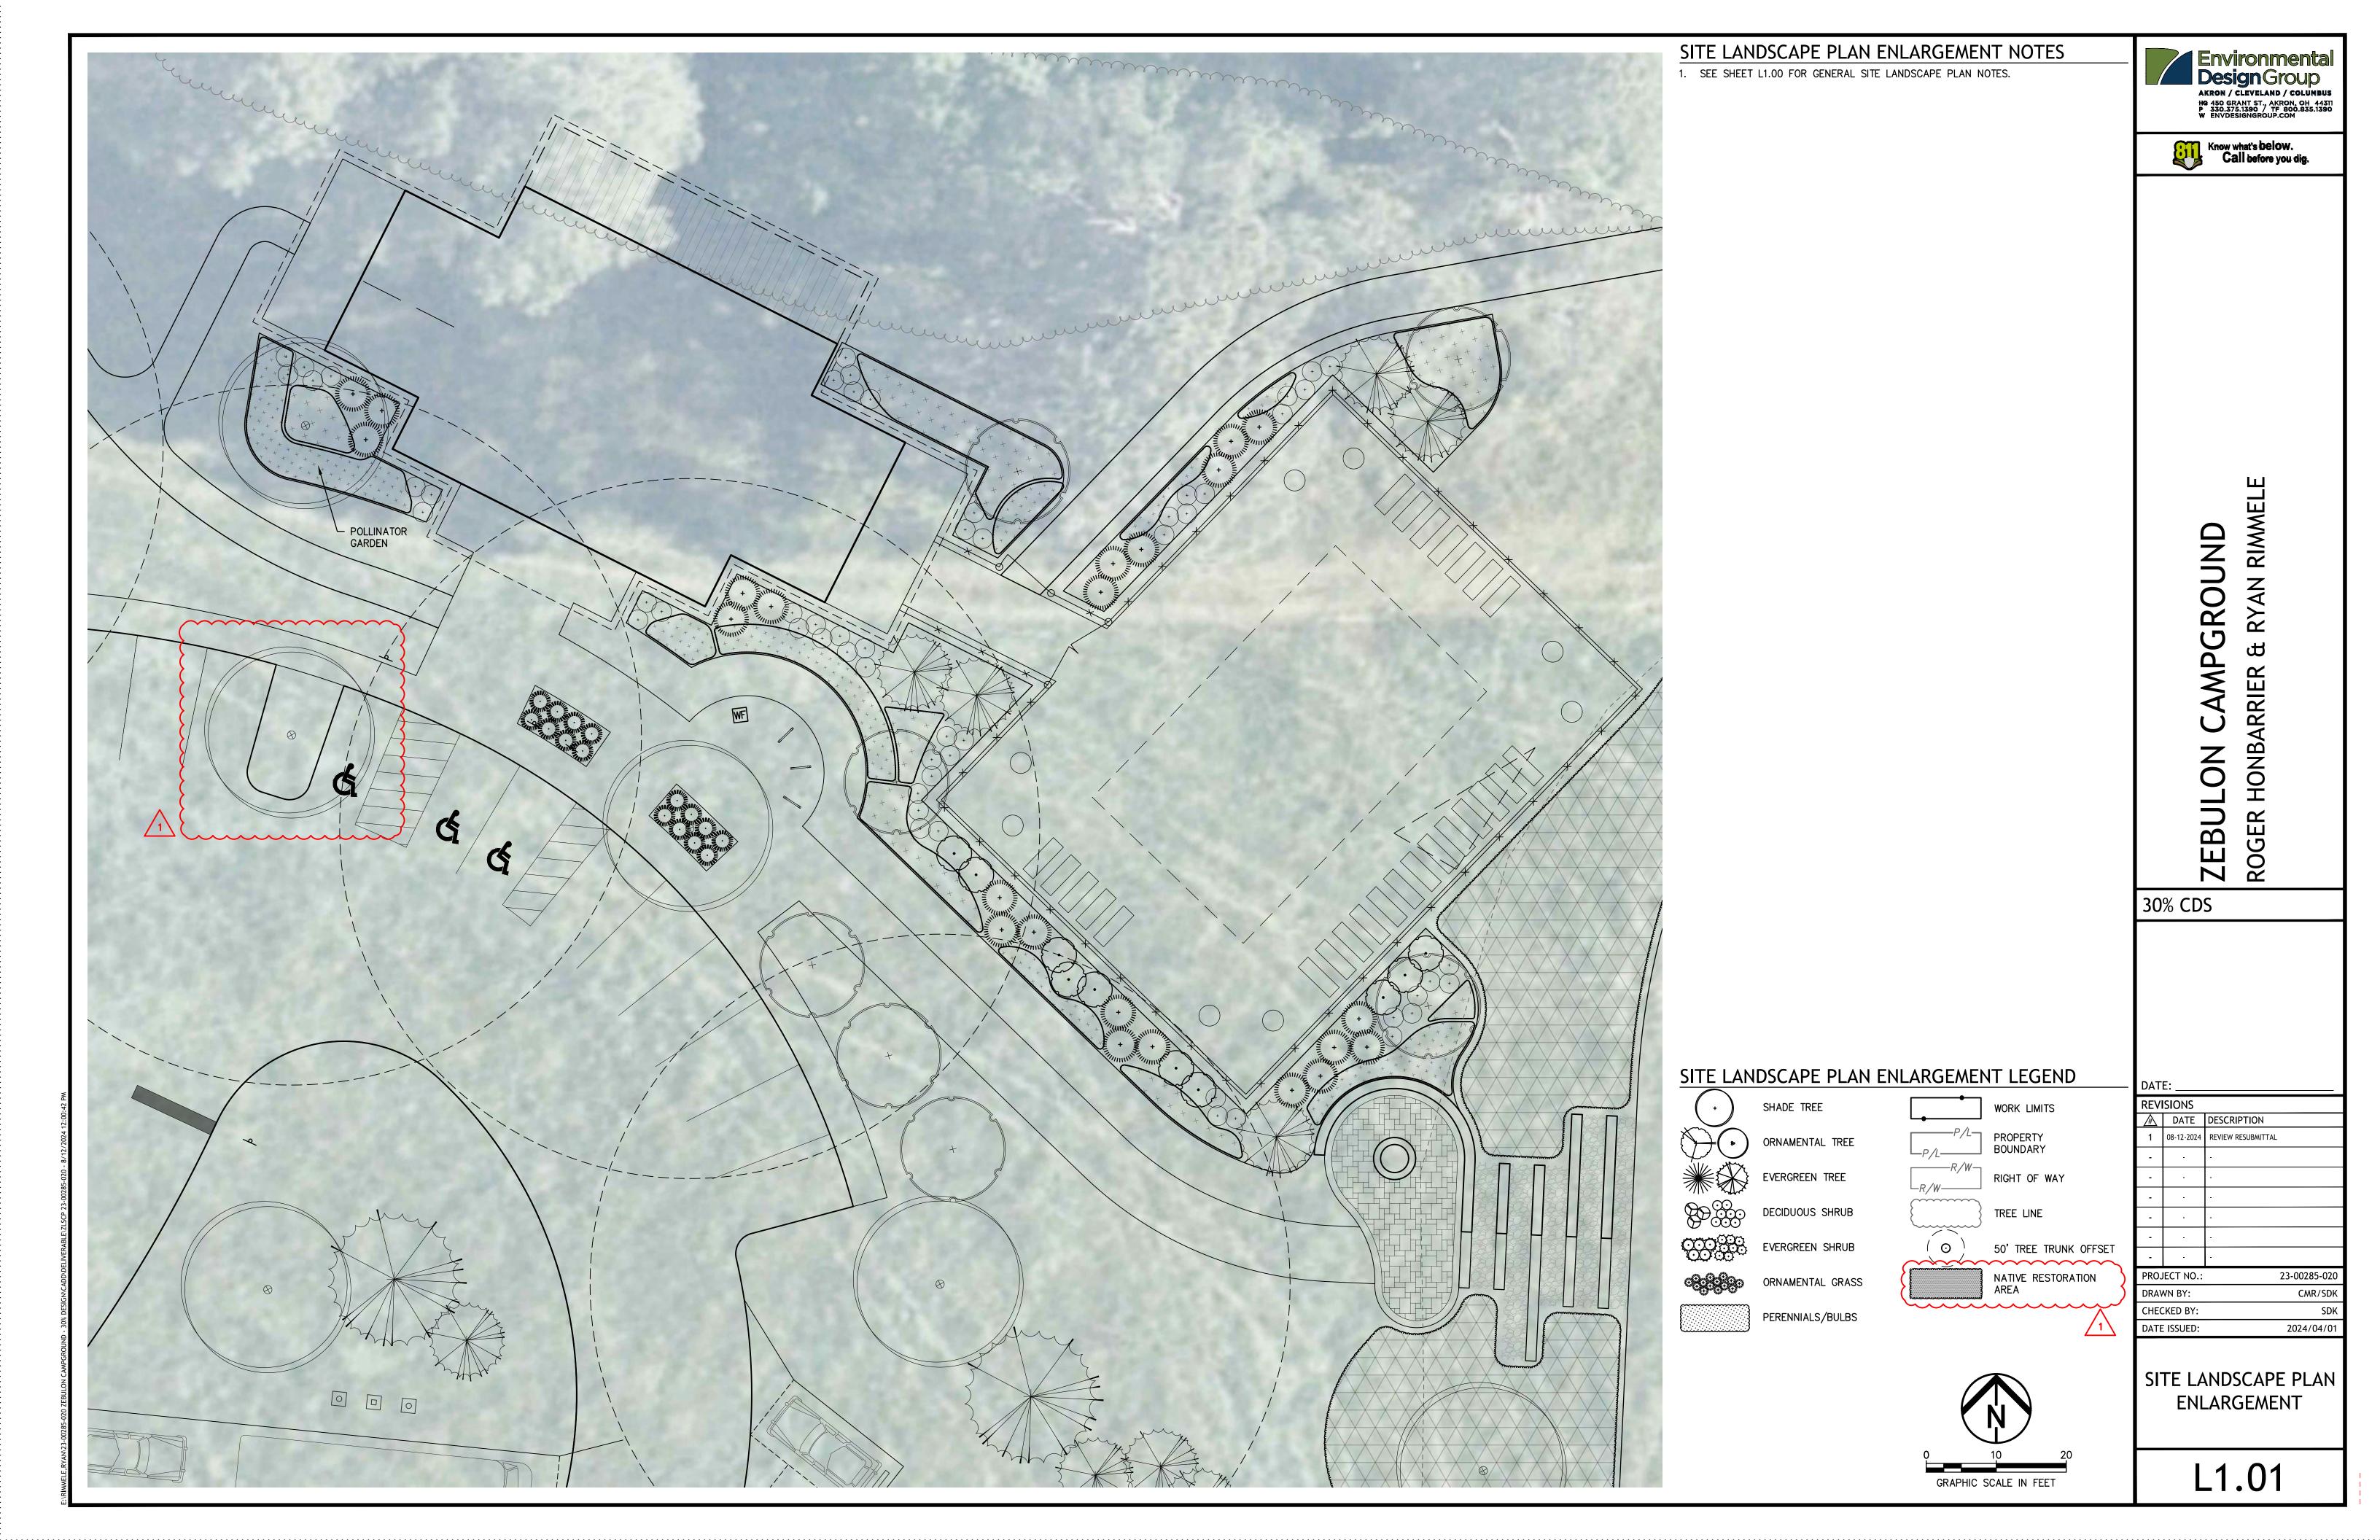


\*MODIFIED BUFFER C ALONG SHEPARD SCHOOL ROAD DUE TO OVERHEAD POWER LINES REFER TO 5.612
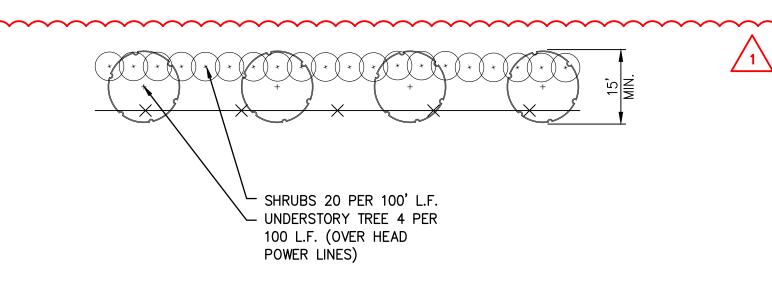
# $\stackrel{\prime}{-}$ CANOPY TREES 3 PER 100 L.F. SHRUBS 25 PER 100' L.F. UNDERSTORY TREE - 6 PER 100 L.F. (EVERGREEN) UNDERSTORY TREE (ORNAMENTAL)

### 2 TYPE C BUFFER SEMI-OPAQUE

L1.02 NOT TO SCALE

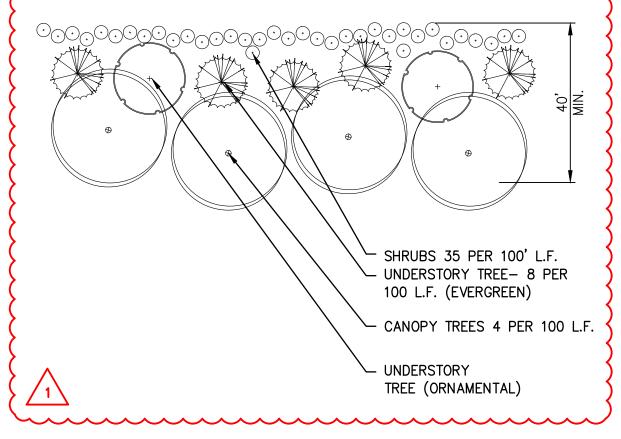


TYPE D BUFFER- OPAQUE L1.02 NOT TO SCALE

1. PLANTING MIX TO CONSIST OF 1" COMPOST PER 6" OF TOPSOIL

2. COMPOST SHALL CONSIST OF STERILIZED, COMPOSTED MATERIAL

(SWEET PEAT OR OTHER APPROVED EQUAL). CONTRACTOR SHALL SUBMIT SAMPLE TO OWNER'S REPRESENTATIVE FOR APPROVAL PRIOR

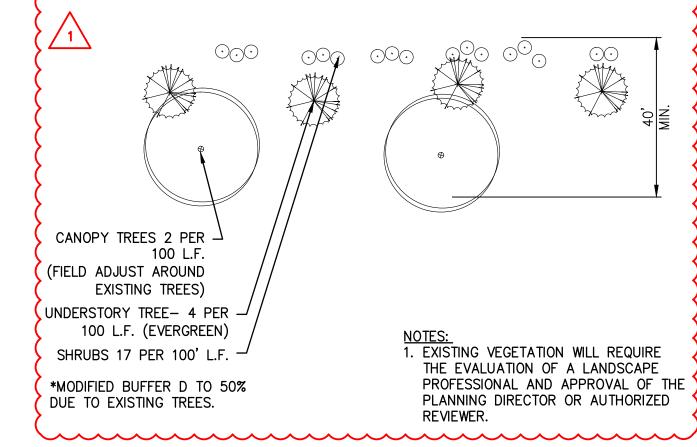

MODIFIED TYPE D BUFFER WITH EXISTING TREES L1.02 NOT TO SCALE


### MODIFIED TYPE C BUFFER SEMI-OPAQUE (OVERHEAD POWER)

L1.02 NOT TO SCALE

1. REMOVE BURLAP, WIRE BASKETS AND TWINE FROM TOP AND SIDES OF ROOT BALL. CENTER TREE IN HOLE SET TOP OF BALL 1" ABOVE FINISH GRADE.

2. STAKING & GUYING TREES IS OPTIONAL, HOWEVER THE CONTRACTOR IS RESPONSIBLE FOR THE INSTALLED TREES STAYING PLUMB AND STABLE. IF A NON-STAKED TREE MOVES OUT OF PLUMB DURING THE WARRANTY PERIOD THE CONTRACTOR SHALL STRAIGHTEN & STAKE THE TREE AT NO ADDITIONAL COST TO THE OWNER.

3. THE CONTRACTOR SHALL RETURN TO REMOVE ALL STAKES, GUYS & ASSOCIATED HARDWARE ON THE TREES ONE YEAR AFTER STAKING OR PER THE DIRECTION OF THE OWNER OR LANDSCAPE ARCHITECT. 3. THE CONTRACTOR SHALL RETURN TO REMOVE ALL STAKES, GUYS & ASSOCIATED HARDWARE ON THE

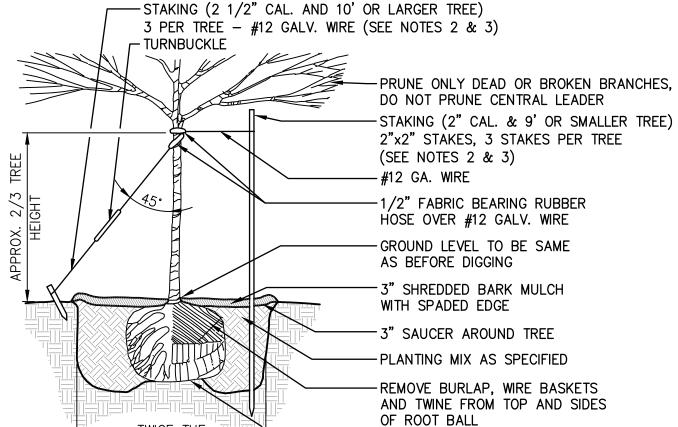


-SET BALL ON UNDISTURBED SUBGRADE

### **DECIDUOUS TREE PLANTING**

[1.02] NOT TO SCALE

COMPOST SHALL CONSIST OF STERILIZED, COMPOSTED MATERIAL (SWEET PEAT OR OTHER APPROVED EQUAL) CONTRACTOR SHALL SUBMIT SAMPLE TO LANDSCAPE ARCHITECT FOR APPROVAL PRIOR TO INSTALLATION OF PLANTS.

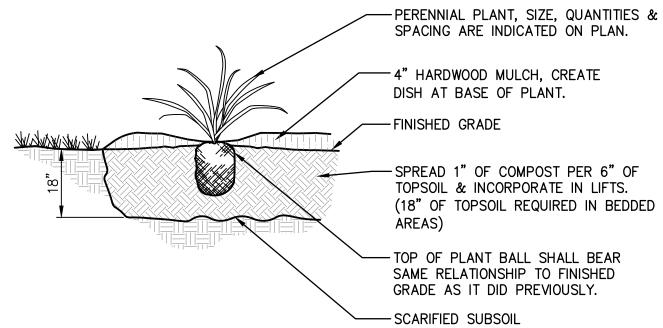


8 PERENNIAL PLANTING

L1.02 NOT TO SCALE

1. REMOVE BURLAP, WIRE BASKETS AND TWINE FROM TOP AND SIDES OF ROOT BALL. CENTER TREE IN HOLE. SET TOP OF BALL 1" ABOVE FINISH GRADE.


2. STAKING & GUYING TREES IS OPTIONAL, HOWEVER THE CONTRACTOR IS RESPONSIBLE FOR THE INSTALLED TREES STAYING PLUMB AND STABLE. IF A NON-STAKED TREE MOVES OUT OF PLUMB DURING THE WARRANTY PERIOD THE CONTRACTOR SHALL STRAIGHTEN & STAKE THE TREE AT NO ADDITIONAL COST TO THE OWNER

TREES ONE YEAR AFTER STAKING OR PER THE DIRECTION OF THE OWNER OR LANDSCAPE ARCHITECT.

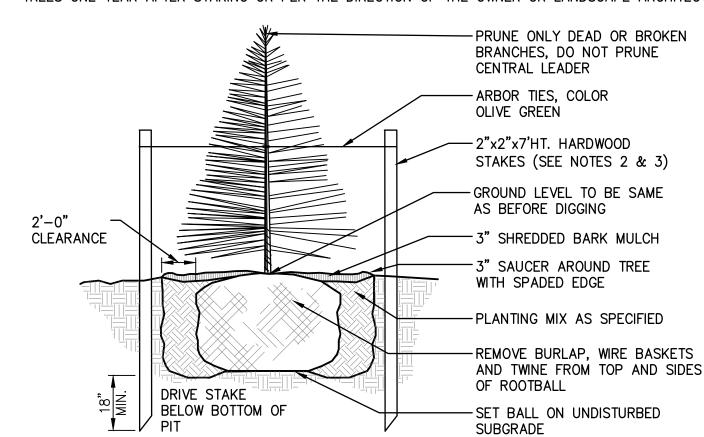


# **EVERGREEN TREE PLANTING**

L1.02 NOT TO SCALE

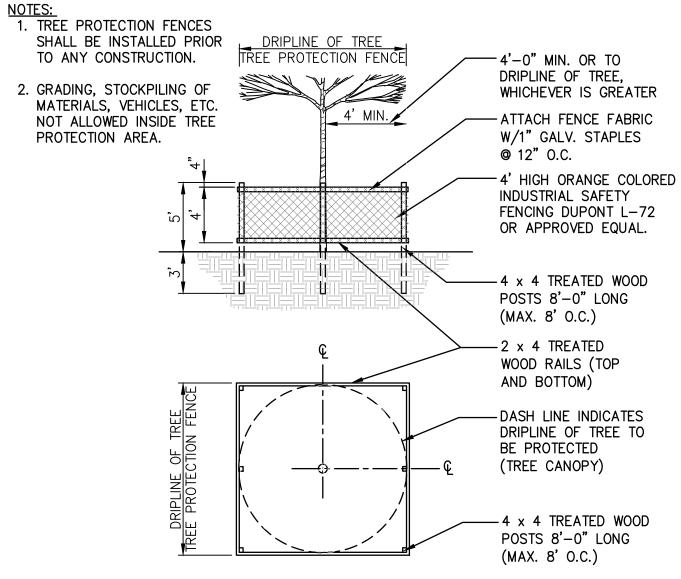

TYPICAL TREE PROTECTION \L1.02 NOT TO SCALE

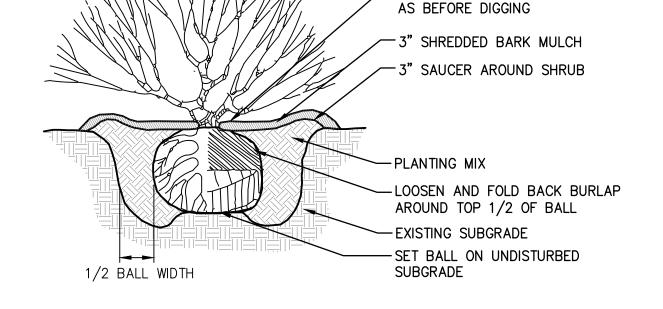

\*TREE SPECIES FROM APPROVED LIST FROM

-PRUNE ONLY DEAD OR

GROUND LEVEL TO BE SAME

BROKEN BRANCHES

TOWNOFZEULON.ORG

SHRUB PLANTING L1.02 NOT TO SCALE

TO INSTALLATION OF PLANTS.

3. MULCH TO FORM CONTINUOUS SHRUB BEDS.

METAL EDGING BETWEEN BED & LAWN OR SPADE CUT EDGE 3" DEEP SO THAT LAWN OR PAVEMENT WILL RETAIN MULCH -3" DEPTH WASHED RIVER ROCK #57 GRAVEL **ADJACENT** -FILTER FABRIC UNDER LAWN OR RIVER ROCK (TYP) **PAVEMENT** -12" PLANT SOIL MIXTURE IN PLANTING BED

PLANTING BED METAL EDGING

L1.02 NOT TO SCALE

	LIST	T
ABBR.	BOTANICAL NAME	COMMON NAME
	SHADE TREES	
AC SA		SUGAR MAPLE
CA DE	CASTANEA DENTATA	AMERICAN CHESTNUT
CE OC	CELTIS OCCIDENTALIS	HACKBERRY
FA GR	FAGUS GRANDIFOLIA	AMERICAN BEECH
NY SY	NYSSA SYLVATICA	BLACK GUM
QU BI	QUERCUS BICOLOR	SWAMP WHITE OAK
TA DI	TAXODIUM DISTICHUM	BALD CYPRESS
TI AM	TILIA AMERICANA	AMERICAN BASSWOOD
	EVERGREEN TREES	
AB CO	ABIES CONCOLOR	WHITE FIR
JU VI	JUNIPERUS VIRGINIANA	EASTERN RED CEDAR
PI AB	PICEA ABIES	NORWAY SPRUCE
PI PU	PICEA P. 'BABY BLUE EYES'	BLUE SPRUCE
PI ST	PINUS STROBUS	EASTERN WHITE PINE
TS CA	TSUGA CANADENSIS	CANADIAN HEMLOCK
	ORNAMENTAL TREES	
AM LA	AMELANCHIER LAEVIS	ALLEGHENY SERVICEBERRY
BE NI	BETULA NIGRA	RIVER BIRCH
CE CA	CERCIS CANADENSIS	EASTERN REDBUD
CR PU	CRATAEGUS PUNCTATA	OHIO HAWTHORN
OS VI	OSTRYA VIRGINIANA	EASTERN HOP HORNBEAM
	SHRUBS	
CO SE		REDOSIER DOGWOOD
	HYDRANGEA QUERCIFOLIA	OAKLEAF HYDRANGEA
IL ME	ILEX X M. 'BLUE PRINCESS'	BLUE PRINCESS HOLLY
PH OP		NINEBARK
RO PA	ROSA PALUSTRIS	SWAMP ROSE
SA DI	SALIX DISCOLOR	PUSSY WILLOW
SA CA	SAMBUCUS CANADENSIS	COMMON ELDERBERRY
VI DE	VIBURNUM DENTATUM	ARROWWOOD VIBURNUM

# RIMM AMPGROUND $\overline{\mathbf{Z}}$ 2 HONB, Z O EBU 30% CDS

**Environmental** 

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DATE ISSUED: 20			2024/04/01

L1.02

LANDSCAPE PLAN

**DETAILS** 








# ZEBULON CAMPGROUND ROGER HONBARRIER & RYAN RIMMELE

23-00285-020 CMR/SDK 2024/04/01

LIGHTING PLAN

E1.00

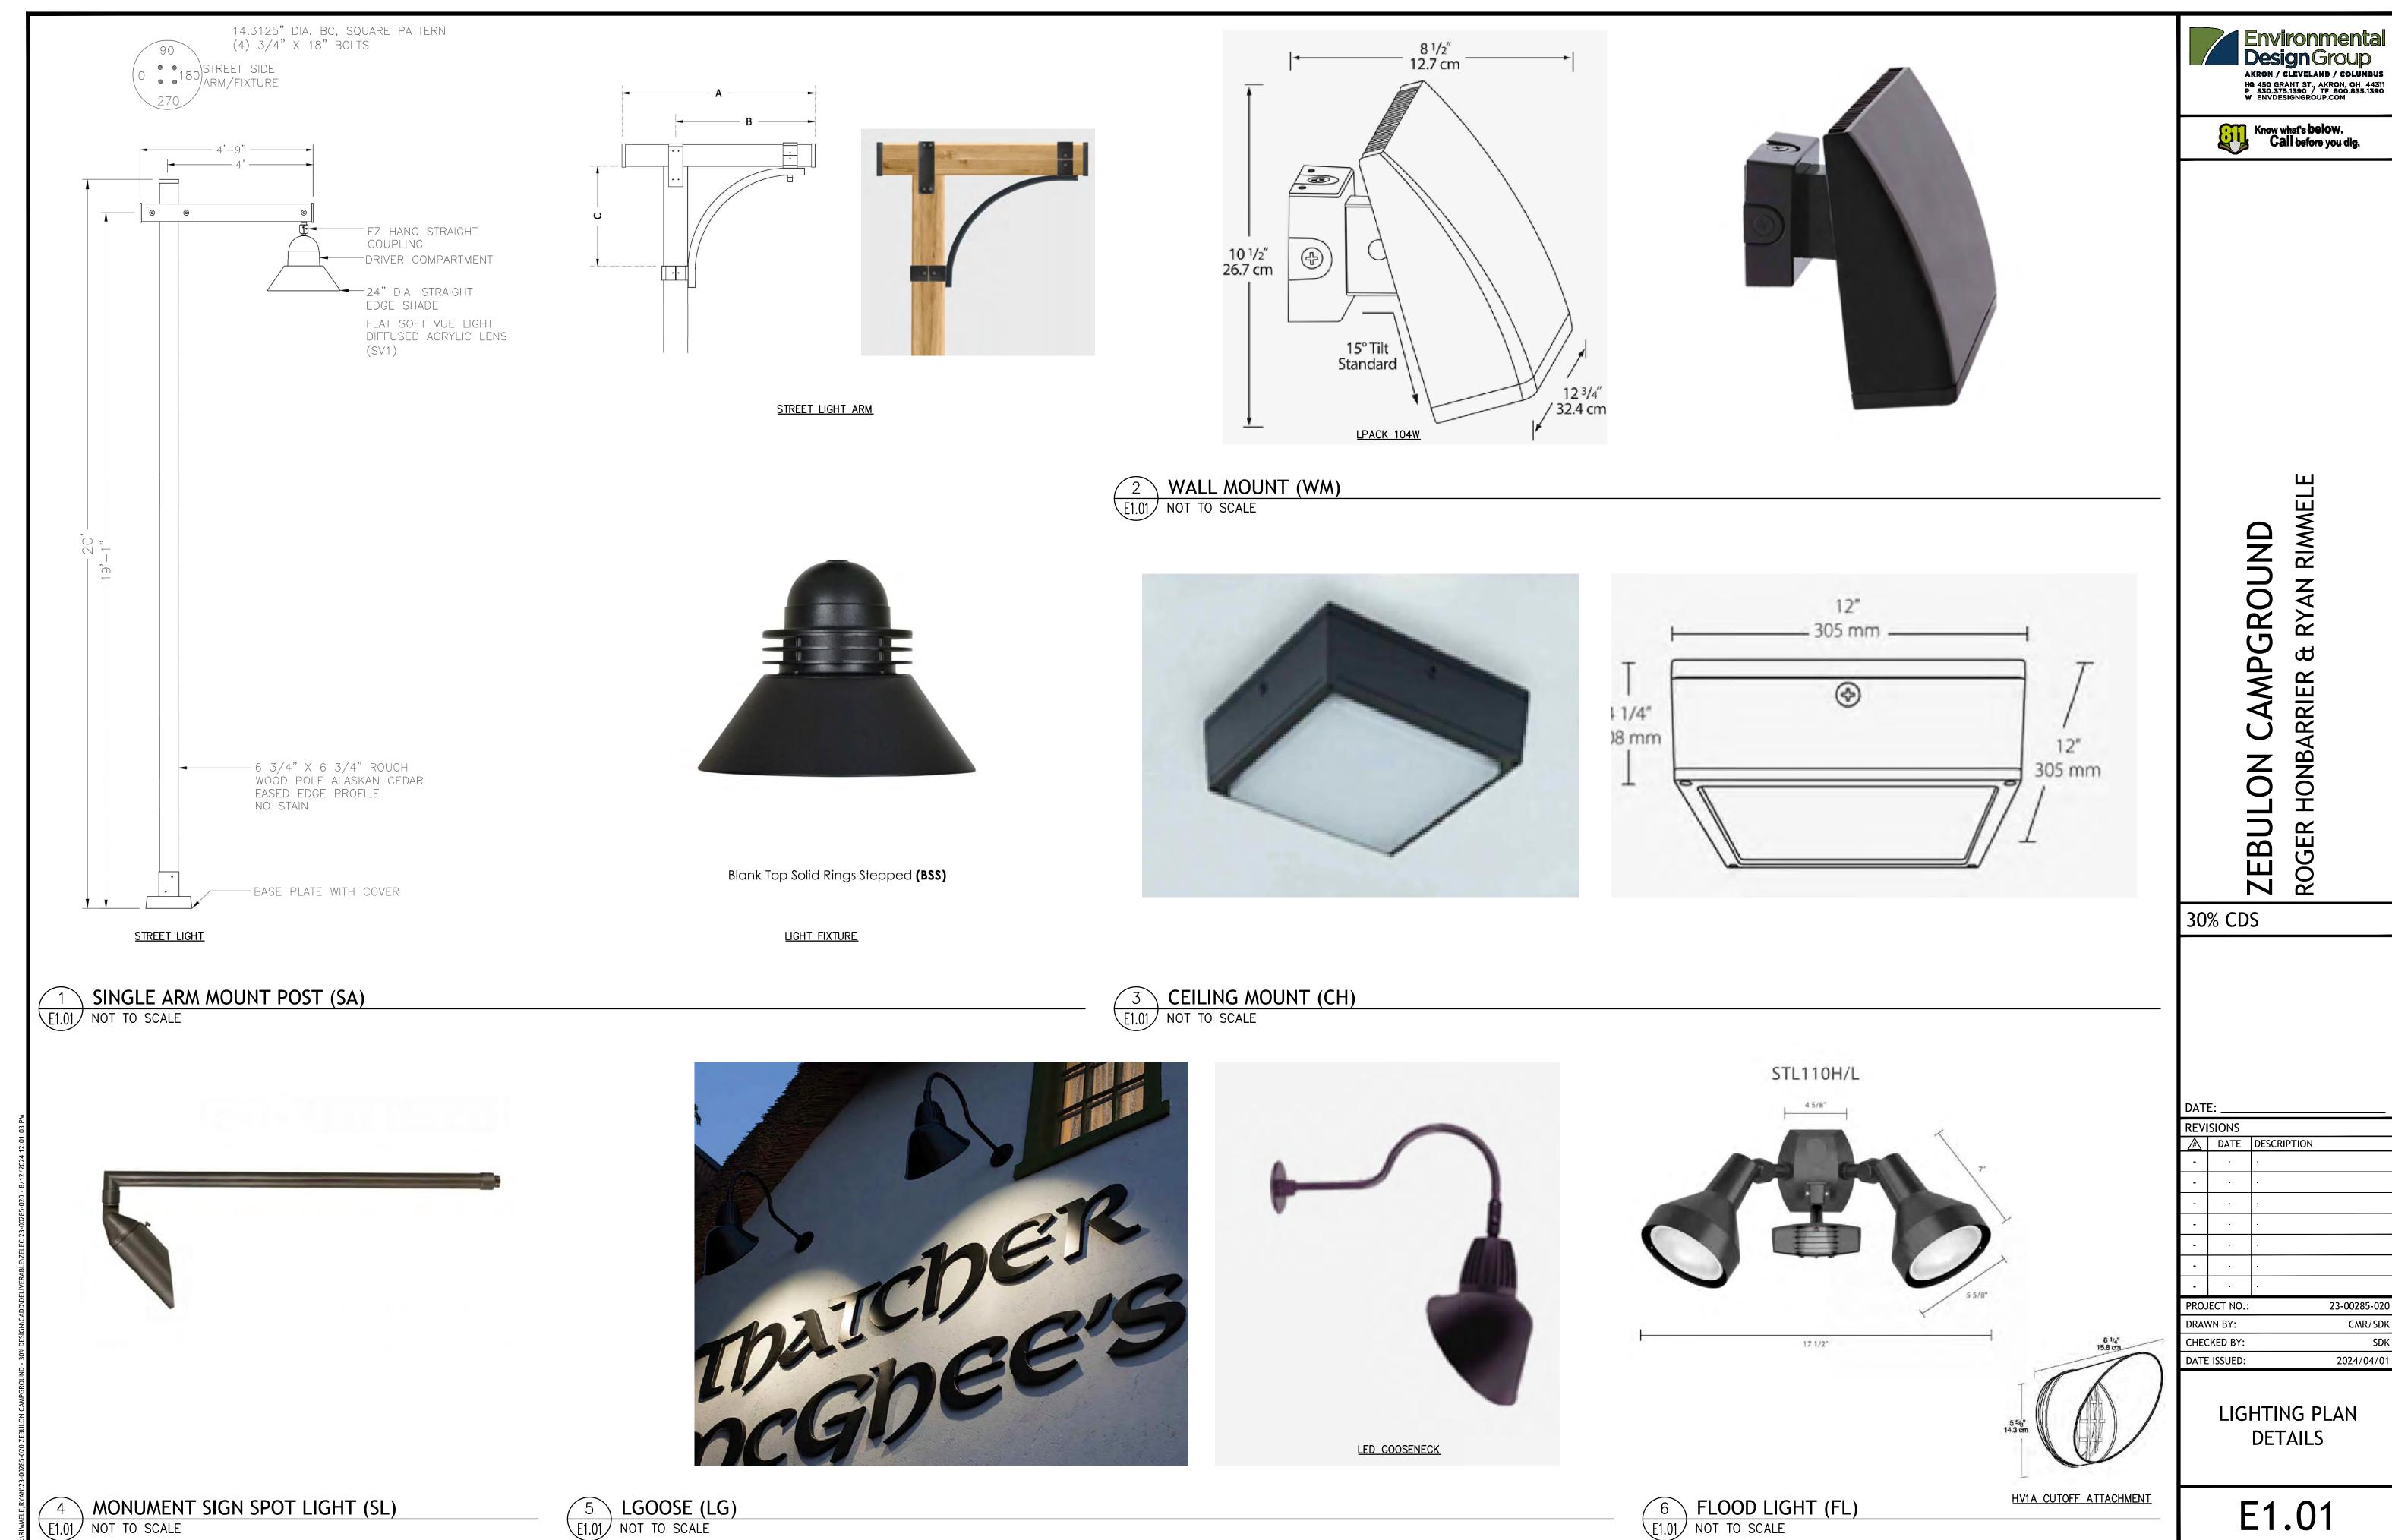

E1.01 NOT TO SCALE

HV1A CUTOFF ATTACHMENT 6 FLOOD LIGHT (FL)
E1.01 NOT TO SCALE E1.01

### ARCHITECTURAL PLAN ENLARGEMENT NOTES

1. THE CLIENT WILL APPLY FOR THE APPROPRIATE SUBMITTALS UPON COMPLETION OF CONSTRUCTION DOCUMENTS WHICH WILL BE DEVELOPED IN ACCORDANCE WITH THE LOCAL, STATE, AND FEDERAL REQUIREMENTS.







& RYAN RIMMELE


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23-00285-020 PROJECT NO.:

CMR/SDK DRAWN BY: CHECKED BY: DATE ISSUED: 2024/04/01

ARCHITECTURAL PLAN ENLARGEMENT

A1.00

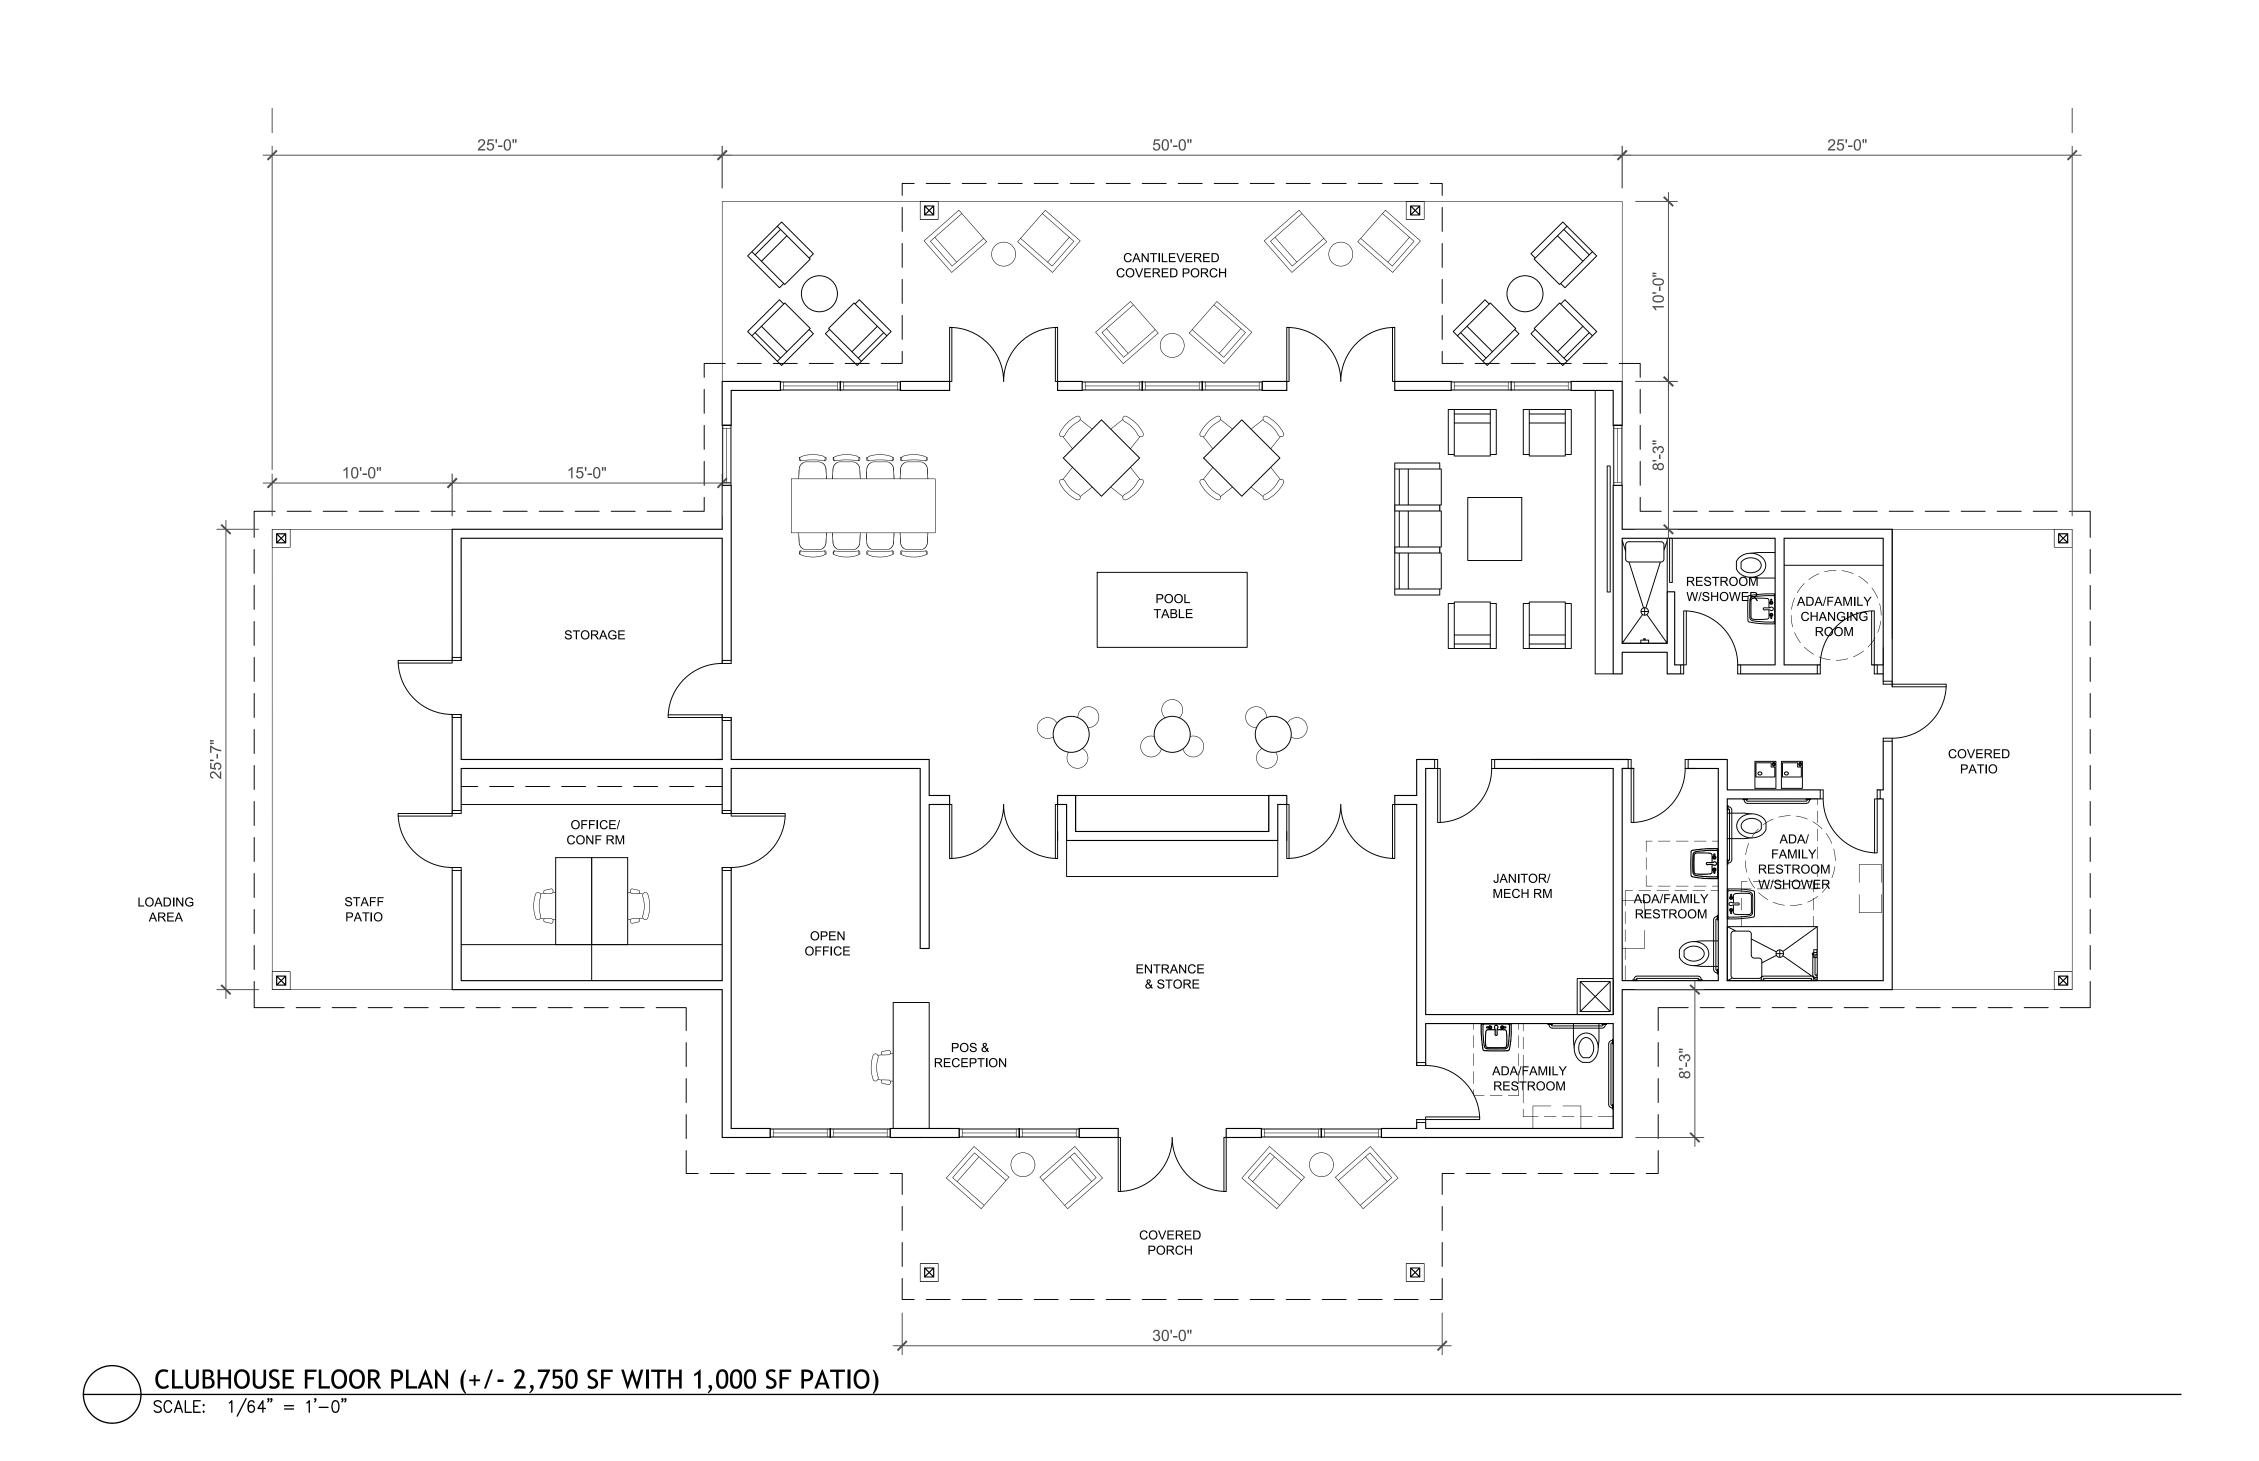

### ARCHITECTURAL PLAN ENLARGEMENT NOTES

BASIS OF DESIGN SIDING MATERIALS:

- HORIZONTAL SIDING: HARDIE PANEL, SELECT CEDARMILL, ARCTIC WHITE

- BOARD AND BATTEN SIDING: HARDIE PANEL, SELECT CEDARMILL, ARCTIC WHITE, AND HARDIE TRIM BATTEN BOARDS, SMOOTH GRAIN, ARCTIC WHITE








# HEAVY TIMBER TRUSS — AND COLUMNS ASPHALT SHINGLE OR -STANDING SEAM METAL ROOF - CONCRETE CAP - HORIZONTAL SIDING STONE VENEER TO BE SELECTED BY OWNER - CONCRETE SILL STONE VENEER TO BE SELECTED BY OWNER - BOARD AND BATTEN SIDING CLUBHOUSE SOUTH ELEVATION

SCALE: 1/64" = 1'-0"

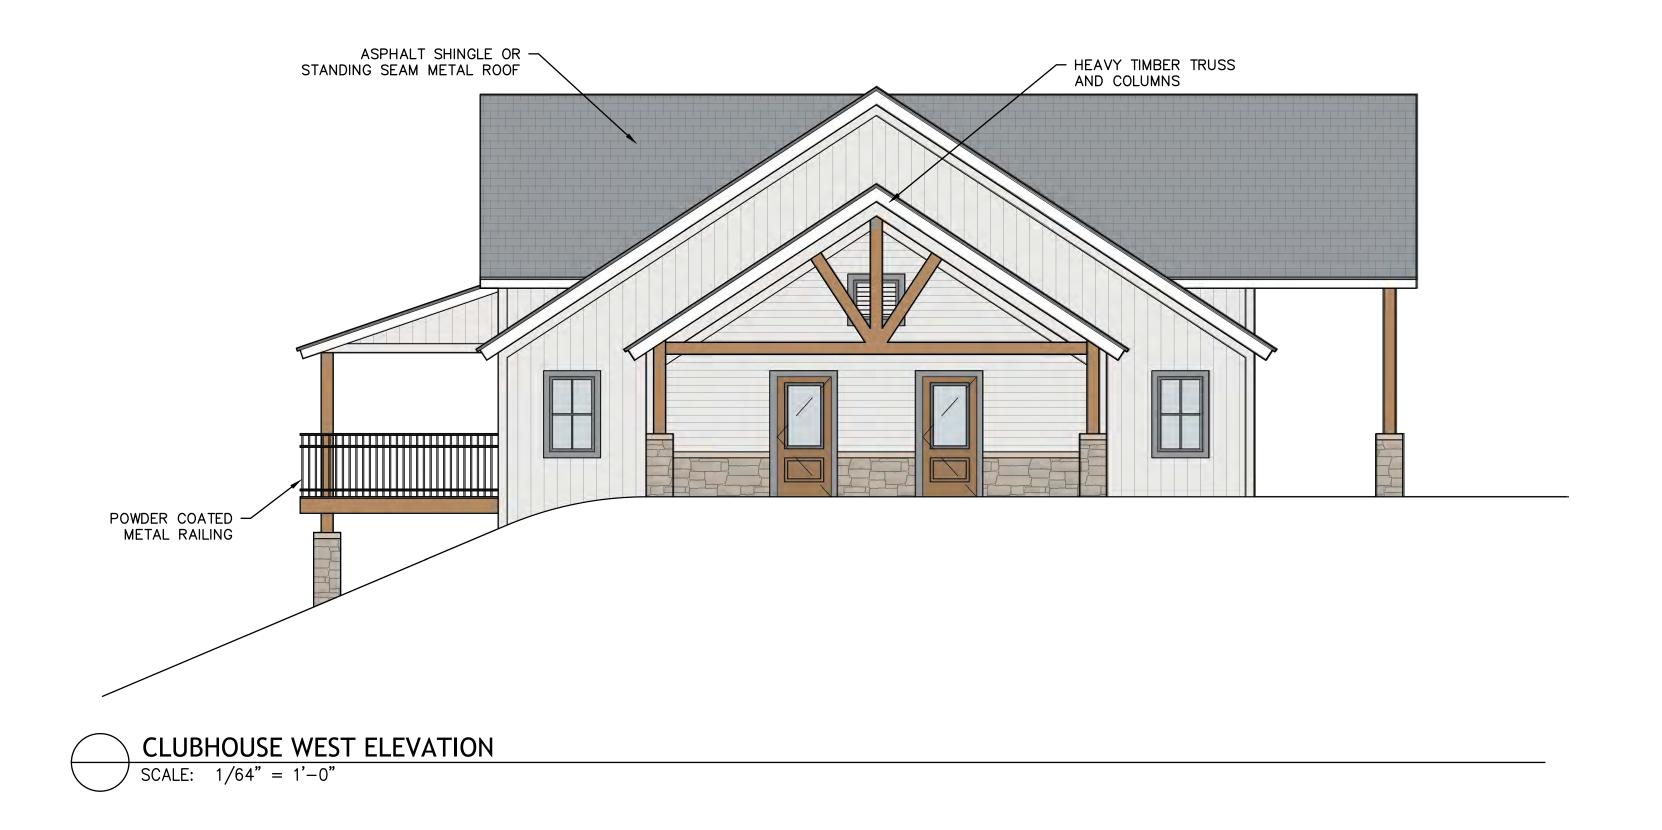

RYAN RIMMELE CAMPGROUND HONBARRIER ZEBULON (

30% CDS

**REVISIONS** 

⚠ DATE DESCRIPTION

23-00285-020 PROJECT NO.: DRAWN BY: CMR/SDK CHECKED BY: DATE ISSUED: 2024/04/01

ARCHITECTURAL PLAN **ENLARGEMENT** 

A1.01





ZEBULON CAMPGROUND
ROGER HONBARRIER & RYAN RIMMELE

30% CDS

PROJECT NO.: 23-00285-020

DRAWN BY: CMR/SDK

CHECKED BY: SDK

DATE ISSUED: 2024/04/01

ARCHITECTURAL PLAN ENLARGEMENT

A1.02

ASPHALT SHINGLE OR STANDING SEAM METAL ROOF

COUNTET CAP

STONE VENUER TO DE


SELECTED BY OWNER

STONE WENER TO DE

SELECTED BY OWNER

STONE WENER

SCALE: 1/64" = 1'-0"

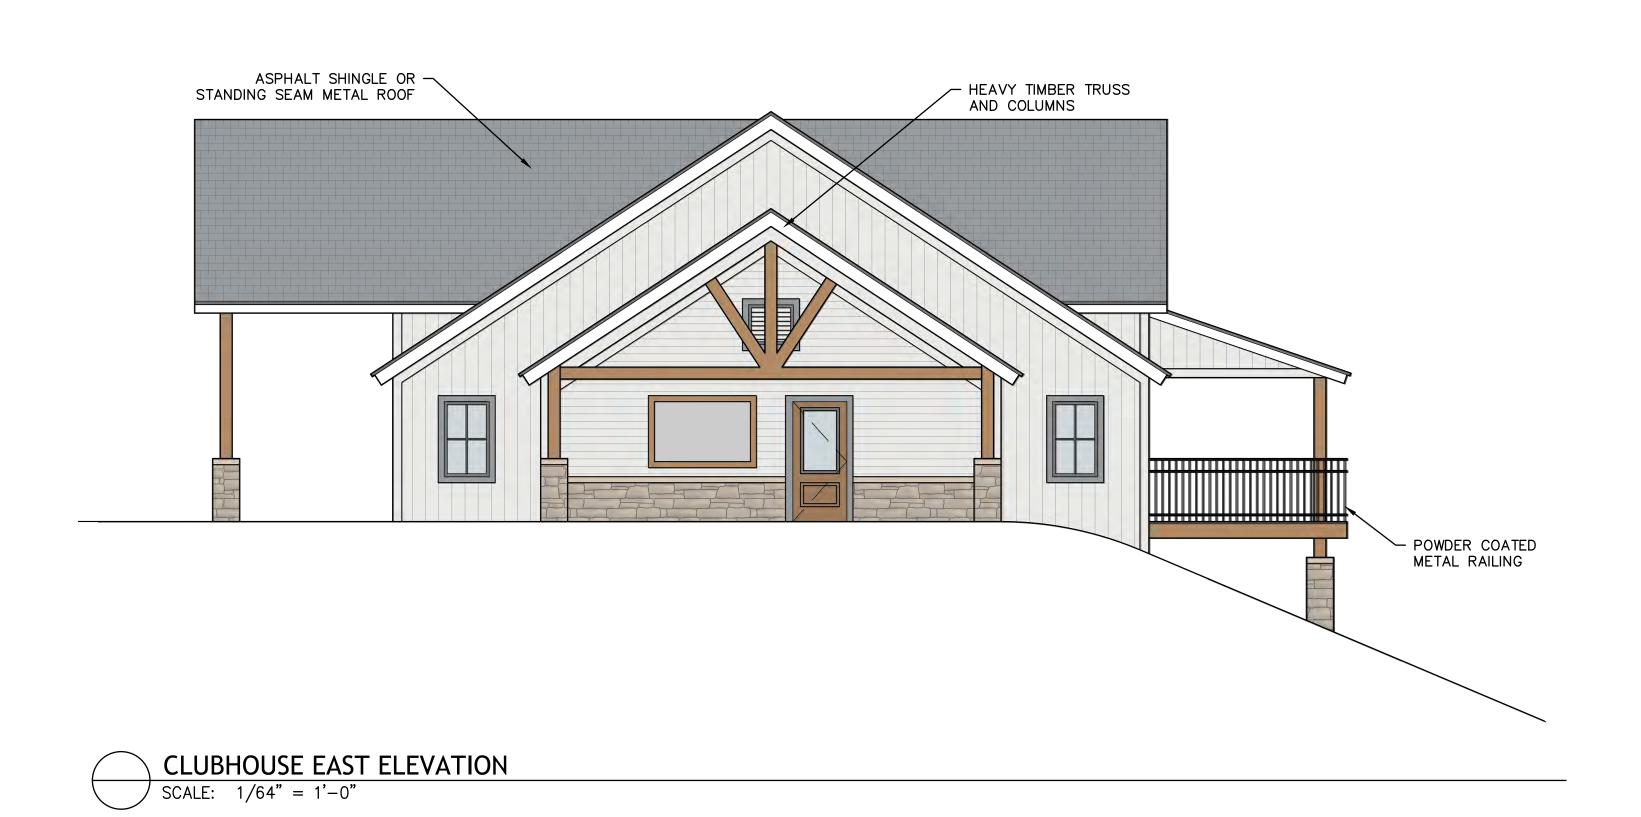

### ARCHITECTURAL PLAN ENLARGEMENT NOTES

BASIS OF DESIGN SIDING MATERIALS:

EAST ELEVATION

- HORIZONTAL SIDING: HARDIE PANEL, SELECT CEDARMILL, ARCTIC WHITE

- BOARD AND BATTEN SIDING: HARDIÉ PANEL, SELECT CÉDARMILL, ARCTIC WHITE, AND HARDIE TRIM BATTEN BOARDS, SMOOTH GRAIN, ARCTIC WHITE







RYAN RIMMELE CAMPGROUND HONBARRIER ZEBULON (

**REVISIONS** 

DATE ISSUED:

30% CDS

⚠ DATE DESCRIPTION

PROJECT NO.: 23-00285-020 CMR/SDK DRAWN BY: CHECKED BY:

ARCHITECTURAL PLAN **ENLARGEMENT** 

2024/04/01

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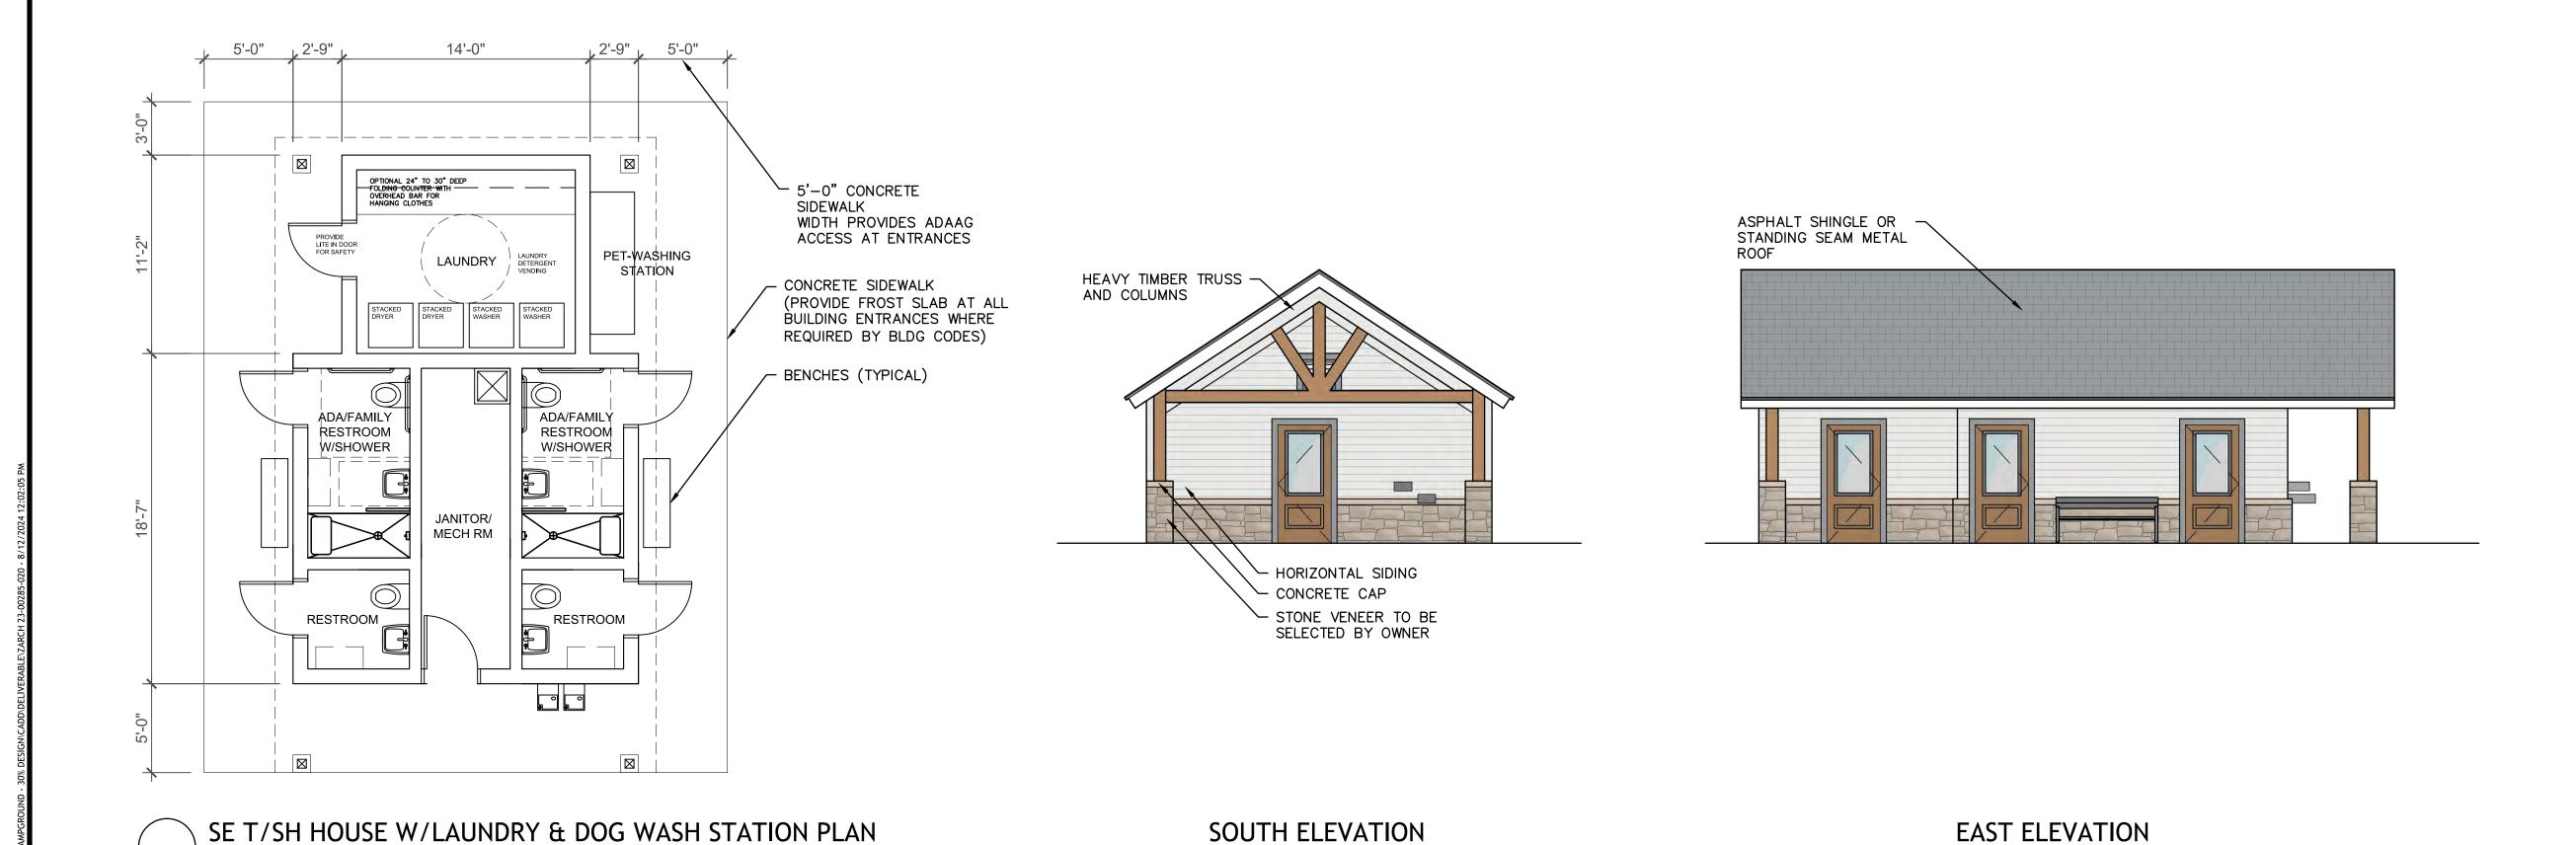



NORTH ELEVATION

NE T/SH HOUSE PLAN

SCALE: 1/64" = 1'-0"

SCALE: 1/64" = 1'-0"



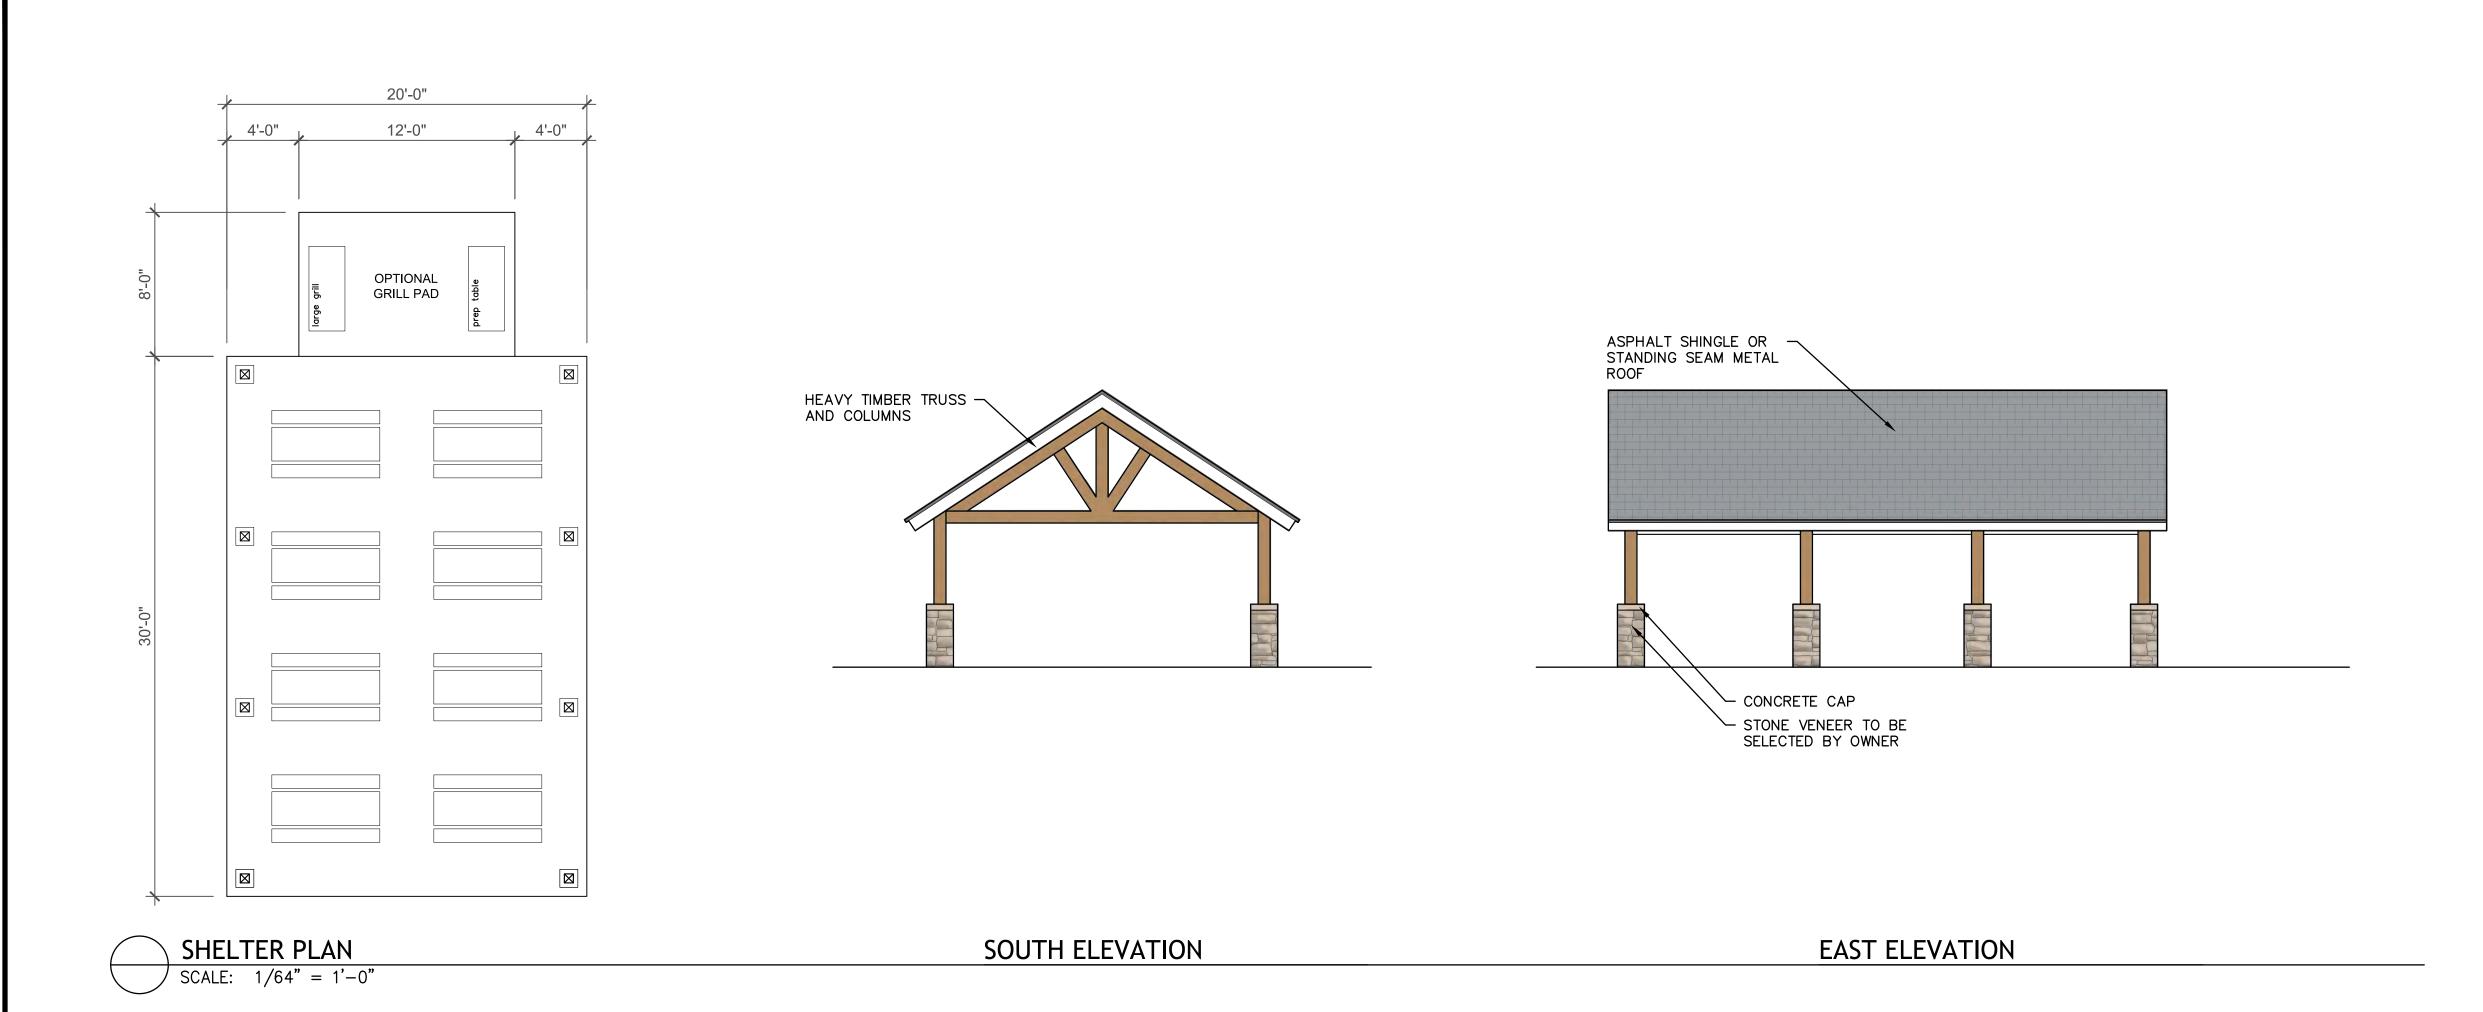

Environmental Design Group

AKRON / CLEVELAND / COLUMBUS

He 450 GRANT ST., AKRON, OH 44311
P 330.375.1390 / TF 800.835.1390
W ENVDESIGNGROUP.COM



ZEBULON CAMPGROUND
ROGER HONBARRIER & RYAN RIMMELE

30% CDS

DATE:

REVISIONS

A DATE DESCRIPTION

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PROJECT NO.:

DRAWN BY:

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DATE ISSUED:

ARCHITECTURAL PLAN ENLARGEMENT

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CMR/SDK

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