
SITE PLAN DRAWINGS FOR

FRANCO MASONRY & CONCRETE

970 MACK TODD ROAD ZEBULON, NORTH CAROLINA, 27597

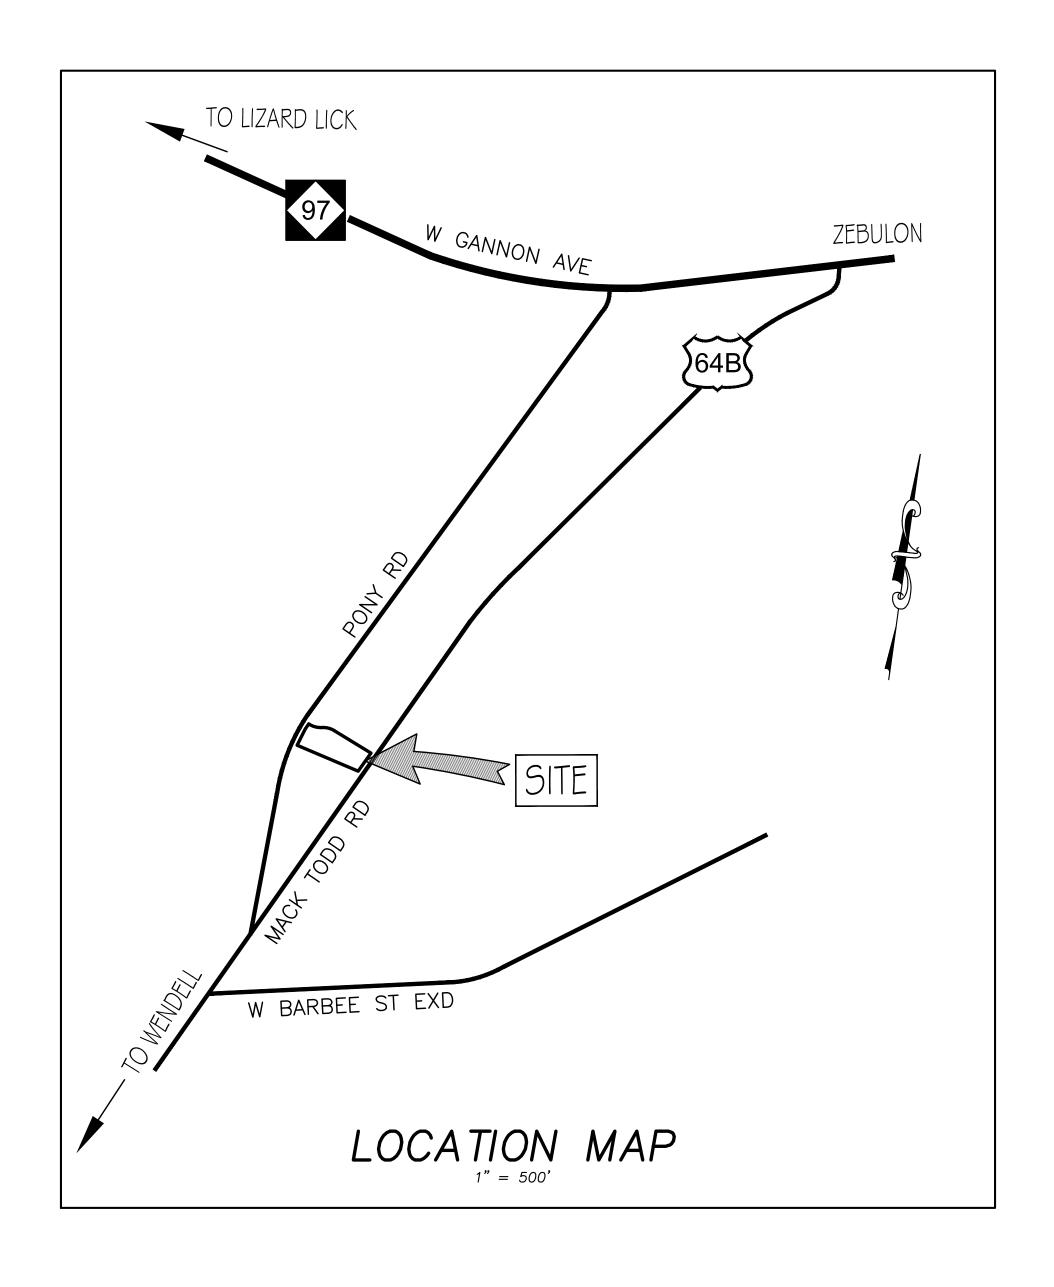

	INDEX TO DRAWINGS	
SHEET No.	DESCRIPTION	DRAWING No.
1 OF 14	COVER SHEET & LOCATION MAP	C1.0
2 OF 14	EXISTING CONDITIONS & DEMOLITION PLAN	C2.0
3 OF 14	SITE PLAN	C3.0
4 OF 14	SITE PLAN DETAILS	C3.1
5 OF 14	OVERALL GRADING & DRAINAGE PLAN	C4.0
6 OF 14	OVERALL GRADING & DRAINAGE PLAN DETAILS	C4.1
7 OF 14	EROSION CONTROL PLAN	C5.0
8 OF 14	EROSION CONTROL DETAILS	C5.1
9 OF 14	UTILITY PLAN - WATER AND SEWER SERVICES	C6.0
10 OF 14	UTILITY DETAILS SH.1	C6.1
11 OF 14	UTILITY DETAILS SH.2	C6.2
12 OF 14	UTILITY DETAILS SH.3	C6.3
13 OF 14	LANDSCAPE PLAN	C7.0
14 OF 14	LANDSCAPE DETAILS	C7.1

GENERAL NOTES:

1. THIS MAP IS NOT FOR CONVEYANCE, RECORDATION OR SALES.
2. BOUNDARY AND TOPOGRAPHIC SURVEYS WERE PERFORMED BY JAMES W. NIPPER LAND SURVEYING; DATED JANUARY 22, 2024.
3. STORMWATER DRAINS TO LITTLE RIVER (WS-V; NSW); RIVER BASIN: NEUSE; STREAM INDEX: 27-57-(8.5).

4. THERE ARE NO JURISDICTIONAL STREAM OR WETLANDS ON SITE.
5. THERE ARE NO DESIGNATED SPECIAL FLOOD HAZARD ZONE (100—YEAR FLOODPLAIN) ON THE PROPERTY (DFIRM 3720179500K, DATED 7/19/2022

PROJECT DATA:

1. PROJECT ADDRESS:

970 MACK TODD RD
ZEBULON, NC 27597
2. PARCEL ID NO:
1795811688
3. REID NO:
4. CONSULTANT:
CSD ENGINEERING
JOHN F. OGLESBY, PE
919-624-0997 |M
910-791-4441 |0

john@csd—engineering.com

5. PROPERTY OWNER: FRANCO & OLGA MARIBEL ROMERO
970 MACK TODD RD

ZEBULON, NC 27597
919–255–0331
francomasonrycon@gmail.com

6. PROJECT ZONING:
7. FUTURE LAND USE CLASS:
8. PROPOSED LAND USE:
CONTRACTOR OFFICE & SERVICE YARD

1.07 AC NET (46 600 SO ET.)

8. PROPOSED LAND USE: CONTRACTOR OFFICE & SERVICE YARD
9. PARCEL AREA = 1.07 AC NET (46,609 SQ. FT.)
10. REQUIRED SETBACKS: = 30' STREET, 0 OR 5' SIDE
11. REQUIRED BUFFERS = 15' MODIFIED TYPE C STREET SCAPE BUFFER = 10' TYPE A LANDSCAPE BUFFER (SIDES)

12. MAX. LOT COVERAGE = 80% (37,287 SQ. FT.) 13. ACTUAL LOT COVERAGE = SEE LOT COVERAGE NOTE ON SHEET C3.0



LICENSE # C-2710 ENGINEERING LAND PLANNING COMMERCIAL / RESIDENTIAL


P.O. BOX 1250 WENDELL, NC 27591 (910) 791—4441

COVER SHEET
& LOCATION MAP

This document is copyrighted by part of it, without written cons

OCATED IN TOWN OF ZEBULON
VAKE COUNTY, NORTH CAROLINA
WER: FRANCO ROMERO
ONTACT: FRANCO ROMERO
SEBULON, NC 27597
(919) 255-0331



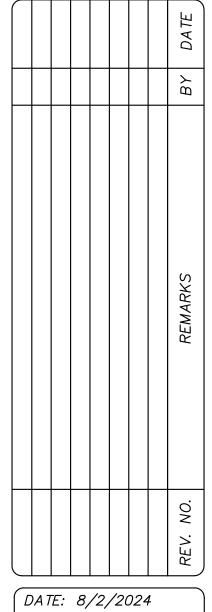

DATE: 8/2/2024

HORZ. SCALE: 1" = 500'
VERT. SCALE: N/A

DRAWN BY: RBS

CHECKED BY: JFO

PROJECT NO.: 24-0682

LEGEND EX. PROPERTY LINE ---- - EX. PUBLIC R/W LINE ---- EX. ADJOINING PROPERTY LINE EX. PRIVATE R/W OR EASEMENT ----- EX. PUBLIC EASEMENT LINE EX. CENTERLINE EX. TREE LINE EX. SIDEWALK EX. CURB & GUTTER DI 🗆 CB EX. STORM DRAIN BOX EX. SANITARY SEWER MANHOLE EX. WATER LINE EX. HYDRANT & WATER VALVE EX. PAVEMENT MARKINGS EX. OVERHEAD POWER LINE & POLE

EXISTING CONDTION & DEMOLITION NOTES

- SITE ADDRESS: 970 MACK TODD RD ZEBULON, NC 27597
 BOUNDARY SURVEY, DATED 1/22/2024, WAS PROVIDED BY JAMES W. NIPPER LAND SURVEYING (NC FIRM NO. L-3916) 5707 HILLTOP RD RALEIGH, NC 27603
- 5707 HILLTOP RD
 RALEIGH, NC 27603
 919-917-7080
 3. METES AND BOUNDS ARE BASED ON STATE PLANE COORDINATES.
- 4. EXISTING OFF-SITE TOPOGRAPHY IS FROM BARE EARTH LIDAR DATA DOWNLOAD FROM THE N.C. FLOOD RISK INFORMATION SYSTEM; WAKE COUNTY FIRM PANEL 1795.
 5. THERE ARE NO FEMA SPECIAL FLOOD HAZARD ZONES (A & AE) LOCATED
- ON PROPERTY; DFIRM 3720179500K, DATED JULY 19, 2022.
 6. THERE ARE NO JURISDICTIONAL STREAM AND WETLANDS LOCATED ON
- 7. EXISTING SOILS ON—SITE CONSIST OF APPLING SANDY LOAM (SERIES APB2 AND APC20; THERE ARE NOT FLOOD—PRONE SOILS ON PROPERTY.
- 8. GREAT CARE SHALL BE TAKEN TO PRESERVE EXISTING VEGETATION AND LANDSCAPE FEATURES WITHIN AREAS OF REQUIRED BUFFER YARDS; .
- PROPOSED OPEN SPACE AND PRESERVATION AREAS ARE DETERMINED BY MEANS OF LOCATING EXISTING TREES AND NATURAL FEATURES ON—SITE; THERE ARE NO 24" OR GREATER CALIPER HARDWOOD TREES LOCATED WITHIN REQUIRED BUFFER YARDS.
- 10. STREET YARD BUFFERS ARE BASED ON REQUIREMENTS OF ZEBULON UDO FOR MODIFIED TYPE C STREET YARD (15 FEET) AND TYPE A BUFFER YARD (10 FEET); UTILIZING EXISTING VEGETATION SHOULD MEET UDO REQUIREMENTS FOR STREET SCAPE BUFFERS AND WILL PRESERVE NATIVE VEGETATION AND HABITAT.
- 11. PRIOR TO CONSTRUCTION, ALL AREAS FOR GRADING WILL BE STRIPPED
- AND PREPARED FOR FINAL GRADING.

 12. LIMITS OF DISTURBANCE TO TO THE LIMITS OF CONSTRUCTION; AREA = 0.45 ACRES (19,778 SQ. FT.).



LICENSE # C-2710
ENGINEERING
LAND PLANNING
COMMERCIAL / RESIDENTIAL

P.O. BOX 1250 WENDELL, NC 27591 (910) 791–4441

EXISTING CONDITIONS
WITH DEMOLITION PLAN

MTH
This document is copyrighted by CSD ENGN

LOCATED IN TOWN OF ZEBULON
WAKE COUNTY, NORTH CAROLINA
WNER: FRANCO ROMERO
970 MACK TODD ROAD
ZEBULON, NC 27597



PLAN NOT RELEASED FOR CONSTRUCTION

BY D. BY D. BEWARKS

DATE: 8/1/2024


HORZ. SCALE: 1" = 20'
VERT. SCALE: N/A

DRAWN BY: RBS


CHECKED BY: JFO


PROJECT NO.: 24-0682


Sheet No. <u>2</u> OF <u>14</u>

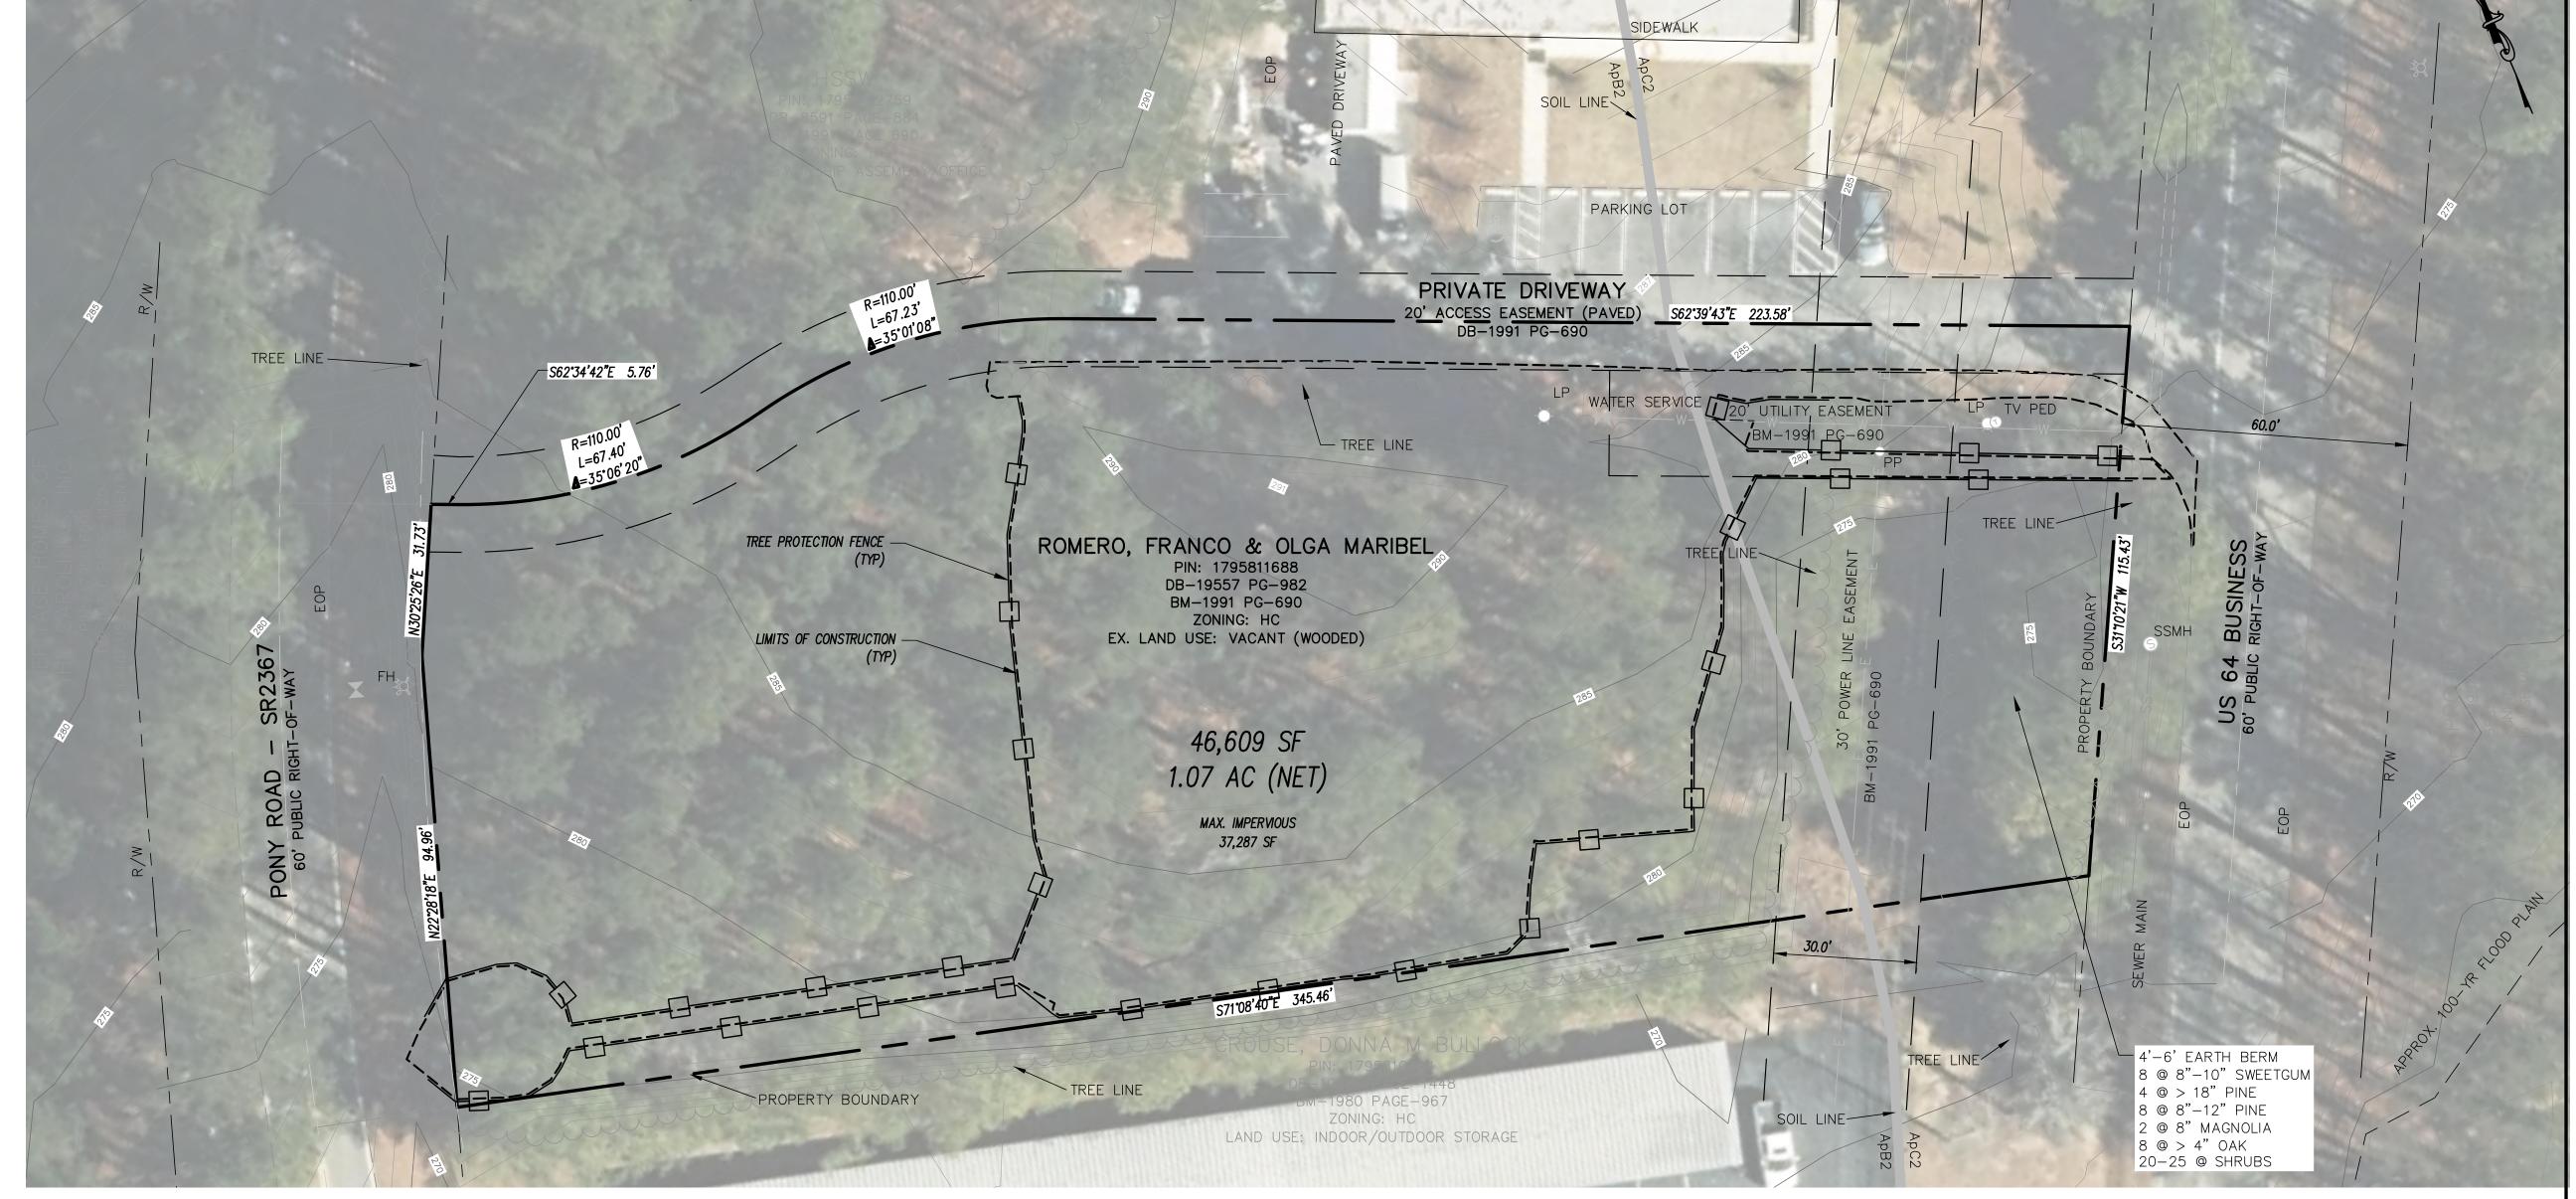



1-STORY BUILDING

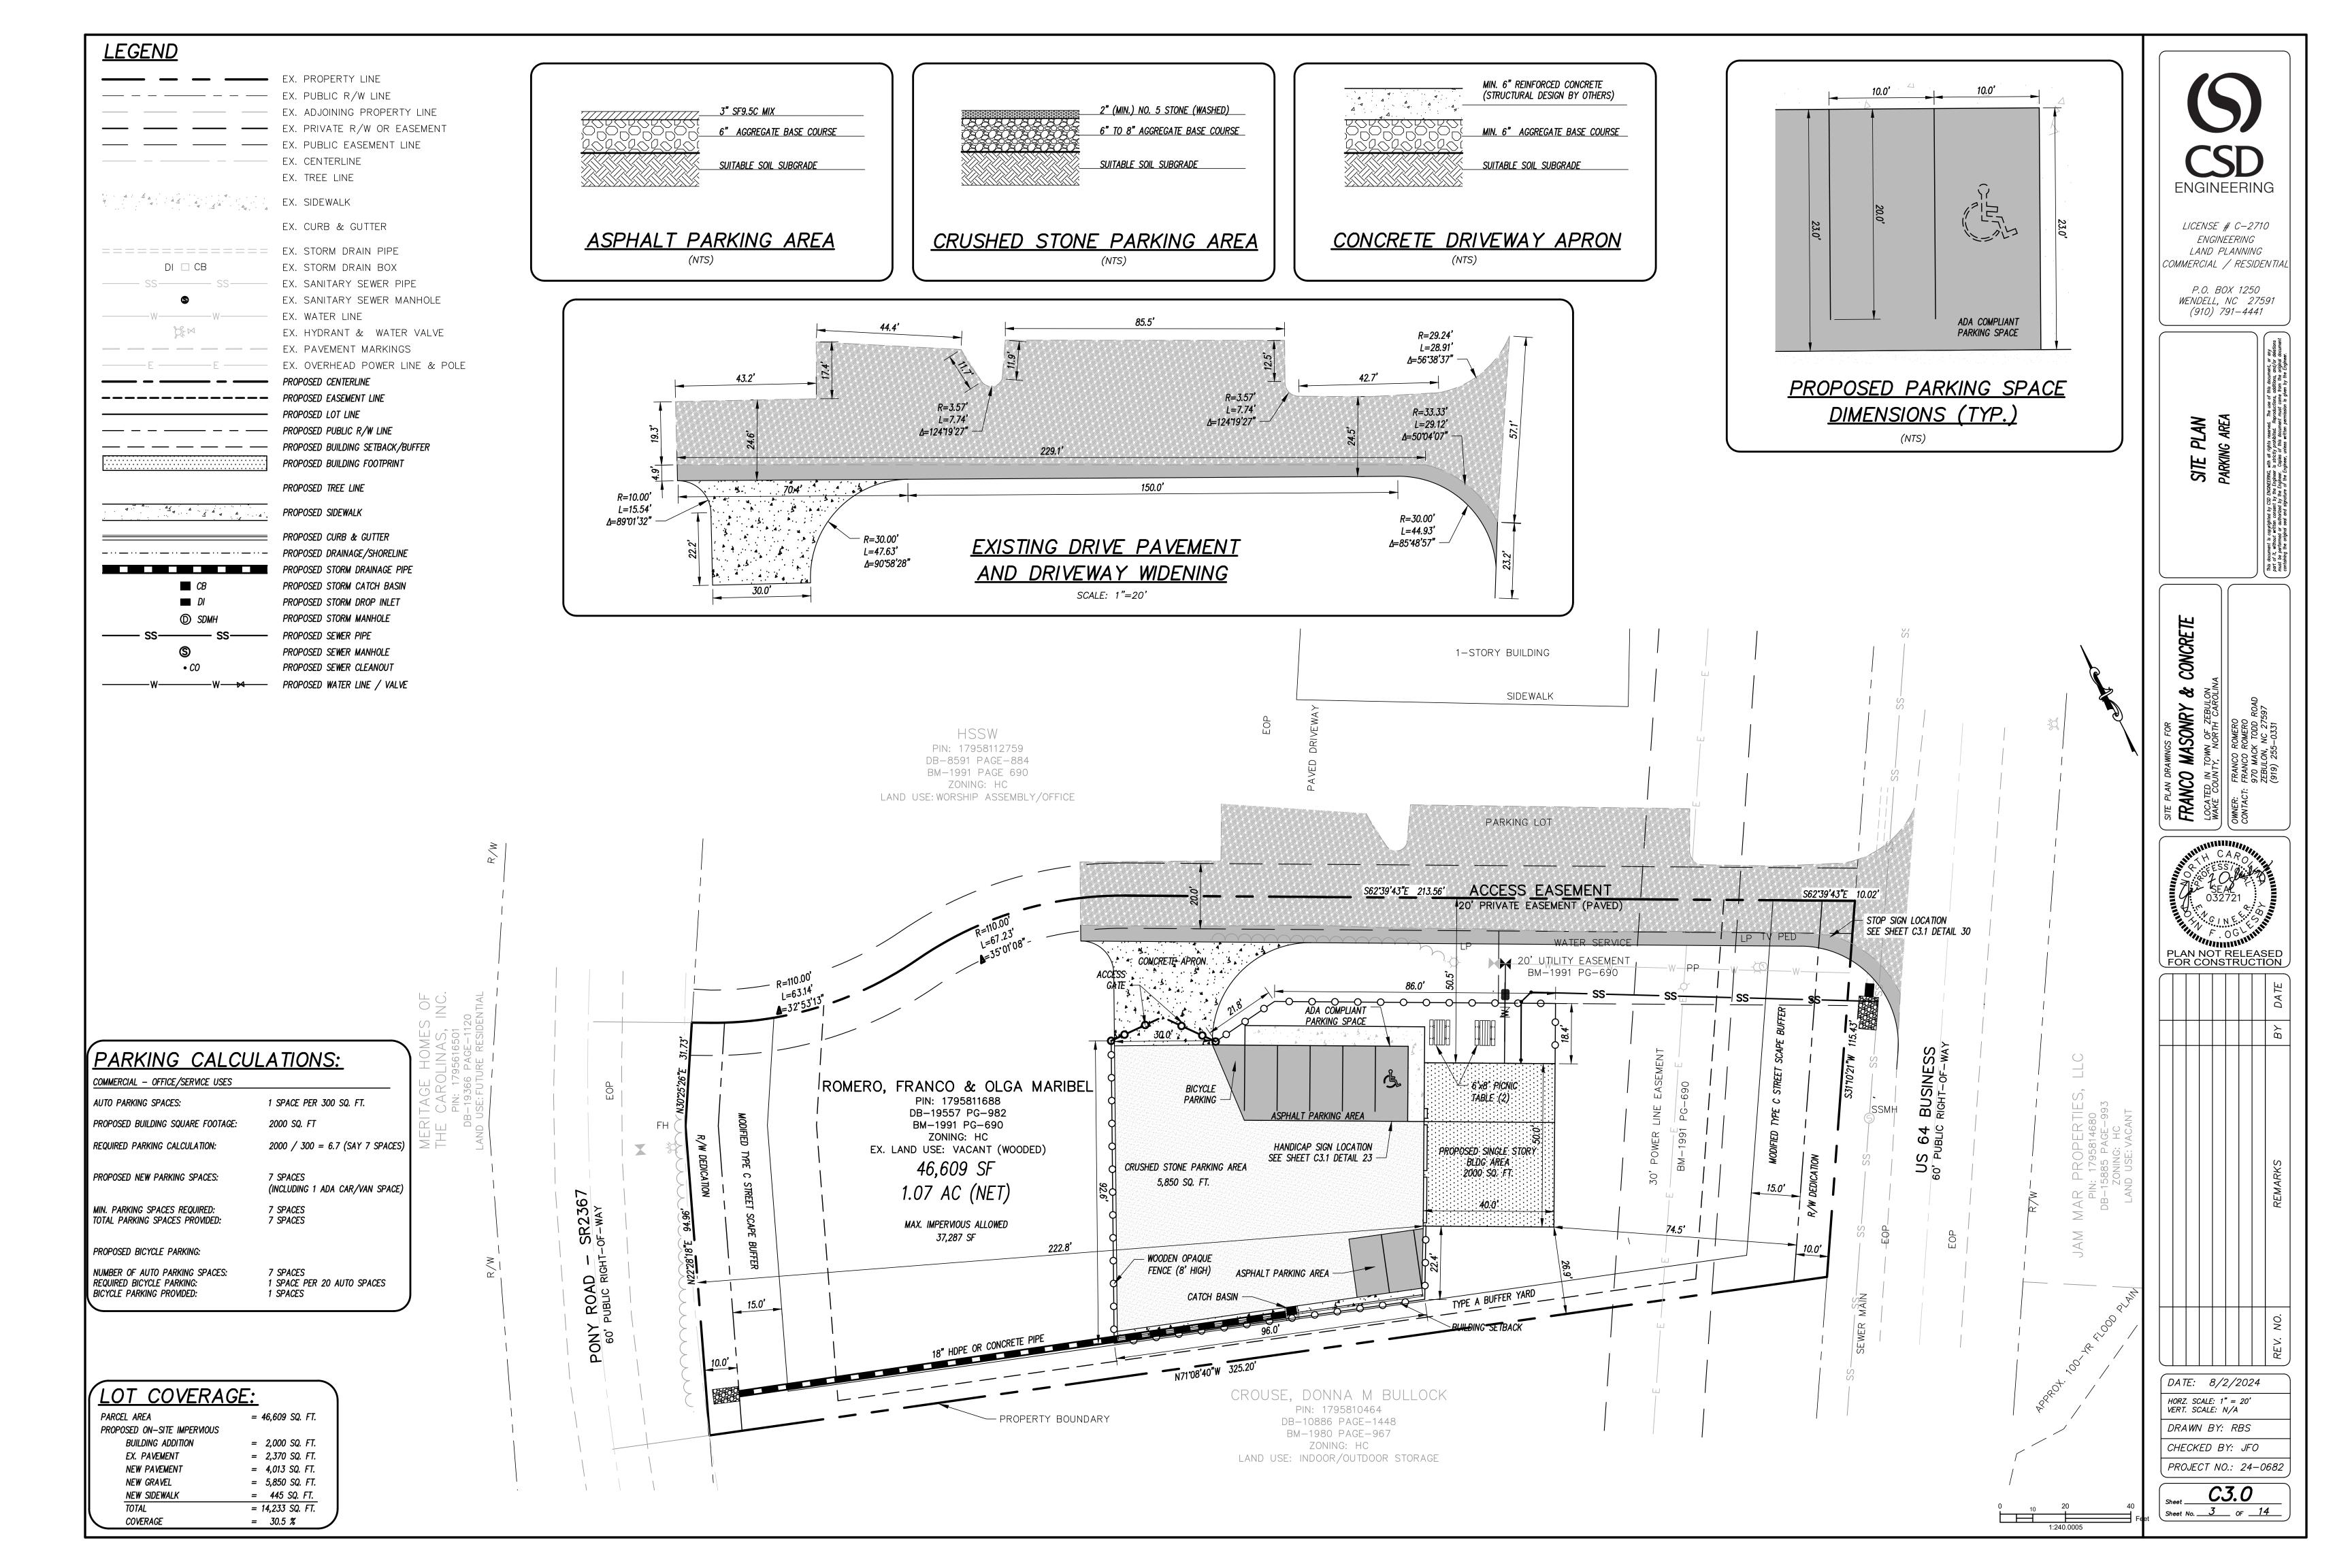

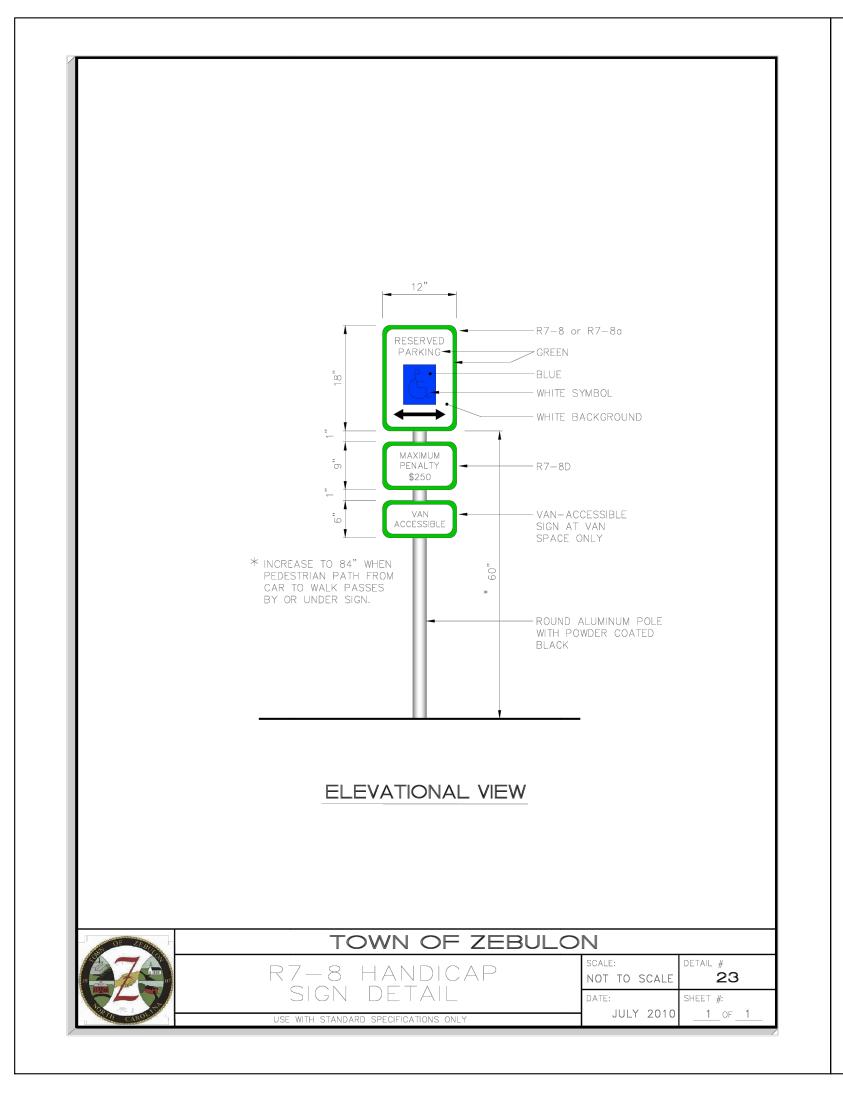

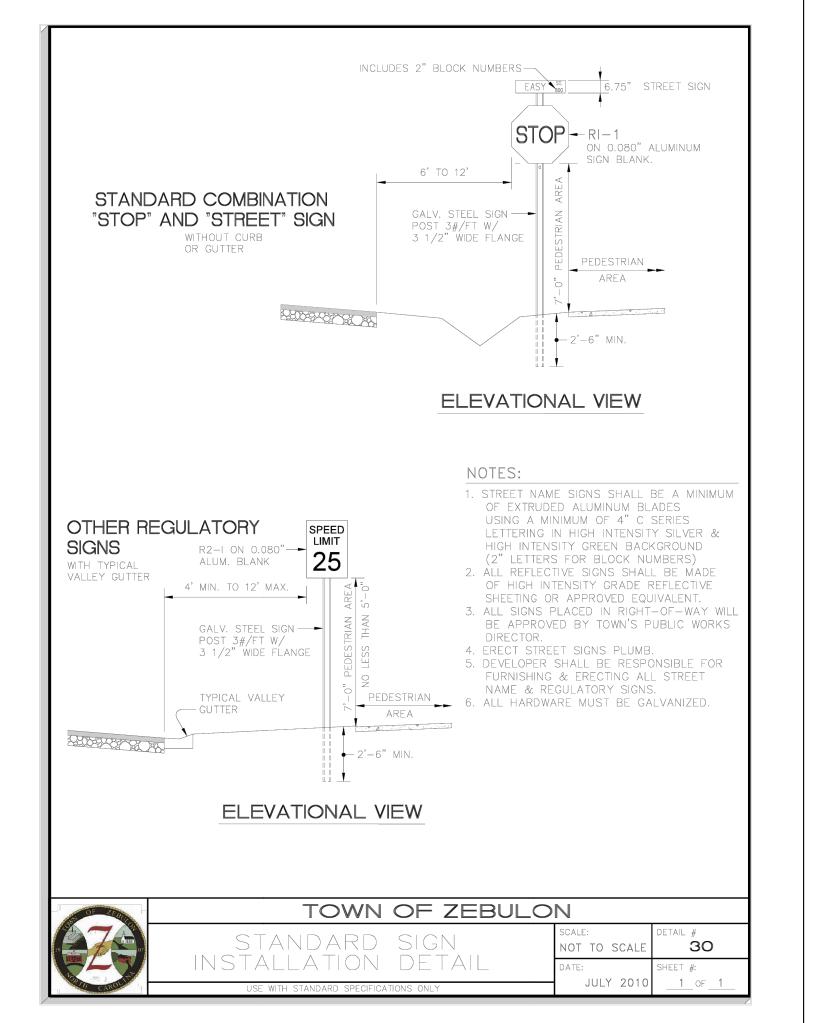

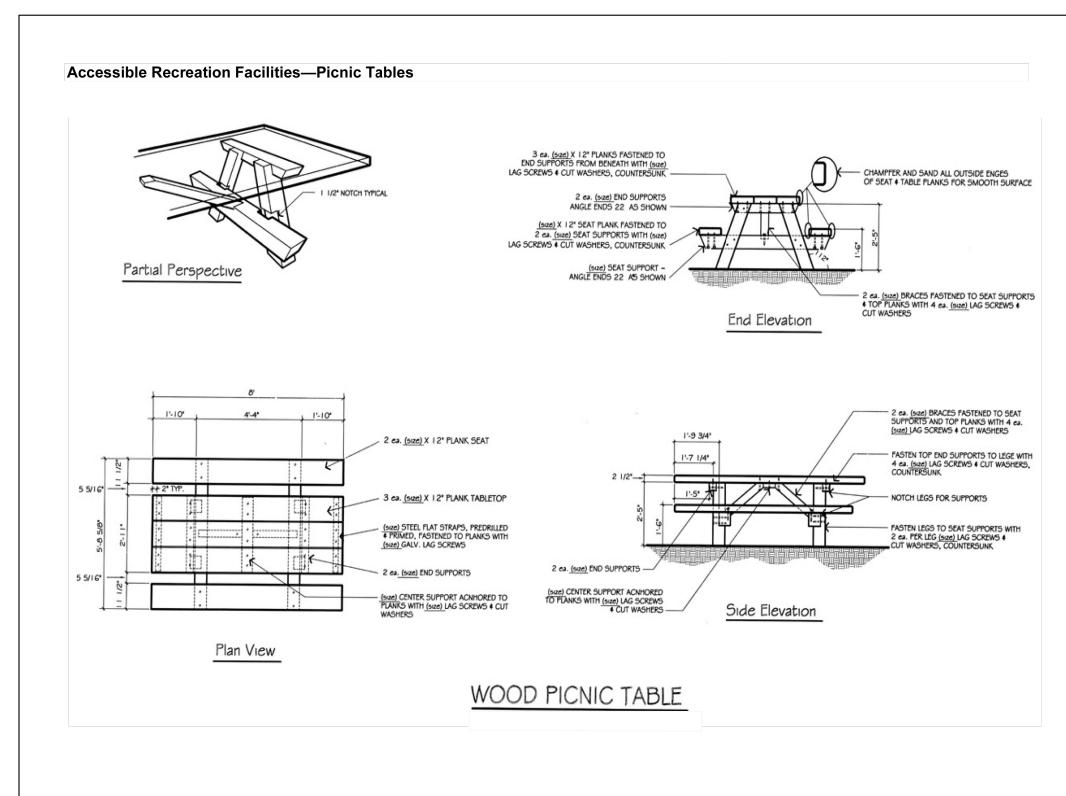

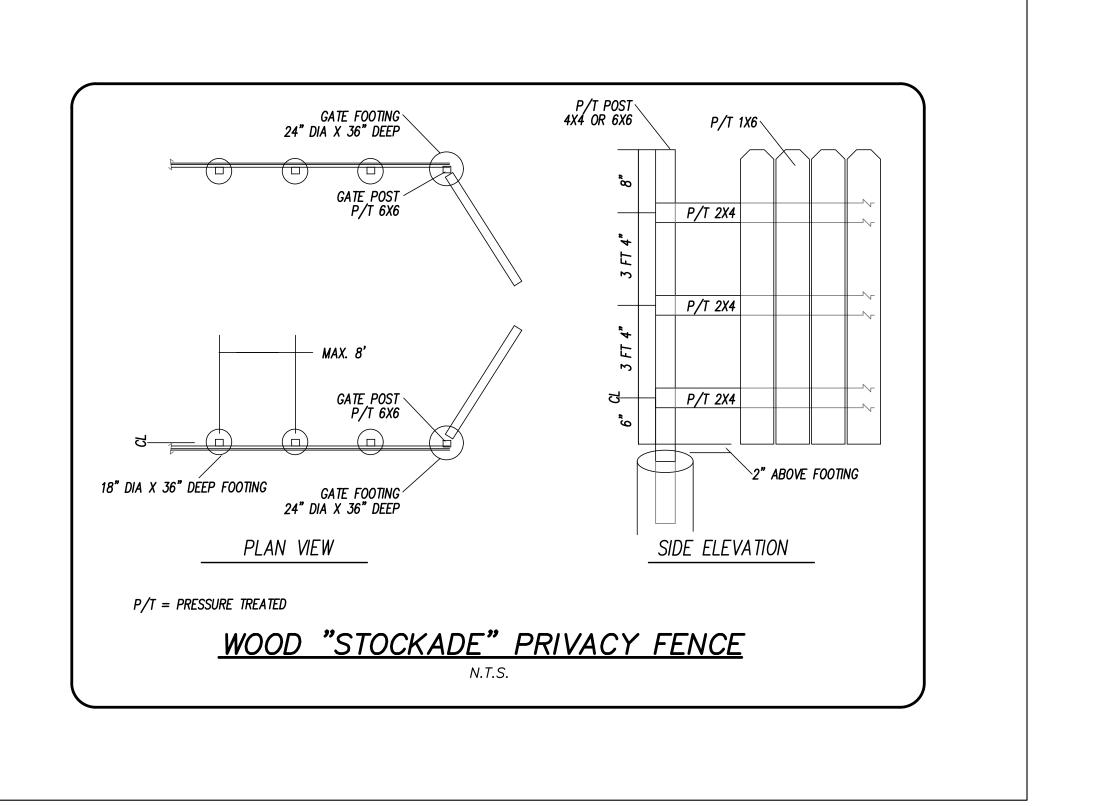



P.O. BOX 1250 WENDELL, NC 27591 (910) 791–4441

DETAIL DRAWINGS

DETAIL DR

SITE PLAN DRAWINGS FOR

FRANCO MASONRY & CONCRETE

LOCATED IN TOWN OF ZEBULON
WAKE COUNTY, NORTH CAROLINA

OWNER: FRANCO ROMERO
CONTACT: FRANCO ROMERO
370 MACK TODD ROAD
ZEBULON, NC 27597
(919) 255-0331




							BY DATE	
							ВУ	
							REMARKS	
							REV. NO.	
DATE: 8/2/2024								
HORZ. SCALE: 1" = 20' VERT. SCALE: N/A								


DRAWN BY: RBS


CHECKED BY: JFO


PROJECT NO.: 24-0682

Sheet No. <u>4</u> OF <u>14</u>

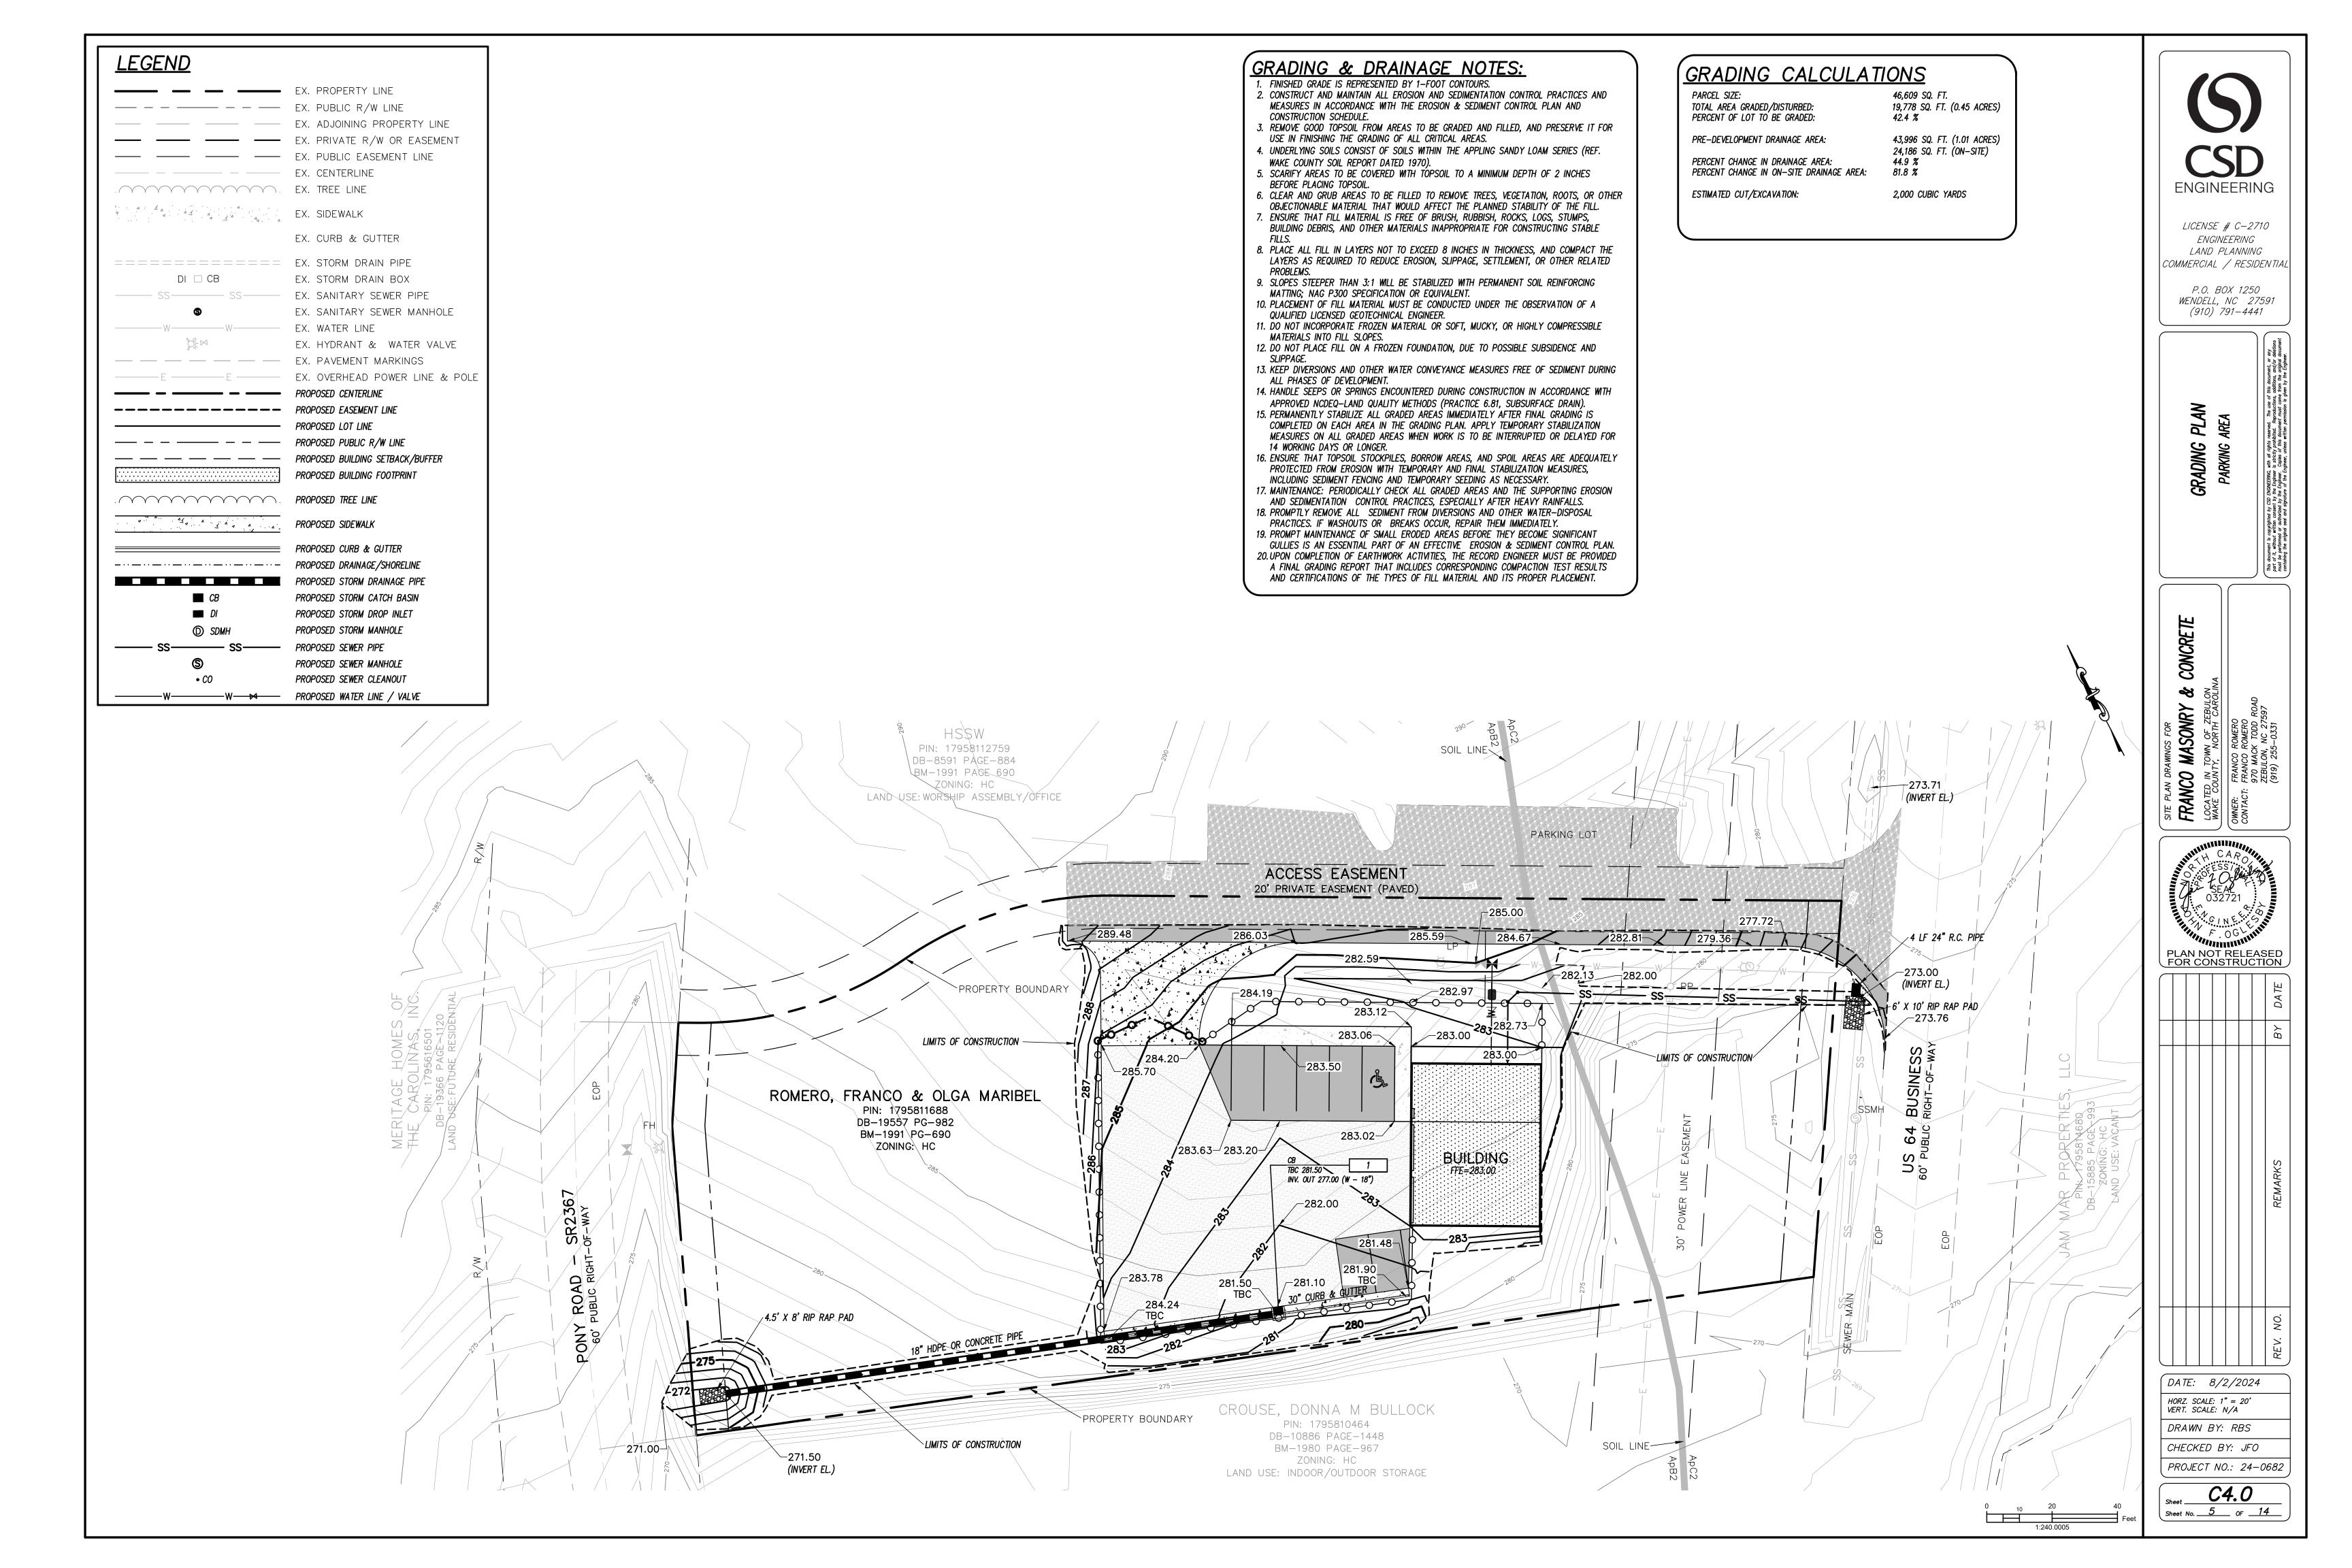

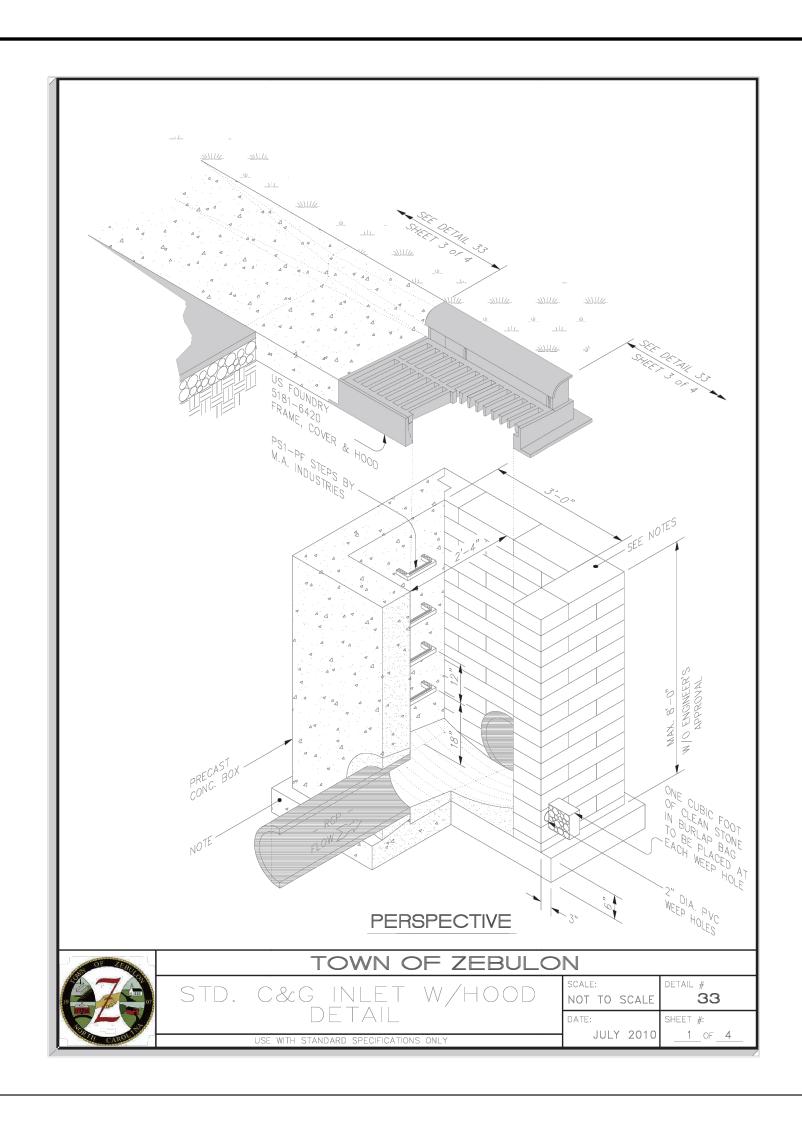

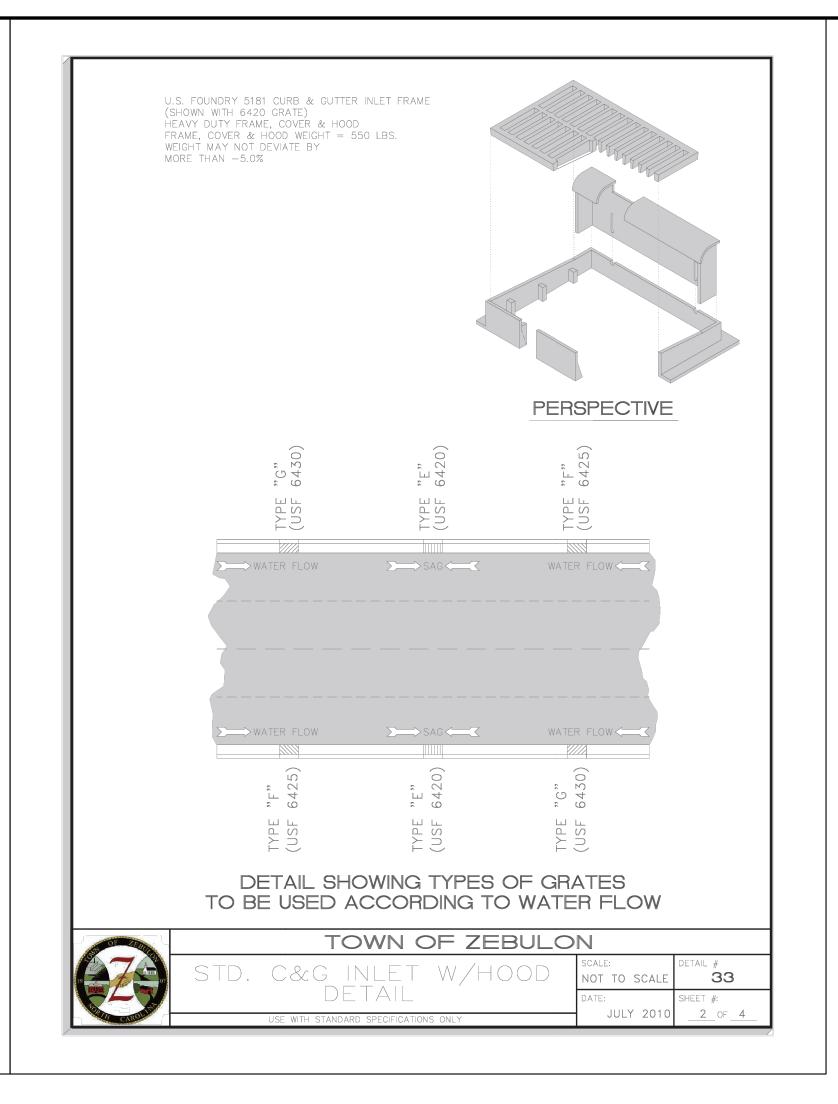

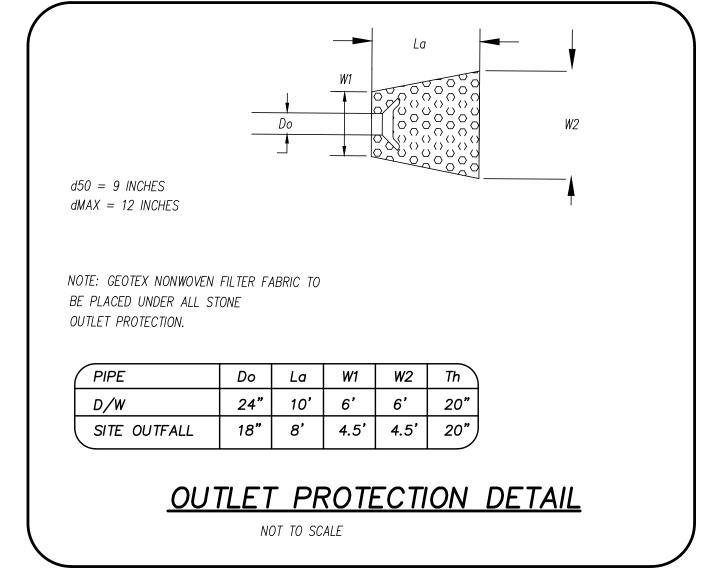




P.O. BOX 1250 WENDELL, NC 27591 (910) 791–4441

GRADING PLAN DETAIL SHEET

CONCRETE

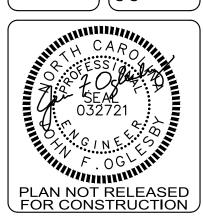



DATE: 8/2/2024 HORZ. SCALE: 1" = 20' VERT. SCALE: N/A

DRAWN BY: RBS CHECKED BY: JFO

Sheet No. 6 OF 14

PROJECT NO.: 24-0682

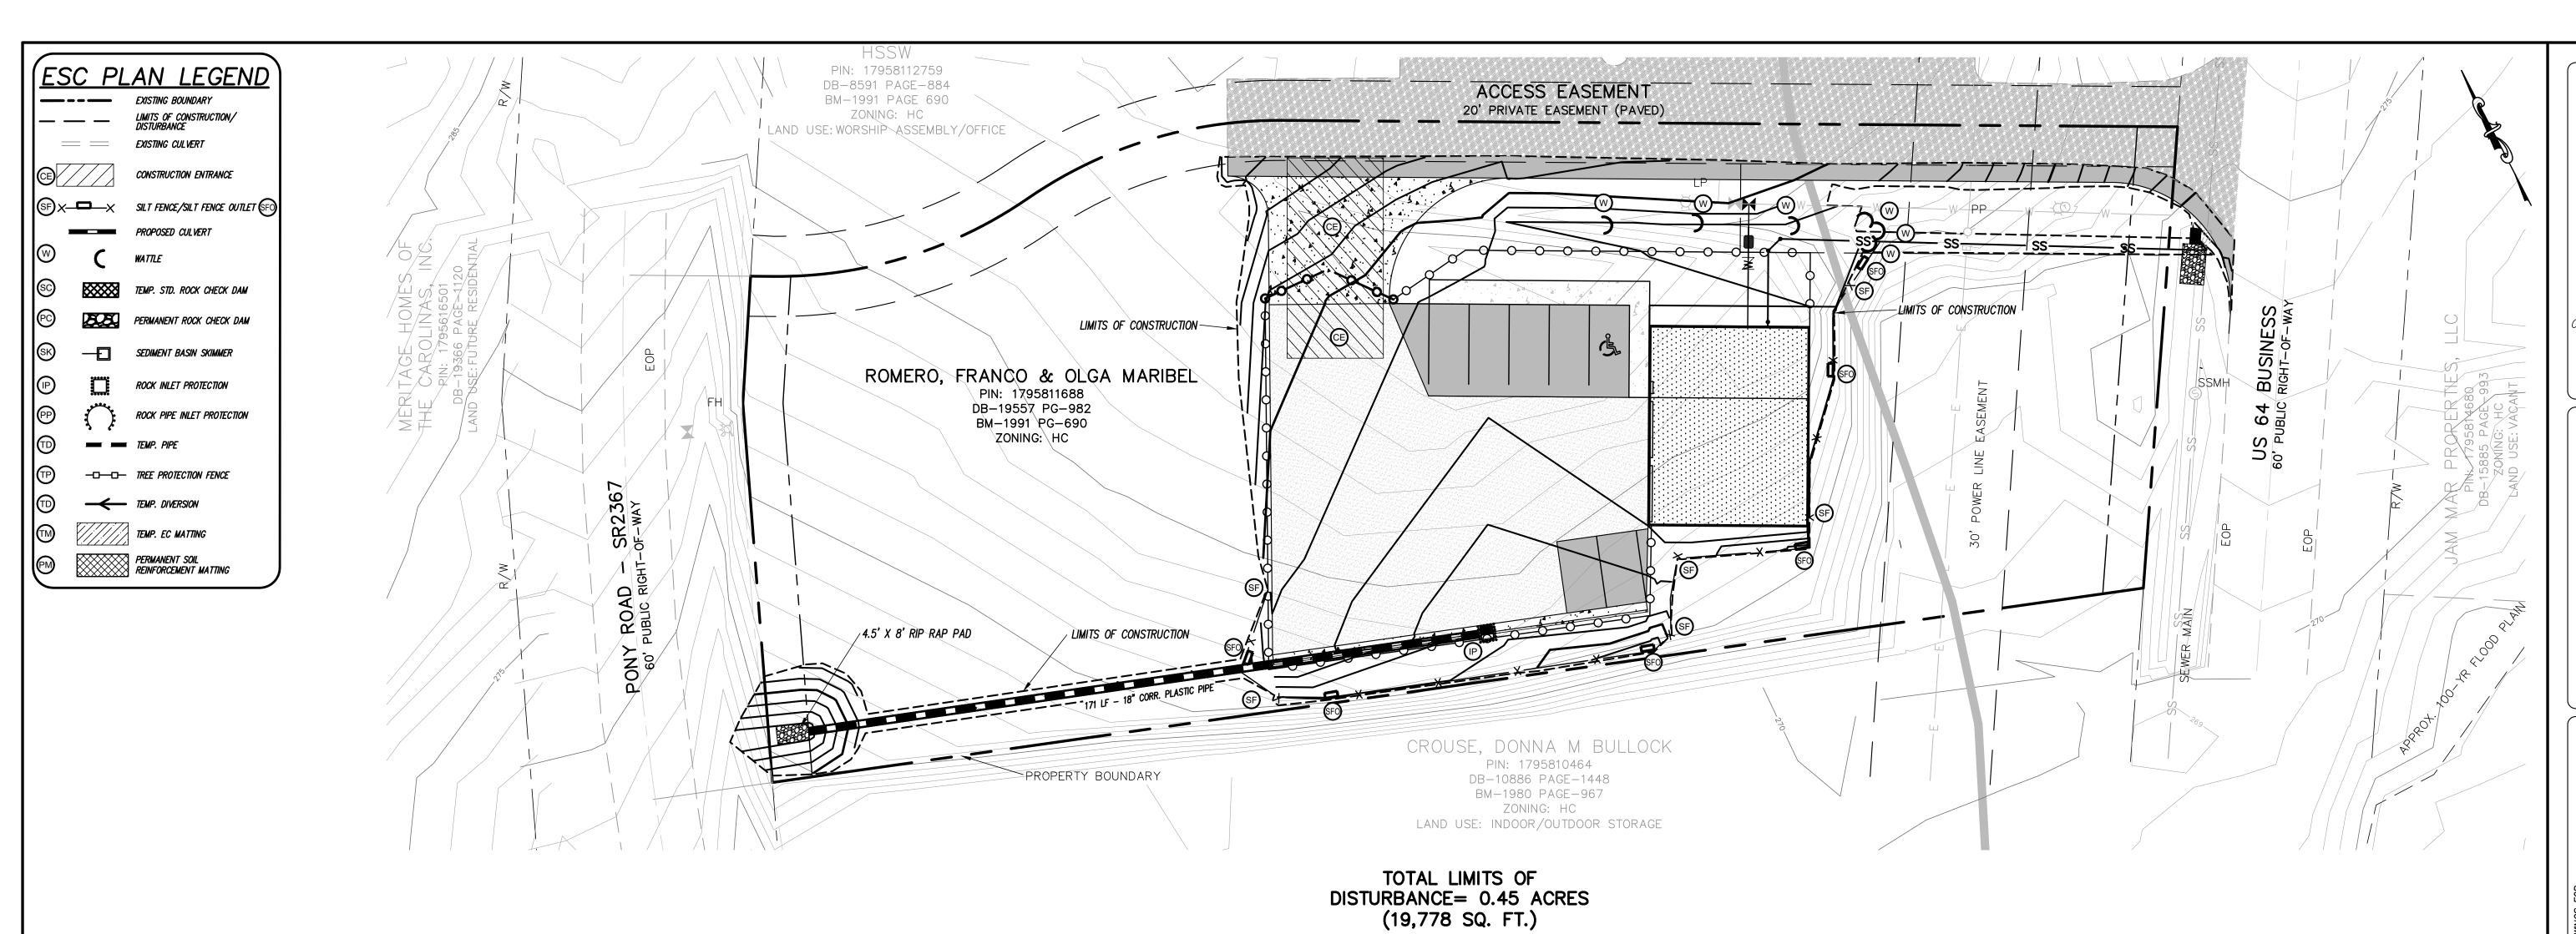

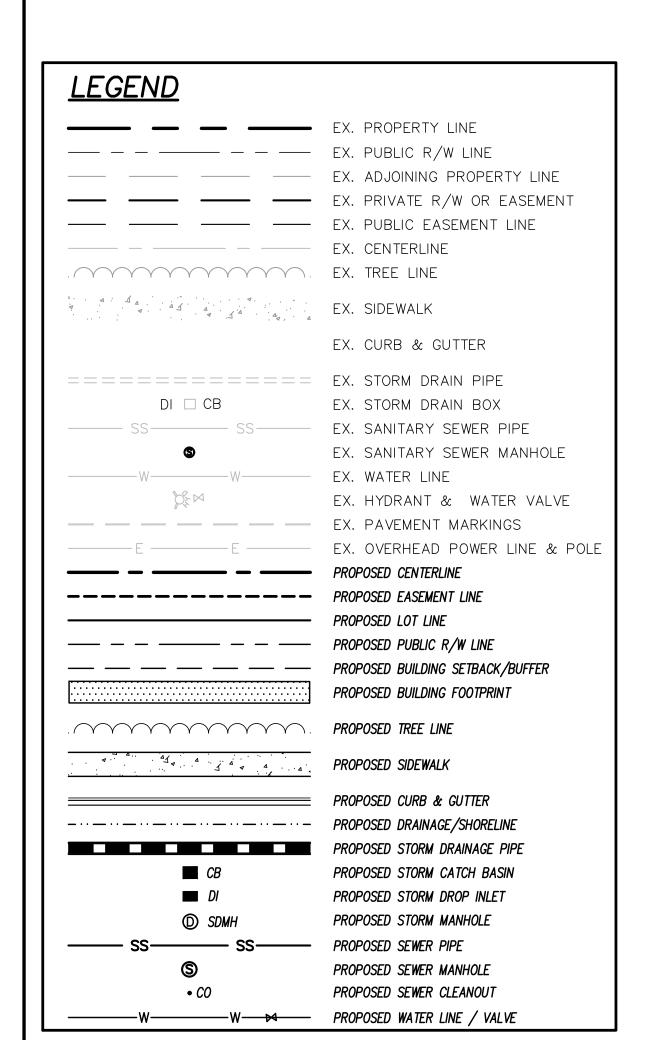

(CONSTRUCTION SEQUENCE:

. OBTAIN PLAN APPROVAL.


- 2. INSTALL SILT FENCE, SILT FENCE OUTLETS, CLEARING ONLY WHAT IS
- NEEDED TO INSTALL THESE MEASURES. 3. CLEAR AREA FOR CONSTRUCTION ENTRANCE AND INSTALL ROCK. 4. COMPLETE CLEARING AS SHOWN ON PLANS.
- 5. GRADE AREAS TO ELEVATIONS SHOWN ON GRADING PLAN; INSTALL
- STORM DRAINAGE PIPE WITH INLET AND OUTLET PROTECTION. ENSURE SUBGRADE SOILS ARE COMPACTED AND SUITABLE FOR INSTALLATION OF PARKING SURFACE TREATMENT AND BUILDING. PERMANENTLY STABILIZE DENUDED AREAS WITH SEED AND STRAW MULCH, AMENDING SOIL AS NECESSARY FOR HEALTHY VEGETATIVE
- INSTALL FENCE AND REQUIRED LANDSCAPING. REMOVE SILT FENCE, GRAVEL, AND RIP RAP; IMMEDIATELY STABILIZING AREAS DENUDED FOR REMOVAL OF EROSION AND SEDIMENT CONTROL MEASURES.

ENGINEERING

LICENSE # C-2710 ENGINEERING LAND PLANNING COMMERCIAL / RESIDENTIAL

P.O. BOX 1250 WENDELL, NC 27591 (910) 791–4441

CONCRETE FRANCO MASONRY
LOCATED IN TOWN OF ZEBULC
WAKE COUNTY, NORTH CARC
DWNER: FRANCO ROMERO

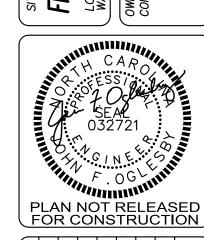


FOR CONSTRUCTION									
								DATE	
								ВУ	
								REMARKS	
								REV. NO.	
) A 7	E:	٤	3/2	2/2	202	24	$\overline{}$	
HORZ SCALE: 1" = 20'									


CHECKED BY: JFO PROJECT NO.: 24-0682


C5.0 Sheet No. <u>7</u> OF <u>14</u>

VERT. SCALE: N/A


DRAWN BY: RBS

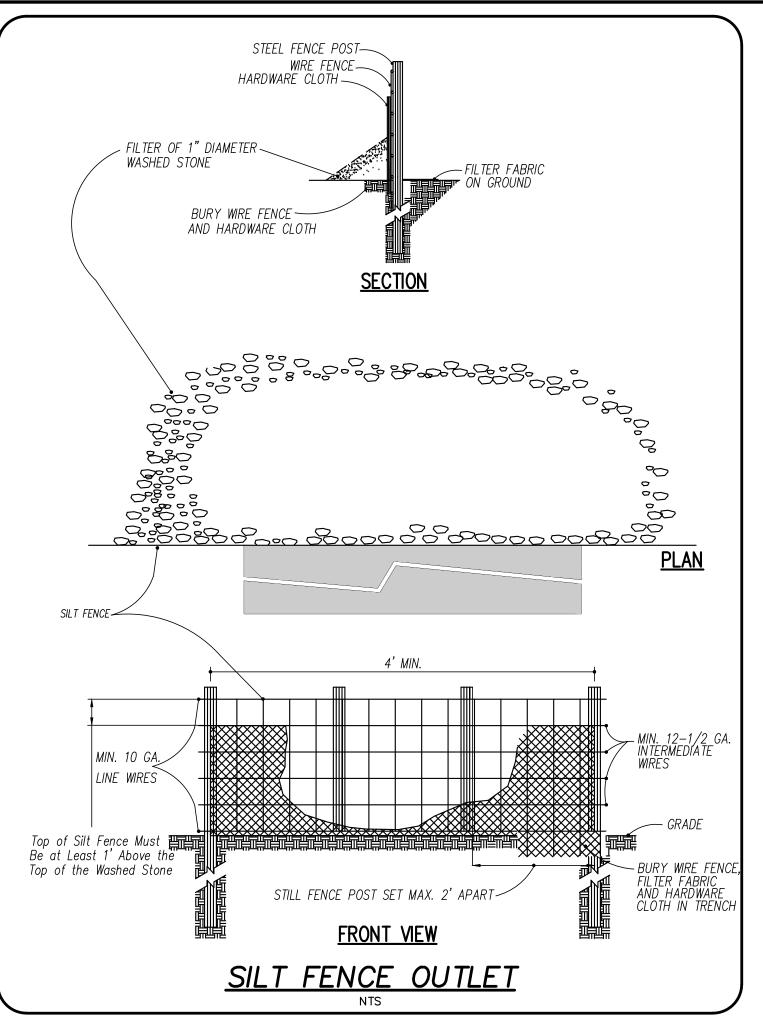

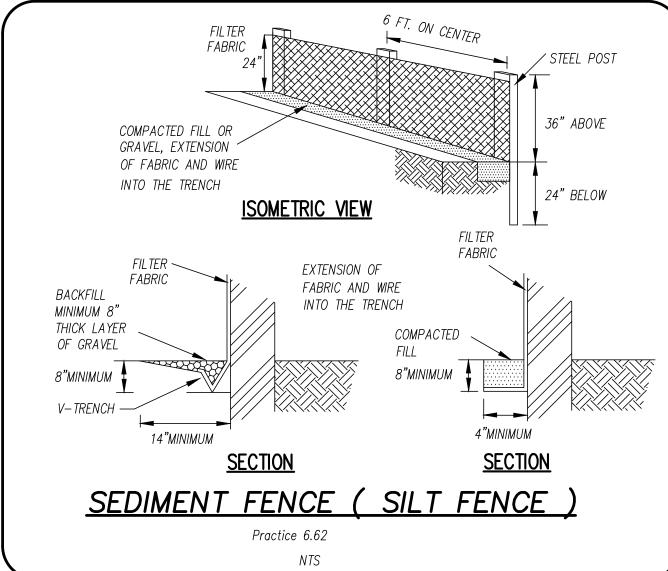

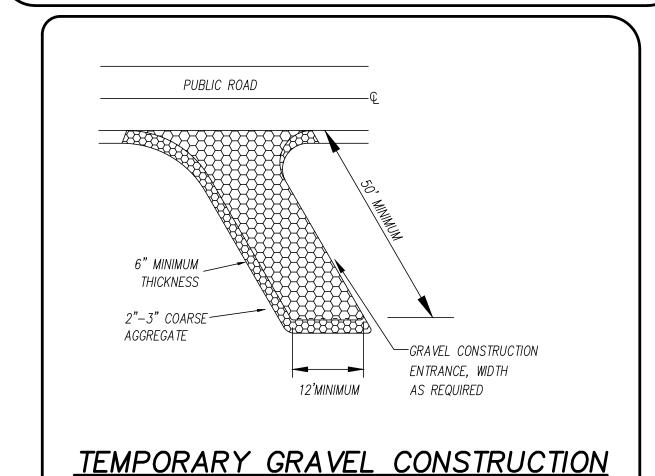

ENTRANCE/EXIT DETAIL

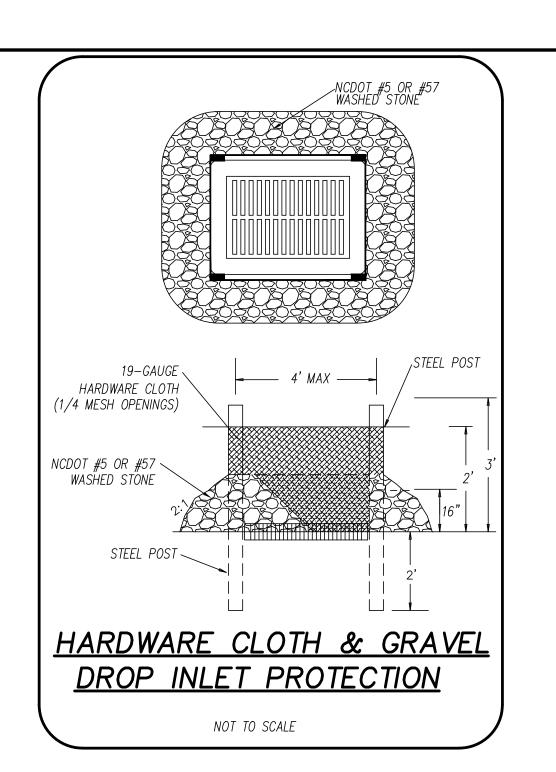

SOIL STABILIZATION GUIDELINES

<u>SEEDBED PREPARATION</u>

- CHISEL COMPACTED AREAS AND SPREAD TOPSOIL THREE INCHES DEEP OVER ADVERSE SOIL CONDITIONS.
- 2. RIP THE ENTIRE AREA FOUR (4) TO SIX (6) INCHES DEEP.
- REMOVE ALL LOOSE ROCK, ROOTS AND OTHER OBSTRUCTIONS, LEAVING SURFACE REASONABLY SMOOTH AND UNIFORM.
- I. APPLY AGRICULTURAL LIME, FERTILIZER AND SUPER—PHOSPHATE UNIFORMLY AND MIX WITH SOIL (SEE MIXTURE BELOW).
- 5. CONTINUE TILLAGE UNTIL A WELL-PULVERIZED, FIRM, REASONABLY UNIFORM SEEDBED IS PREPARED FOUR TO SIX INCHES DEEP.
- SEED ON A FRESHLY PREPARED SEEDBED AND COVER SEED LIGHTLY WITH SEEDING
- EQUIPMENT OR CULTI-PACK AFTER SEEDING.
- MULCH IMMEDIATELY AFTER SEEDING AND ANCHOR MULCH. . INSPECT ALL SEEDED AREAS AND MAKE NECESSARY REPAIRS OR RE—SEEDING WITHIN THE PLANTING SEASON, IF POSSIBLE. IF STAND SHOULD BE MORE THAN 60% DAMAGED, RE-ESTABLISH FOLLOWING THE ORIGINAL LIME, FERTILIZER AND SEEDING
- CONSULT N.C. STATE COOPERATIVE EXTENSION SERVICE ON MAINTENANCE TREATMENT AND FERTILIZATION AFTER PERMANENT COVER IS ESTABLISHED.

LOCAL CONDITIONS; OTHER SEEDING RATE COMBINATIONS ARE POSSIBLE.

10. CONSULT N.C. STATE COOPERATIVE EXTENSION SERVICE FOR ADDITIONAL INFORMATION CONCERNING OTHER ALTERNATIVES FOR VEGETATION OF DENUDED

AREAS. THE VEGETATION RATES OUTLINED BELOW ARE THOSE THAT DO WELL UNDER

<u>MIXTURE</u>

FERTILIZER SUPER-PHOSPHATE

ANCHOR

AGRICULTURAL LIMESTONE 2 TONS/ACRE (3 TONS/ACRE IN CLAY SOILS) 1,000 LBS/ACRE - 10-10-10 500 LBS/ACRE - 20% ANALYSIS 2 TONS/ACRE — SMALL GRAIN STRAW ASPHALT EMULSION AT 300 GALS/ACRE

SEEDING SCHEDULE

FOR SHOULDERS, SLOPES (3:1 MAX):

DATE	TYPE	PLANTING RATE
AUG 15-MAR 1	NON-HULLED BERMUDAGRASS	25 LBS/ACRE
	AND ABRUZZI RYE	·

FOR SHOULDERS, SLOPES (3:1 MAX):

<u>DATE</u>	TYPE	PLANTING RATE
MAR 1-JUN 30	WEEPING LOVE GRASS	8 LBS/ACRE
MAR 1-JUN 30	ADD HULLED COMMON	
	BERMUDAGRAS	25 LBS/ACRE
NOV 1-MAR 1	NON-HULLED BERMUDAGRASS	25 LBS/ACRE
	AND ABRUZZI RYE	

***TEMPORARY: RESEED ACCORDING TO OPTIMUM SEASON FOR DESIRED PERMANENT VEGETATION. DO NOT ALLOW TEMPORARY COVER TO GROW MORE THAN 12" IN HEIGHT BEFORE MOWING.

FOR WELL-KEPT HIGH-VISIBILITY AREAS (INCLUDING BUT NOT LIMITED TO WATER QUALITY SWALES, BERMS, LAWNS, AND/OR SIDEWALK BERMS:

DATE	TYPE	PLANTING RATE
AUG 15-NOV 1	CENTIPEDEGRASS	10–20 LBS/ACRE
APR 15-JUN 30	HULLED COMMON BE	ERMUDAGRASS 25 LBS/ACI

**BERMUDAGRASS SOD IS RECOMMENDED FOR WATERQUALITY SWALES

REMOVE LITTER AND OTHER DEBRIS; MOW AND SATISFACTORILY DISPOSE OF WEEDS AND UNACCEPTABLE GROWTH ON AREAS TO BE SODDED. BRING AREA TO A UNIFORM SURFACE; SCARIFY OR OTHERWISE LOOSEN SOIL TO A DEPTH OF 4 TO 5 INCHES. BREAK CLODS AND WORK TOP 2 TO 3 INCHES OF SOIL INTO ACCEPTABLE SOIL BED BY USING PULVERIZERS, DRAGS OR HARROWS.

PLACE LIMESTONE AND FERTILIZER BEFORE PLACING SOD. DISTRIBUTE UNIFORMLY OVER THE AREA THOROUGHLY MIX IN THE TOP 4 INCHES OF THE SOIL BY DISKING, HARROWING, OR OTHER APPROVED METHOD.

CONTACT STATE COOPERATIVE EXTENSION FOR SEASONAL LIMITATION FOR SOD AND THE KIND OF SOD TO USE. INSTALL THE SOD WITHIN 48 HOURS AFTER BE CUT AND WATER IMMEDIATELY AFTER INSTALLATION. PLACE SOD FIRMLY AND CAREFULLY BY HAND: PACK EACH PIECE OF SOD TIGHTLY AGAINST THE THE EDGE OF ADJACENT PIECES SO THAT FEWEST POSSIBLE GAPS WILL BE LEFT BETWEEN PIECES.

<u>PLUGS</u>

FOLLOW SEEDBED PREPARATION TO PREPARE SOIL FOR PLANTING OF PLUGS. WATER THE GROUND BEFORE PLANTING GRASS PLUGS. PLANT PLUGS IN HOLE THAT IS THE SAME SIZE AS PLUG (2.5" TO 4") TO OBTAIN GOOD SOIL CONTACT. DO NOT PLANT TOO DEEP OR ALLOW PLUG TO STICK OUT ABOVE GROUND LEVEL, COVERING THE ENTIRE ROOT BALL WITH SOIL (DO NOT COVER GRASS PLUG TOPS WITH SOIL). PLANT PLUGS 2 FEET APART IN THE ROW. DO NOT MULCH. FERTILIZE VERY WITH 20 LBS/ACRE NITROGEN IN SPRING WITH NO PHOSPHORUS. WATER AFTER PLANTING AND EVERY DAY FOR 2 TO 3 WEEKS.

EROSION CONTROL MATTING

TM TEMPORARY: NAG S75 OR EXCELSIOR SINGLE NET MATTING (OR EQUIVALENT) OR NAG S150 FOR HIGHER VELOCITIES (ROADSIDE CHANNEL)

PM PERMANENT: NAG SC250 (OR EQUIVALENT)

MAINTENANCE PLAN

- ALL MEASURES ARE TO BE INSPECTED WEEKLY AND AFTER ANY RAINFALL; REPAIRS MADE IMMEDIATELY IF NECESSARY. SEDIMENT IS TO BE REMOVED FROM SWALES AND DIVERSIONS WHEN THEY
- ARE APPROX. 50% FILLED OR WHEN SEDIMENT LEVEL IS WITHIN 1.0' OF TOP OF BANK. SEDIMENT IS TO BE REMOVED FROM SILT FENCE MEASURES WHEN 0.5'
- DEEP; FABRIC AND STONE TO BE REPAIRED AS NEEDED TO MAINTAIN A SEDIMENT BARRIER. SEEDED AREAS SHALL BE FERTILIZED, MULCHED, AND RE-SEEDED AS
- NECESSARY, ACCORDING TO THE SPECIFICATIONS PROVIDED, TO MAINTAIN A SUITABLE VEGETATIVE COVER. THE CONSTRUCTION ENTRANCE SHALL BE MAINTAINED IN SUCH A MANNER AS TO PREVENT MUD OR SEDIMENT FROM LEAVING THE CONSTRUCTION SITE; TOP DRESSING WITH 2-INCH STONE MAY BE
- IMMEDIATELY REMOVE SEDIMENT SPILLED, WASHED, OR TRACKED ONTO PUBLIC ROADWAYS.
- INSPECT CHECK DAMS AND WATTLES AS DIRECTED AND CLEAR STONE OR NETTING OF DEBRIS AND ACCUMULATED SEDIMENT; TAKE CARE NOT TO DAMAGE OR UNDERCUT THE MEASURES DURING SEDIMENT REMOVAL; REPLACE SEDIMENT STONE OR WATTLE AS NEEDED.
- REFER TO MAINTENANCE SPECIFICATIONS AND REQUIREMENTS IN THE NORTH CAROLINA "EROSION AND SEDIMENT CONTROL PLANNING AND DESIGN MANUAL."

SOIL STABILIZATION NOTES 1. SOIL STABILIZATION TIMEFRAMES:

SITE AREA DESCRIPTION	STABILIZATION	TIMEFRAME EXCEPTIONS
PERIMETER DIKES,SWALES	7 DAYS	NONE
DITCHES AND SLOPES		
HIGH QUALITY ZONES (HQW)	7 DAYS	NONE
SLOPES STEEPER THAN 3:1	7 DAYS	IF SLOPES ARE 10 FT OR LESS IN LENGTH
		AND ARE ARE NOT STEEPER THAN 2:1,
		14 DAYS ARE ALLOWED
SLOPES 3:1 OR FLATTER	14 DAYS	7 DAYS FOR SLOPES GREATER THAN
		50 FT IN LENGTH
ALL OTHER AREAS WITH SLOPES	14 DAYS	NONE, EXCEPT FOR PERIMETER AND
FLATTER THAN 4:1		HQW ZONES

- 2. DENUDED AREAS MUST BE STABILIZED WITHIN FIFTEEN (15) WORKING DAYS OF CEASE OF ANY PHASE OF ACTIVITY. ALL SLOPES MUST BE STABILIZED WITHIN TWENTY-ONE (21) CALENDAR DAYS OF CEASE OF ANY PHASE OF ACTIVITY. THIS INCLUDES SLOPES, SWALES, CHANNELS AND STOCKPILES.
- ALL FINISHED SLOPES SHALL BE 3:1 OR FLATTER.
- 5. SEE STABILIZATION GUIDELINES ON SUBSEQUENT SHEETS.
- 4. NO WETLANDS EXIST WITHIN LIMITS OF DISTURBANCE.

PLAN NOT RELEASED FOR CONSTRUCTION DATE: 8/2/2024 HORZ. SCALE: 1" = 20'

ENGINEERING

LICENSE # C-2710

ENGINEERING

LAND PLANNING

COMMERCIAL / RESIDENTIAL

P.O. BOX 1250

WENDELL, NC 27591

(910) 791–4441

EROSION


CONCRETE


VERT. SCALE: N/A


DRAWN BY: RBS CHECKED BY: JFO


Sheet No. <u>8</u> OF <u>14</u>

PROJECT NO.: 24-0682

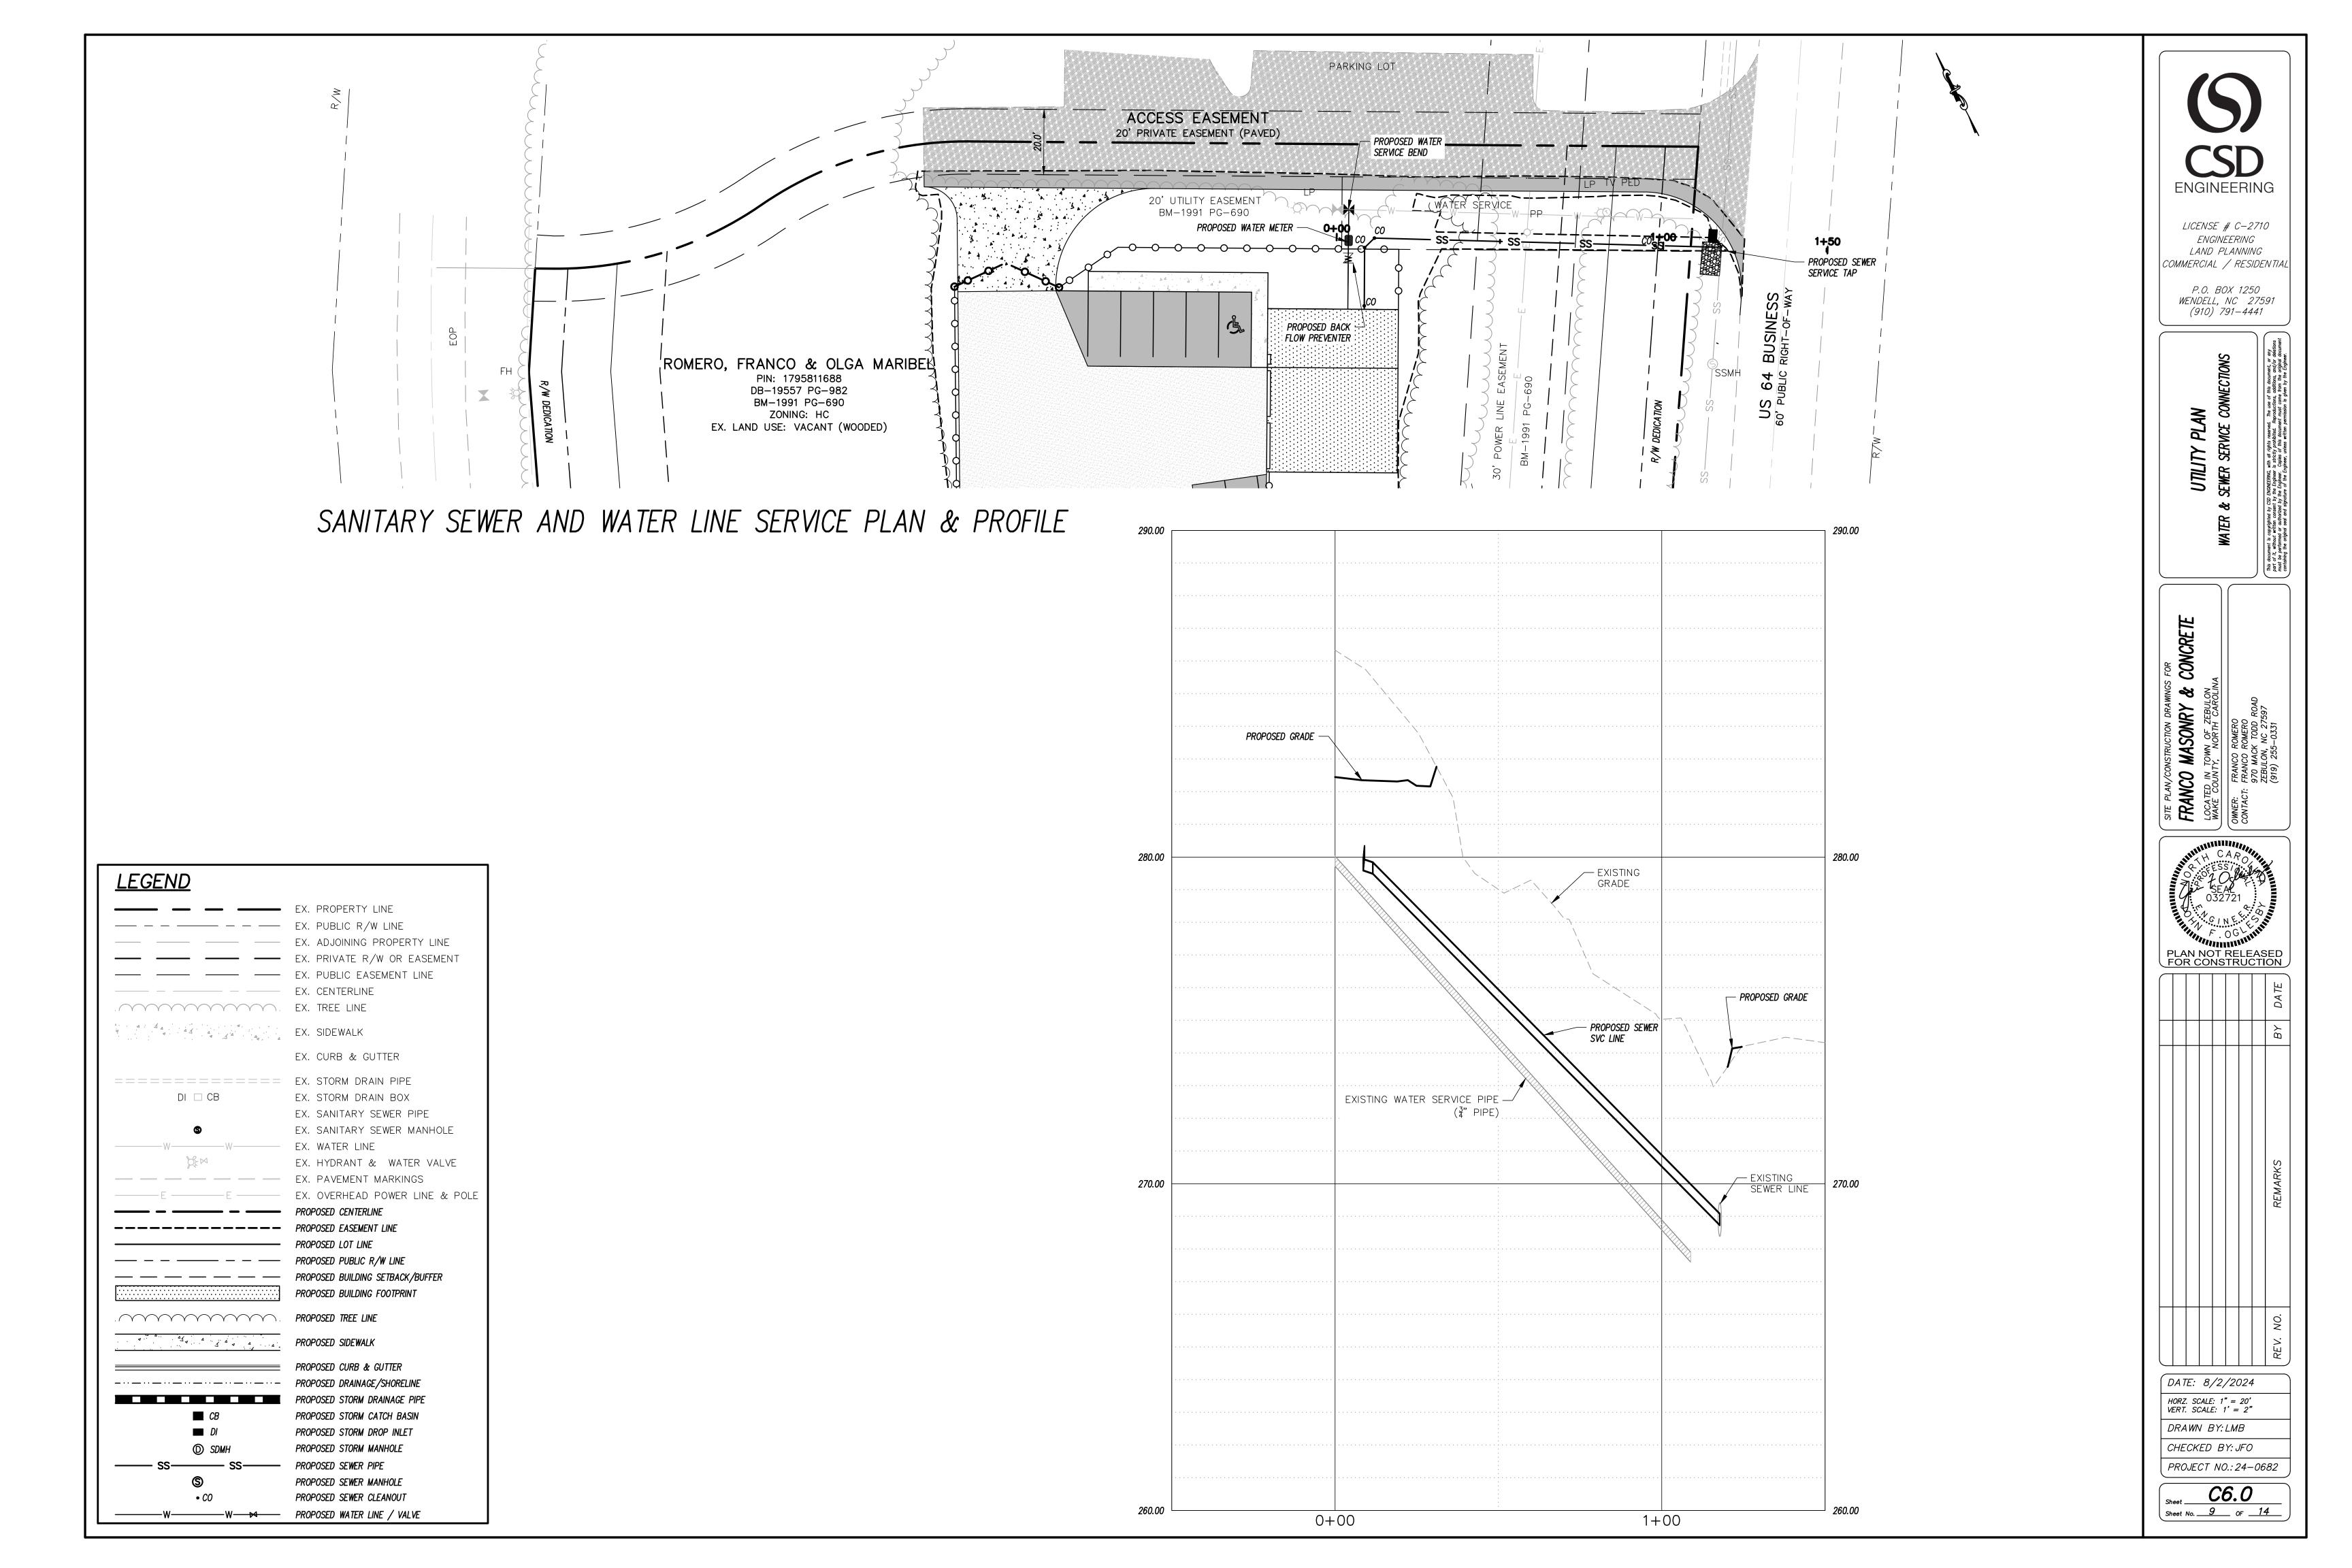

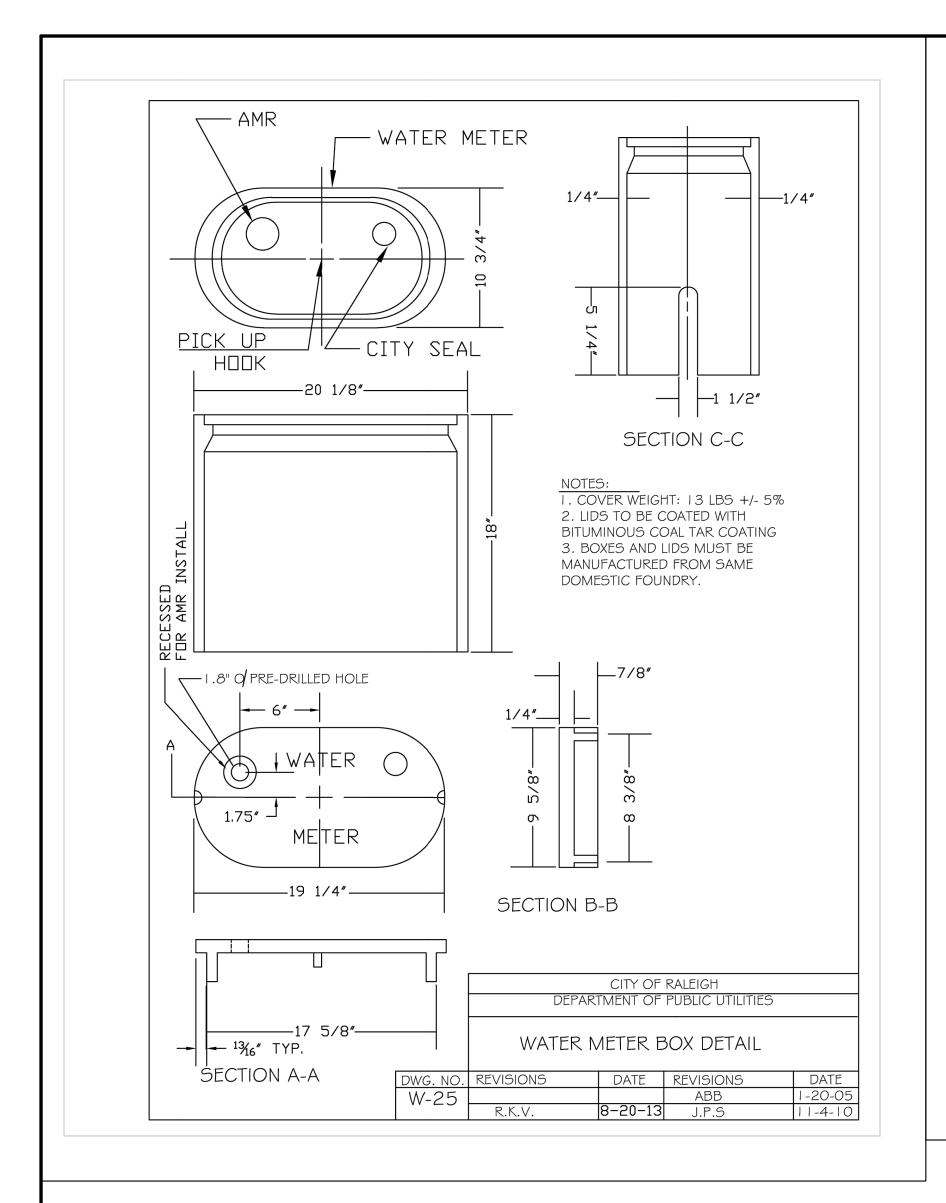

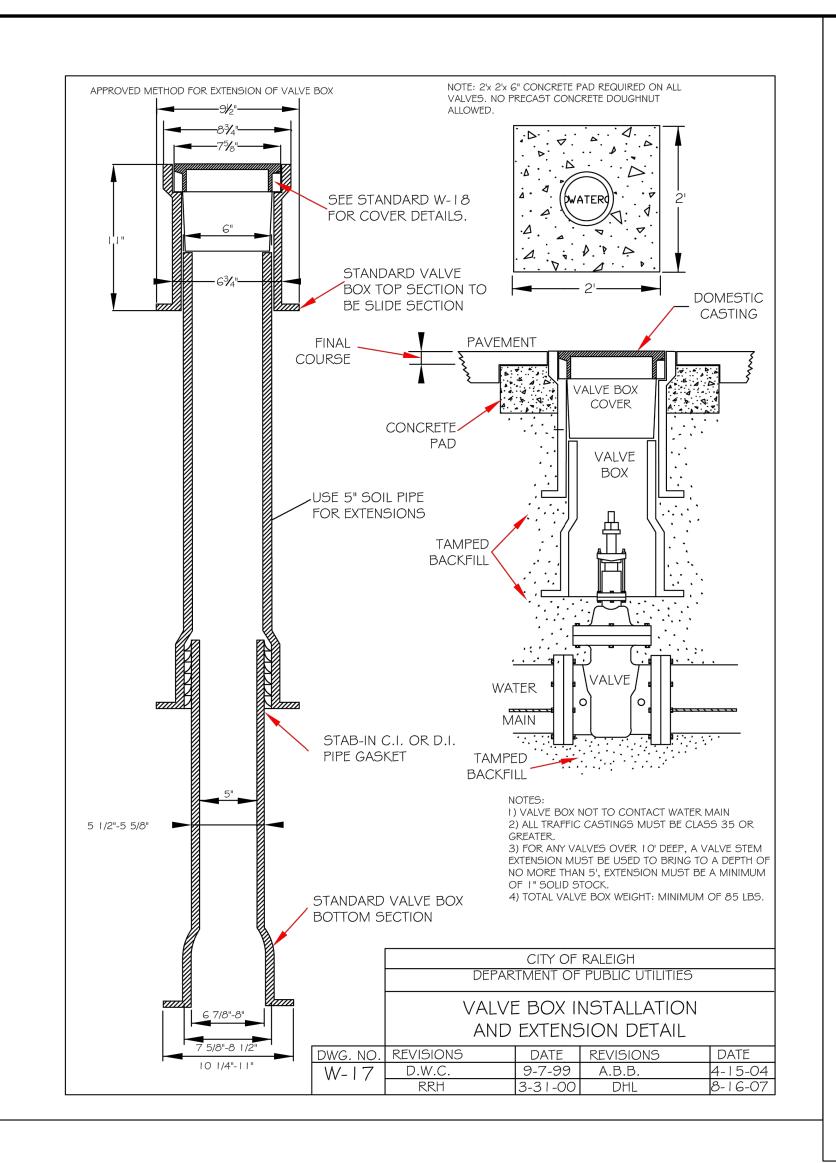

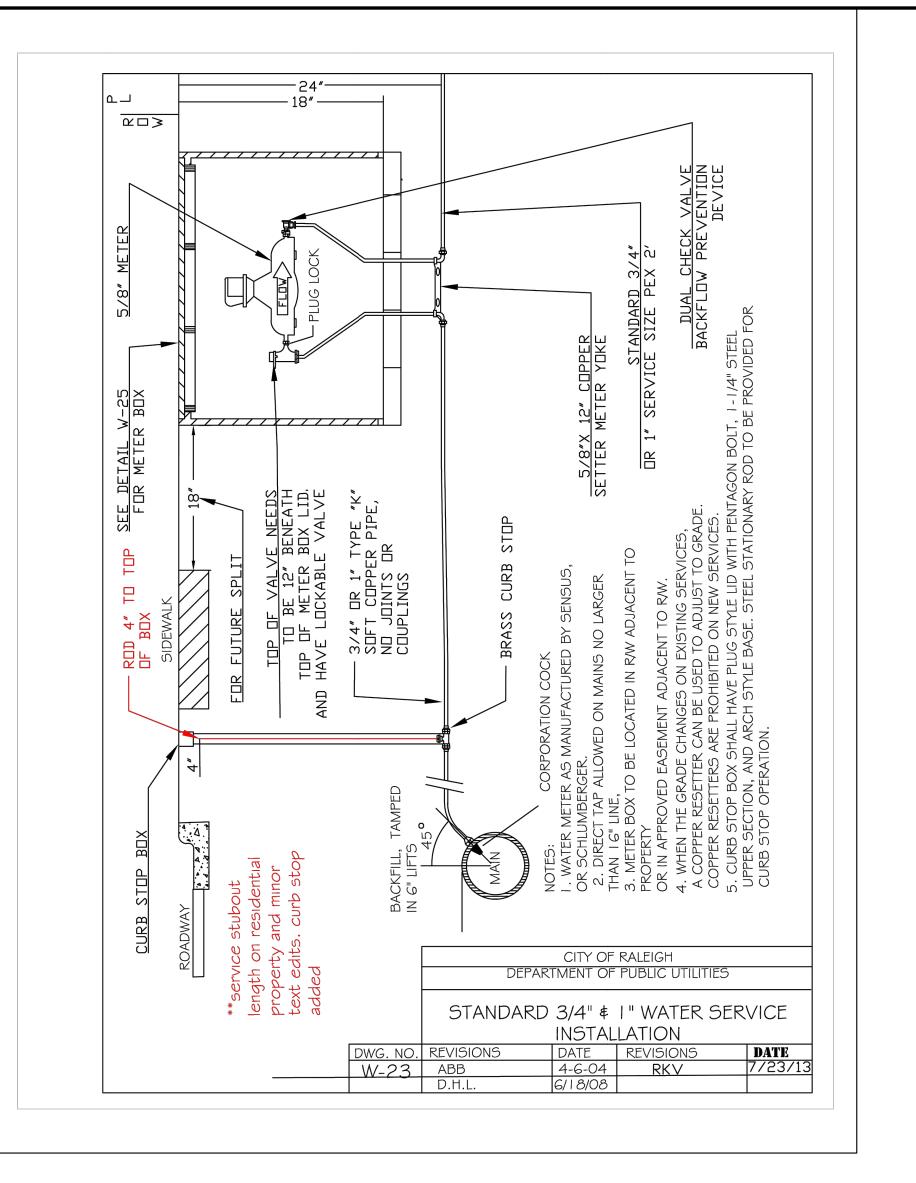



P.O. BOX 1250 WENDELL, NC 27591 (910) 791–4441

' DETAILS — CITY OF I

UTILITY




_						 	
							BY DATE
							BY
							REMARKS
							REV. NO.
DATE							

HORZ. SCALE: 1" = 20' VERT. SCALE: N/A DRAWN BY:LMB

CHECKED BY: JFO PROJECT NO.: 24-0682

Sheet No. ________OF ________14

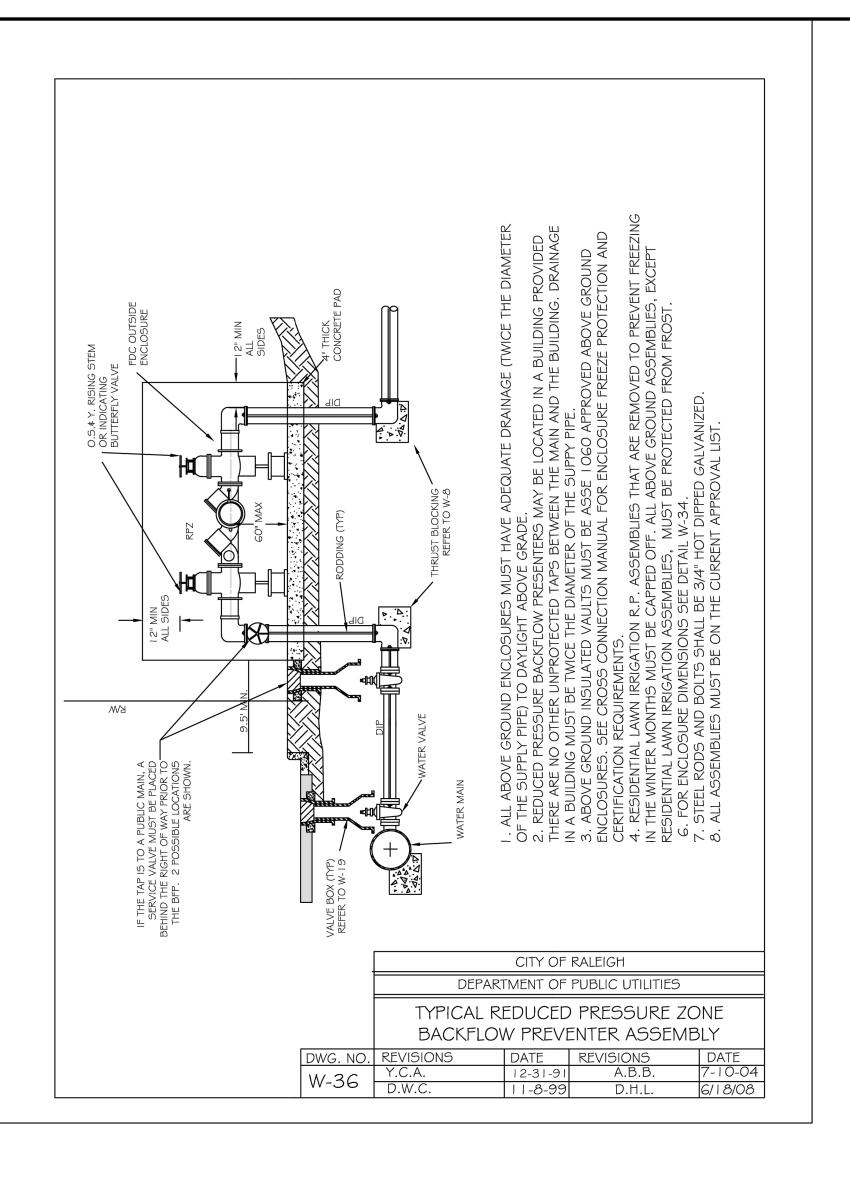



P.O. BOX 1250 WENDELL, NC 27591 (910) 791–4441

UTILITY DETAILS — CITY OF RALEIGH Water Standard Details


PLAN NOT RELEASED FOR CONSTRUCTION

HORZ. SCALE: 1" = 20' VERT. SCALE: N/A

DRAWN BY:LMB

CHECKED BY: JFO PROJECT NO.: 24-0682

Sheet **C6.2**

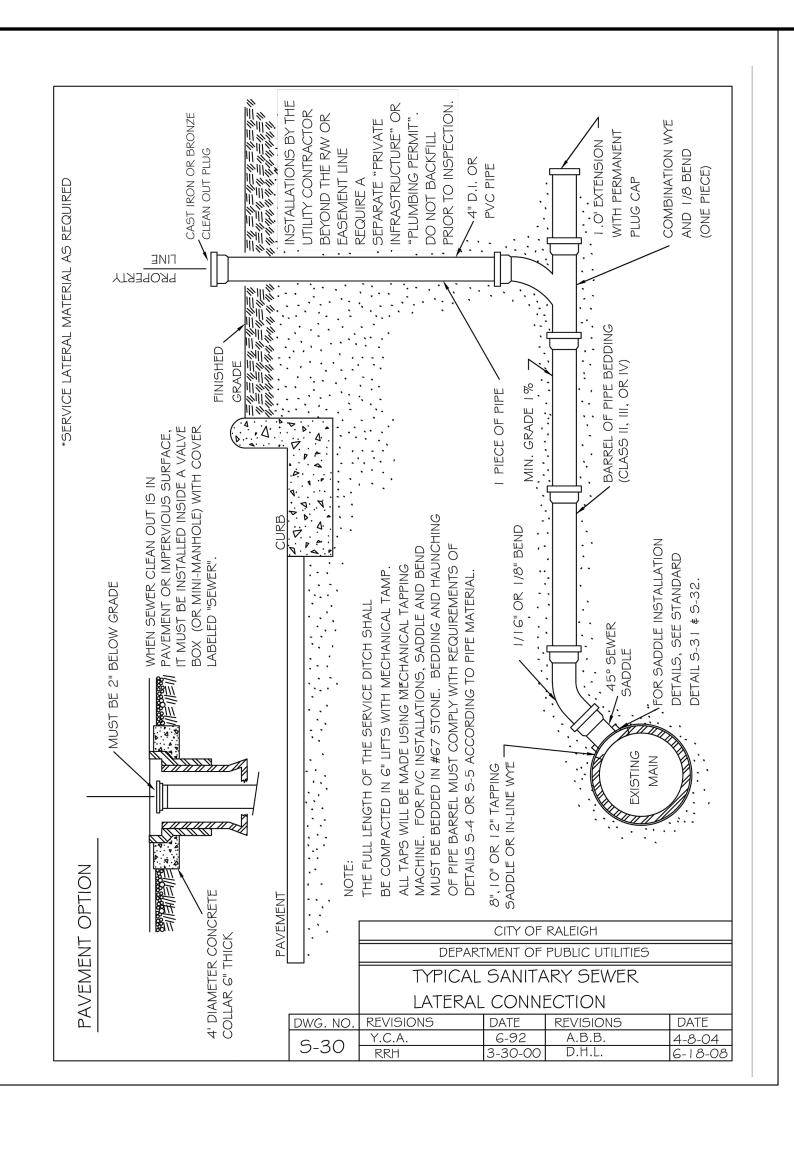

CSDENGINEERING

LICENSE # C-2710 ENGINEERING LAND PLANNING COMMERCIAL / RESIDENTIAL

P.O. BOX 1250 WENDELL, NC 27591 (910) 791–4441

UTILITY DETAILS — CITY OF RALEIGH SANITARY SEWER STANDARD DETAILS

FRANCO MASONRY & CONCRETE

LOCATED IN TOWN OF ZEBULON
WAKE COUNTY, NORTH CAROLINA

OWNER: FRANCO ROMERO

CONTACT: FRANCO ROMERO

970 MACK TODD ROAD
ZEBULON, NC 27597
(919) 255-0331


PLAN NOT RELEASED FOR CONSTRUCTION

HORZ. SCALE: 1" = 20' VERT. SCALE: N/A

DRAWN BY:LMB CHECKED BY: JFO

PROJECT NO.: 24-0682

Sheet **C6.3** Sheet No. <u>12</u> OF <u>14</u>

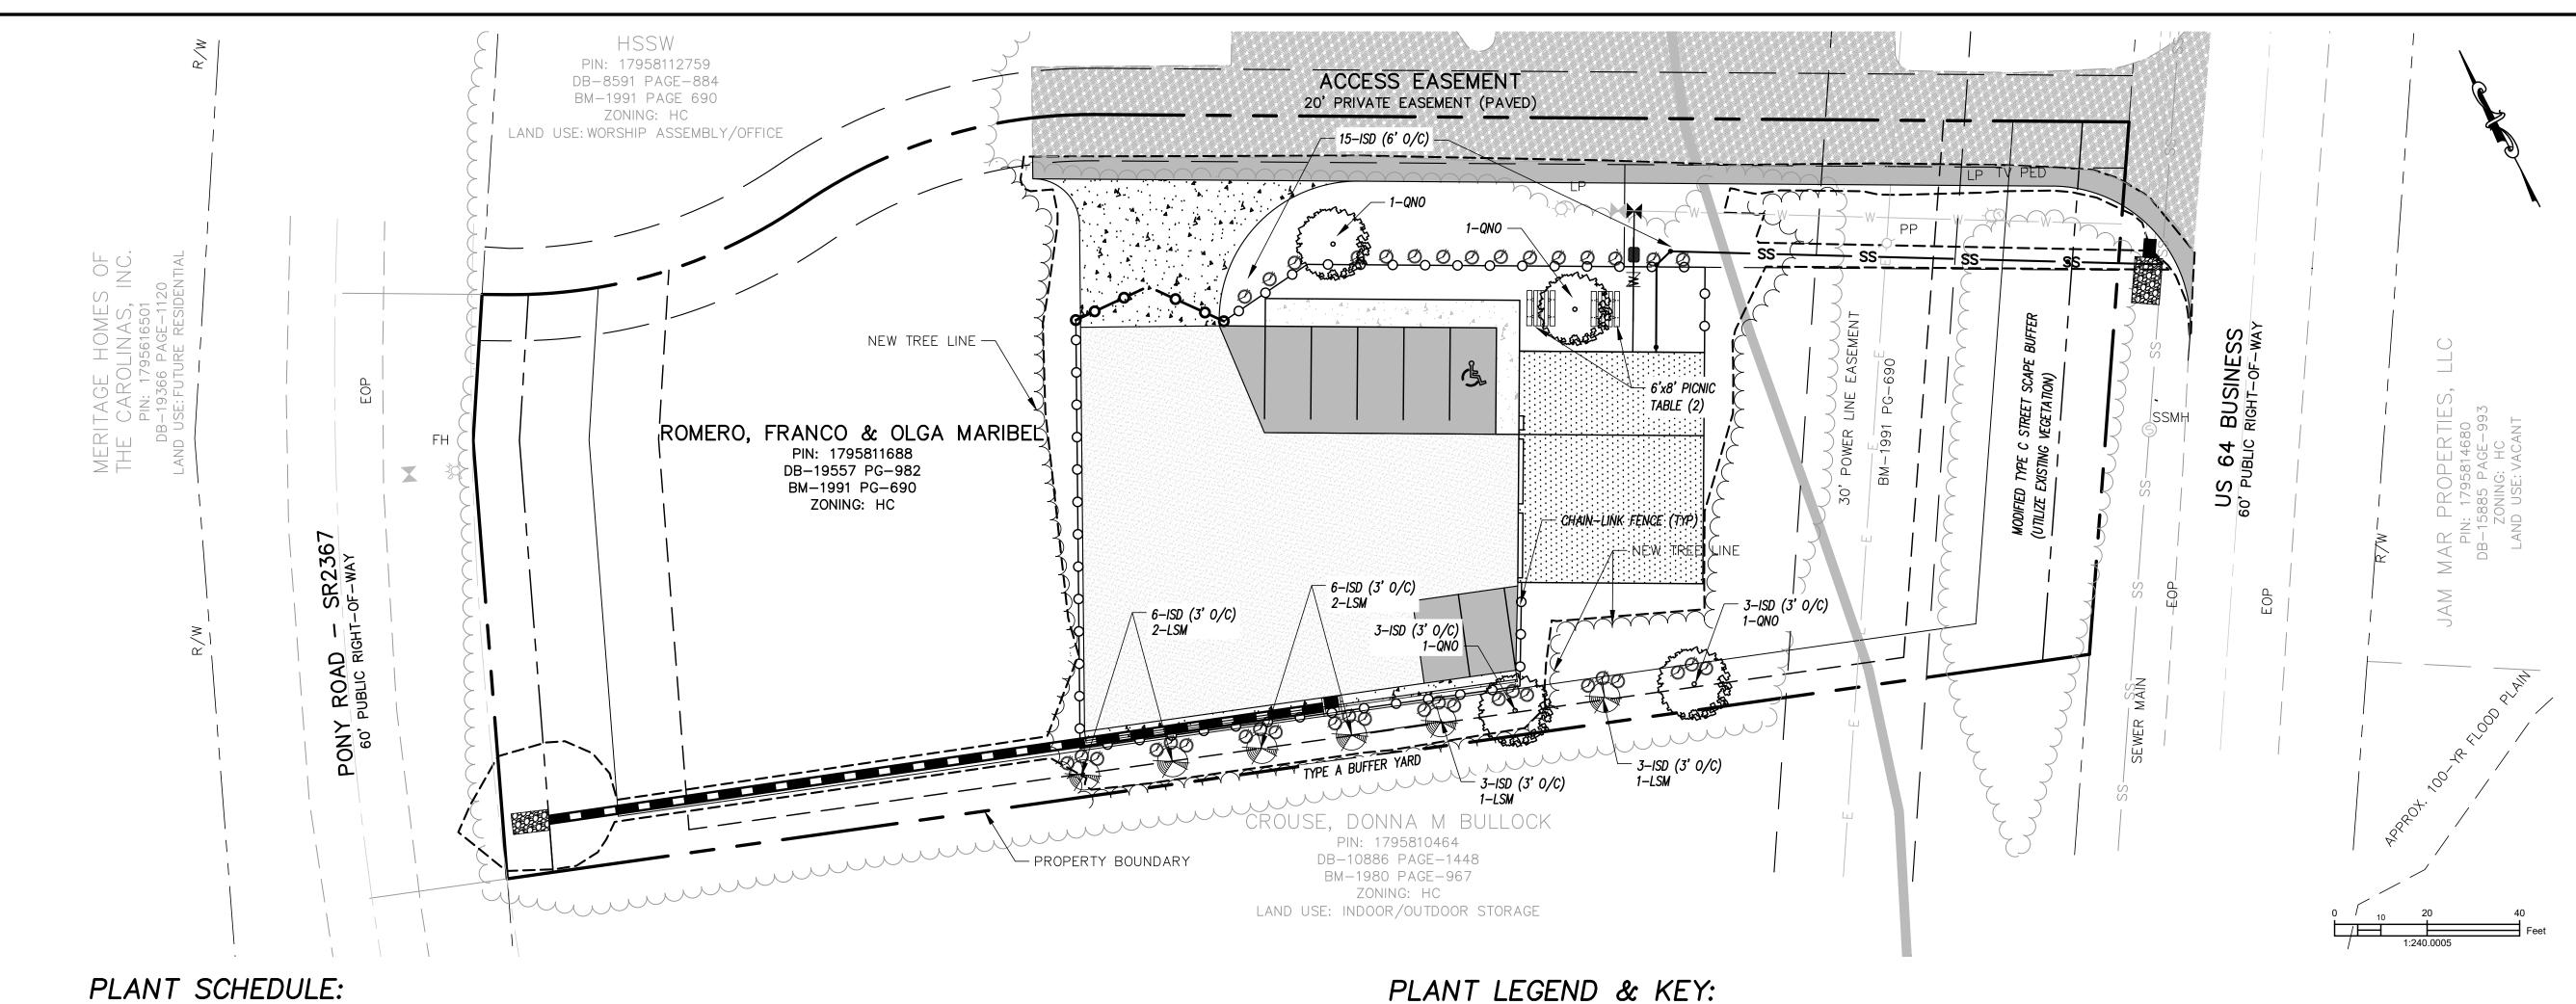

MATURE HT.

40' - 80'

PLANTING HT. PLANTING SIZE ROOT

3 GALLON

1.5" CALIPER

CONTAINER

BALLED & BURLAPPED

1.5" CALIPER BALLED & BURLAPPED 20' – 30'

<u>LEGEND</u>	
	EX. PROPERTY LINE
	EX. PUBLIC R/W LINE
	EX. ADJOINING PROPERTY LINE
	EX. PRIVATE R/W OR EASEMENT
	EX. PUBLIC EASEMENT LINE
	EX. CENTERLINE
	EX. TREE LINE
4 4 4 4 4 4	EX. SIDEWALK
	EX. CURB & GUTTER
==========	EX. STORM DRAIN PIPE
DI 🗆 CB	EX. STORM DRAIN BOX
SS SS	EX. SANITARY SEWER PIPE
S	EX. SANITARY SEWER MANHOLE
W	EX. WATER LINE
	EX. HYDRANT & WATER VALVE
	EX. PAVEMENT MARKINGS
———Е ————Е ———	EX. OVERHEAD POWER LINE & POLE
	PROPOSED CENTERLINE
	PROPOSED EASEMENT LINE
	PROPOSED LOT LINE PROPOSED PUBLIC R/W LINE
	PROPOSED BUILDING SETBACK/BUFFER
	PROPOSED BUILDING FOOTPRINT
	PROPOSED TREE LINE
4. 4. 4. 4. 4. 4. 4. 4. 4. 4. 4. 4. 4. 4	PROPOSED SIDEWALK
	PROPOSED CURB & GUTTER
	PROPOSED DRAINAGE/SHORELINE
	PROPOSED STORM DRAINAGE PIPE
■ CB	PROPOSED STORM CATCH BASIN
■ DI	PROPOSED STORM DROP INLET
① SDMH	PROPOSED STORM MANHOLE
—— SS——— SS———	PROPOSED SEWER PIPE
S	PROPOSED SEWER MANHOLE
• CO	PROPOSED SEWER CLEANOUT
———W———W——	PROPOSED WATER LINE / VALVE

LOCATION

E-SHRUB

D-CANOPY

BOTANICAL NAME

QUERCUS TEXANA

ILEX VOMITORIA 'STOKES DWARF'

COMMON NAME

NUTTALL OAK

CRAPE MYRTLE

DWARF YAUPON HOLLY


QUANTITY KEY

ISD

QNO

D-UNDERSTORY 9 LCM LAGERSTROEMIA INDICA



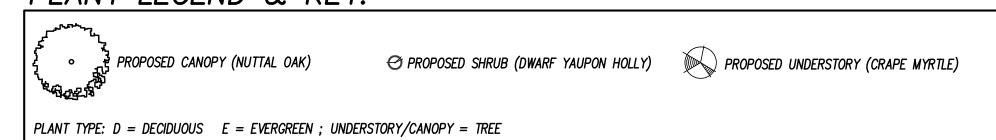


ENGINEERING

LICENSE # C-2710 ENGINEERING LAND PLANNING COMMERCIAL / RESIDENTIAL

P.O. BOX 1250 WENDELL, NC 27591 (910) 791–4441



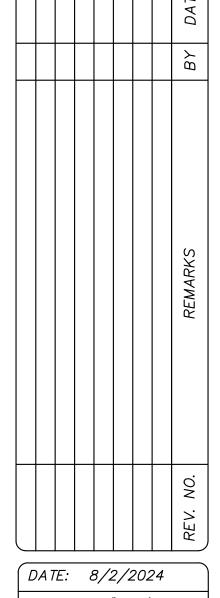



HORZ. SCALE: 1" = 20' VERT. SCALE: N/A


DRAWN BY: RBS CHECKED BY: JFO

PROJECT NO.: 24-0682

Sheet No. <u>13</u> OF <u>14</u>

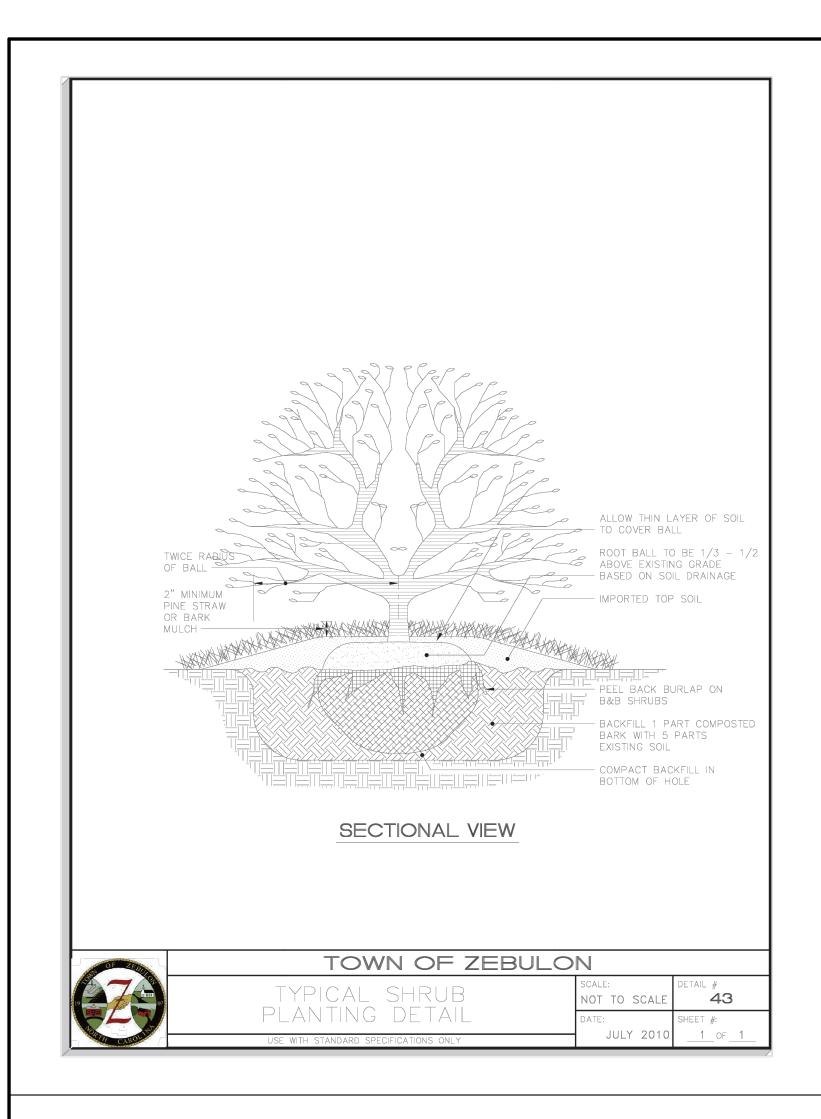

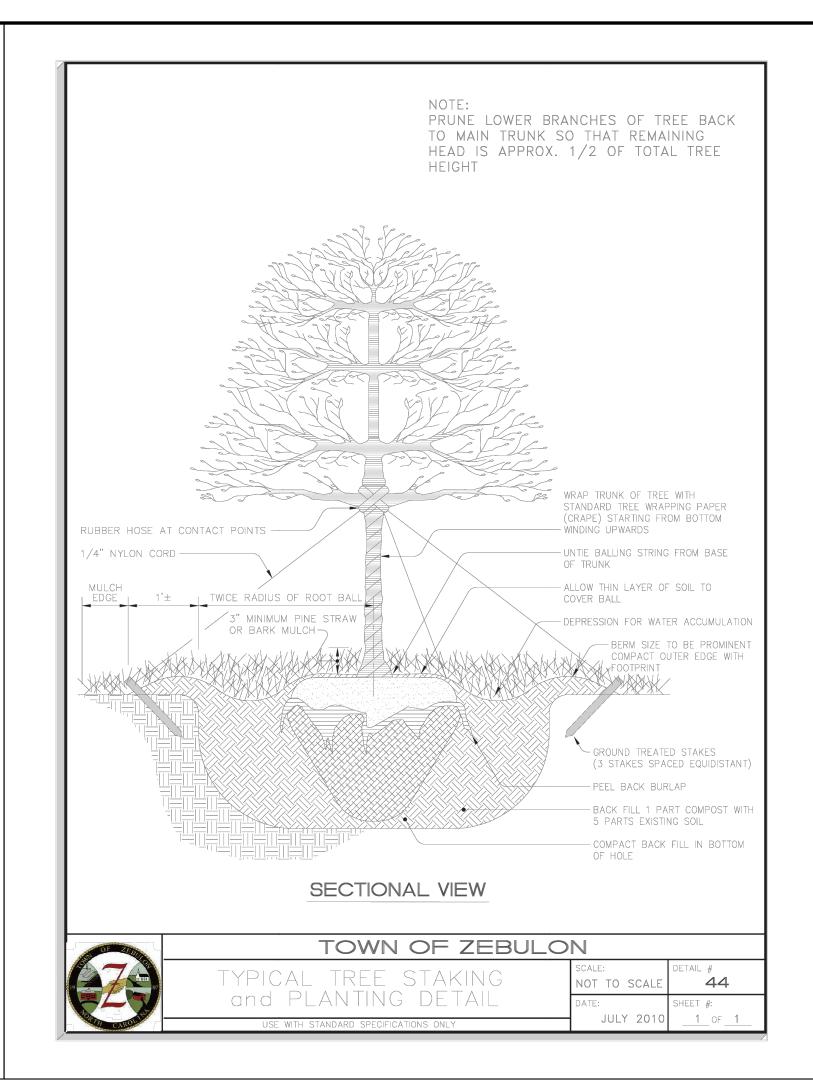

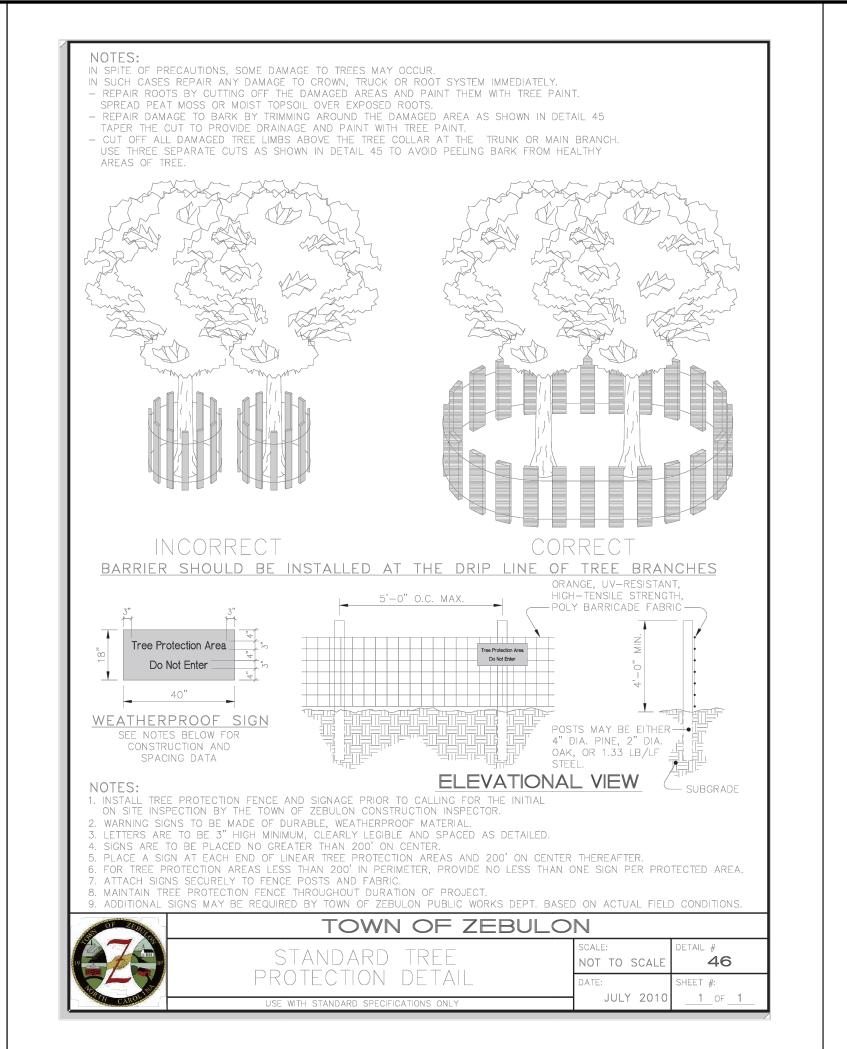




P.O. BOX 1250 WENDELL, NC 27591 (910) 791–4441

LANDSCAPE PLAN
DETAIL SHEET

FRANCO MASONRY & CONCRETE LOCATED IN TOWN OF ZEBULON WAKE COUNTY, NORTH CAROLINA OWNER: FRANCO ROMERO CONTACT: FRANCO ROMERO



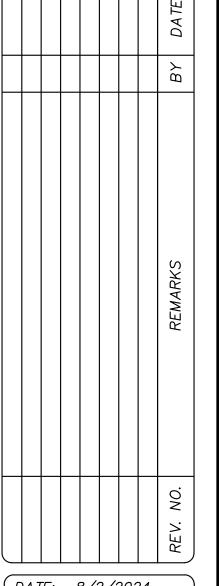

DATE: 8/2/2024

HORZ. SCALE: 1" = 20'
VERT. SCALE: N/A

DRAWN BY: RBS

CHECKED BY: JFO

PROJECT NO.: 24-0682