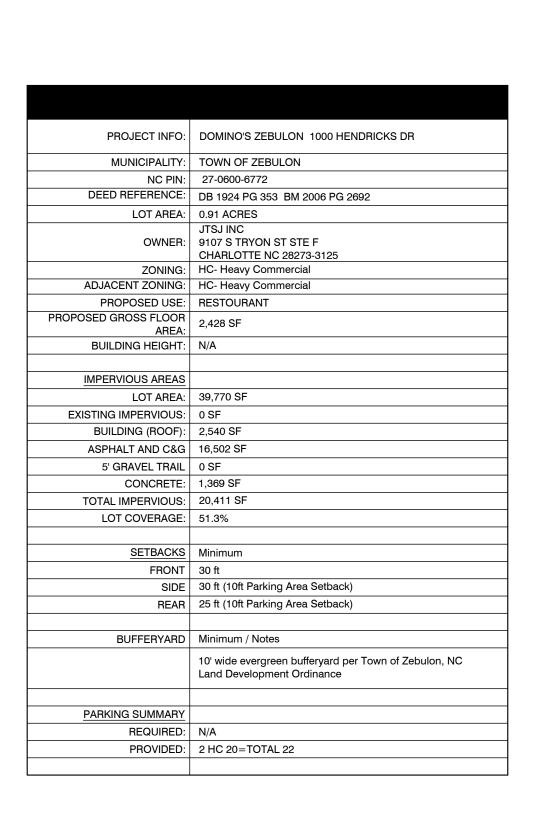
DOMINO'S ZEBULON



CONSTRUCTION DRAWINGS ZEBULON, WAKE COUNTY, NORTH CAROLINA



	VICINITY MAP	
	NC 264-64 E	
	NC 264-64 W	
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Sheet List Table						
Sheet Number	Sheet Title					
C1.01	COVER					
C1.02	RECORDED PLAT SURVEY					
C1.03	EXISTING CONDITION DEMOLITION PLAN					
C2.01	SITE PLAN					
C2.10	SITE DETAILS					
C2.11	SITE DETAILS					
C3.01	UTILITY PLAN					
C3.10	UTILITY DETAILS					
C3.11	UTILITY DETAILS					
C4.01	STORMWATER AND GRADING PLAN					
C4.10	STORM DETAILS					
C4.11	STORM DETAILS					
L1.01	LANDSCAPE PLAN					
L1.02	LANDSCAPE NOTES AND DETAILS					

- CONTRACTOR MUST NOTIFY NORTH CAROLINA ONE-CALL CENTER, INC. (NC-811) AT LEAST 72 9. NCDOT AND TOWN OF ZEBULON DRIVEWAY PERMITS ARE NOT REQUIRED. HOURS PRIOR TO THE START OF EXCAVATION TO HAVE ALL UNDERGROUND UTILITIES LOCATED
 - DRIVEWAY ORDINANCE.
 - 11. REFUSE COLLECTION SHALL BE PROVIDED BY PRIVATE CONTRACTOR.
- STANDARD DESIGNS AND DETAILS AND THE MANUAL FOR THE DESIGN AND CONSTRUCTION OF 13. ALL DIMENSIONS ARE TO BACK OF CURB UNLESS OTHERWISE NOTED.
 - 14. APPROVAL OF SITE PLAN DOES NOT CONSTITUTE APPROVAL OF SIGNS. SEPARATE SIGN PERMITS

10. ANY UNUSED DRIVEWAY SHALL BE CLOSED IN ACCORDANCE WITH TOWN OF ZEBULON

- 15. CONTRACTOR SHALL NOTIFY PUBLIC WORKS STREET MAINTENANCE DIVISION 48 HOURS PRIOR TO MAKING CONNECTIONS TO EXISTING STORM DRAINS LOCATED WITHIN PUBLIC STORM DRAINAGE
- 16. ACCESS TO PUBLIC UTILITIES MUST BE MADE AVAILABLE AT ALL TIMES.
- 17. ZEBULON ELECTRIC EASEMENT IS 10' IN WIDTH AND CENTERED OVER ELECTRIC LINES AS INSTALLED.
- 18. NO BUILDINGS, STRUCTURES OR OTHER IMPROVEMENTS, MATERIALS AND SURFACES, INCLUDING BUT NOT LIMITED TO PRINCIPLE AND ACCESSORY STRUCTURES AND ADDITIONS 8. BUILDINGS MUST MEET ALL APPLICABLE BUILDING CODES. SITE SHALL MEET ALL RELATIVE NORTH AND APPURTENANCES THERETO, SIGNAGE, FENCES, WALLS, MECHANICAL EQUIPMENT, CANOPIES, ANTENNAS, MASTS, DEBRIS, SOLID WASTE COLLECTION CONTAINERS, MAIL RECEPTACLES AND IMPERVIOUS SURFACES SHALL ENCROACH WITHIN ANY DEDICATED

EASEMENT WITHOUT PRIOR APPROVAL OF RALEIGH UTILITIES OR CITY OF RALEIGH, AS

- 19. THIS SITE DOES NOT REQUIRE ANNEXATION UPON APPROVAL OF SITE PLAN.
- 20. LANE CLOSURES ON THOROUGHFARE ROADS ARE ONLY PERMITTED BETWEEN THE HOURS OF 9:00AM AND 4:00PM, MONDAY THROUGH FRIDAY, UNLESS OTHERWISE PERMITTED BY THE TRAFFIC ENGINEER IN ADDITION , THERE WILL BE NO LANE CLOSURES ON HOLIDAYS INCLUDING THE DAY BEFORE OR AFTER SAID HOLIDAY. A TRAFFIC CONTROL PLAN PREPARED IN ACCORDANCE WITH THE NCDOT MANUAL OF UNIFORM TRAFFIC CONTROL DEVISES IS REQUIRED FOR ALL LANE CLOSURES AND MUST BE APPROVED BY THE TRAFFIC ENGINEER.
- 21. ALL SITE LIGHTING SHALL COMPLY WITH THE TOWN OF ZEBULON LIGHTING STANDARD.
- 22. NEW BUILDINGS MUST COMPLY WITH NC FIRE CODE SECTION 510-EMERGENCY RESPONDER RADIO COVERAGE.
- 23. PLEASE BE ADVISED OF THE RULES WHICH PROTECT AND MAINTAIN EXISTING BUFFERS ALONG WATERCOURSES IN THE NEUSE RIVER BASINS. THIS RULE IS ENFORCED BY THE DIVISION OF WATER QUALITY (DWQ). DIRECT ANY QUESTIONS ABOUT THE APPLICABILITY OF THIS RULE TO YOUR PROJECT TO ROGER THORPE, REGIONAL WATER QUALITY SUPERVISOR, WASHINGTON REGIONAL OFFICE, AT (919) 946-6481

CIVIL ENGINEER

Rivers & Associates, Inc. Greenville, NC



107 East Second Street Greenville, NC 27858 (252) 752-4135

Contact: Steve Janowski, PE

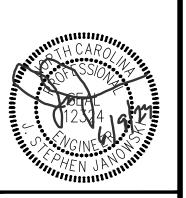
DEVELOPER/ARCHITECT



1900 Abbott Street / Suite 103 Charlotte, North Carolina 28203 704-335-1292 www.begarchitect.com

sjanowski@riversandassociates.com

ALL CONSTRUCTION TO BE IN ACCORDANCE WITH TOWN OF ZEBULON, NCDOT & NCDEQ STANDARDS, SPECIFICATIONS AND DETAILS.



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				06/01/23	DATE BY
				CONSTRUCTION DRAWINGS SUBMITTAL	DESCRIPTION
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06/08/2023

JSJ/MS DESIGNED BY: DRAWN BY: CHECKED BY: 2023018 PROJECT No. W-408⁻ RAWING No. AS SHOWN



PRIOR TO EXCAVATING OR TRENCHING.

EFFECTIVE JULY 7, 2022.

SANITARY SEWER AND STORM DRAINAGE SYSTEMS.

CAROLINA ACCESSIBILITY CODE REQUIREMENTS.

ELECTRIC AND TELEPHONE UTILITIES SHALL BE INSTALLED UNDERGROUND.

EROSION CONTROL PLAN APPROVAL REQUIRED NOT REQUIRED LESS 1 ACRES

7. STORMWATER MANAGEMENT PLAN APPROVAL REQUIRED NOT REQUIRED LESS 1 ACRES

ALL REQUIRED IMPROVEMENTS SHALL COMPLY WITH THE TOWN OF ZEBULON MANUAL OF

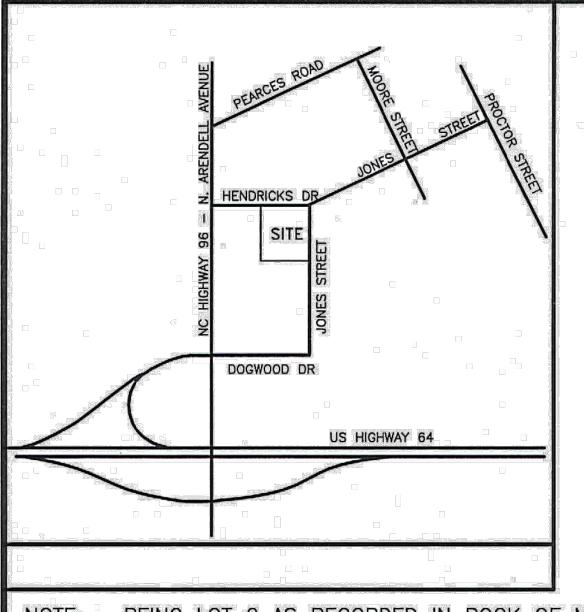
WATER AND WASTEWATER SYSTEM EXTENSIONS FOR GREENVILLE UTILITIES COMMISSION.

CONSTRUCTION PLAN APPROVAL FROM RALEIGH UTILITIES COMMISSION AND THE CITY OF

RALEIGH SHALL BE OBTAINED PRIOR TO CONSTRUCTION OF ANY STREET, WATER, AND/OR

THIS SITE IS LOCATED IN A ZONE 'X' (AREA DETERMINED TO BE OUTSIDE 0.2% ANNUAL CHANCE

100 YEAR FLOODPLAIN) AS IDENTIFIED BY FEMA FLOOD INSURANCE RATE MAP 3720270600K,



NOTE: BEING LOT 2 AS RECORDED IN BOOK OF MAPS 2006 PAGE 2692.

NOTE: PIN # 2706-00-6772

REFERENCE:

DB 11560 PG 240

BOOK OF MAPS 2001 PG 19 BOOK OF MAPS 2006 PG 2692 DB 13097 PGS 2212-2214

NOTE: AREA COMPUTED BY COORDINATE METHOD

NOTE: UTILITY LOCATIONS SHOWN ARE BASED ON VISIBLE EVIDENCE. THE LOCATIONS OF UNDERGROUND UTILITIES ARE TO BE FIELD VERIFIED BY CONTRACTOR.

TOP = 337.41'

INV IN = 330.23'

NOTE: THIS PROPERTY IS SUBJECT TO EASEMENTS AND RESTRICTIONS OF RECORD.

TONY & KATHY SMITH P O BOX 1215 1000 HENDRICKS DR ZEBULON, NC 27597

ZONED HC

MANHOLE # 3 TOP = 340.03' INV OUT = 333.31'

MANHOLE # 4

INV IN = 331.87'

TOP = 341.69' INV IN = 331.47' INV IN = 331.79'

TOP = 338.65' INV IN = 332.76' INV OUT = 332.71'

BOM 2006 PG 2692; that the ration of precision or positional acquires 1000 and that this map meets the requirements of The Standards of Bractice for Capit S in North Carolina (21 NCAC 56.1600). This 6TH day of DECEMBER , 2022.

P. L. S. L-2647

FLOOD CERTIFICATION

I have examined liter Flood Insurance Rate Map for WAKE

County, NORTH CARALITY Community Panel Number 3720270600K

dated JULY 19, 2022 300 Control of Special Road Hazard Aris at determined by the Department of housing and Urban Development.

SEAL

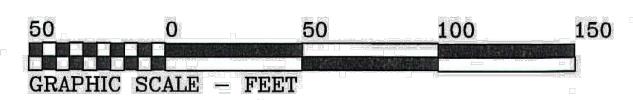
Professional Land Survey No. 2547

ZONED R-20 DEED BOOK 4181 - PAGE 20 ZONED GB 60' PUBLIC R/W CURB INLET — T/C = 338.20 GRATE = 337.54 INV IN = 335.97 INV OUT = 335.84 COOK OUT ZEBULON INC. DEED BOOK 17641 PAGE 41 CHURCH OF JESUS CHRIST OF LDS DEED BOOK 2843 - PAGE 659 ZONED R-20 BACK OF CURBY S 52'17'37 CURB INLET-T/C = 336.31GRATE = 335.64 INV IN = 333.27INV OUT = 333.20SPIRIT MASTER FUNDING LLC DEED BOOK 15550 PAGE 874 6 MH # 7 NCGS GRID STATION "TART2" NAD '83 COORDINATES N = 759210.122 FT. E = 2201187.769 FT.

R. B. JONES JR.

PROPERTY SURVEY FOR PIEDMONT PROPERTIES

> TOWN OF ZEBULON WAKE COUNTY NORTH CAROLINA



LEGEND

NCGS GRID MONUMENT

MANHOLE WATER VALVE

FIRE HYDRANT UNDERGROUND SANITARY SEWER

WATER CUT OFF

CATCH BASIN / CURB INLET WATER METER

WATER LINE AS PAINTED BY: THE TOWN OF ZEBULON DIP = DUCTILE IRON PIPE

> DRAWN BY: DOW & BGW CHECKED BY: DOW 12-06-2022 1" = 50"

JOB: SONIC\ZEBULON\LOT 2 TOPO.DWG FB:

WILLIAMS - PEARCE & ASSOC., P.A. Professional Land Surveyors P.O. Box 892, Zebulon, N.C. 27597

DORIS C. HICKS

DEED BOOK 7276 - PAGE 169

Phone (919) 269-9605

06/08/202 JSJ/MS

2023018

AS SHOWN

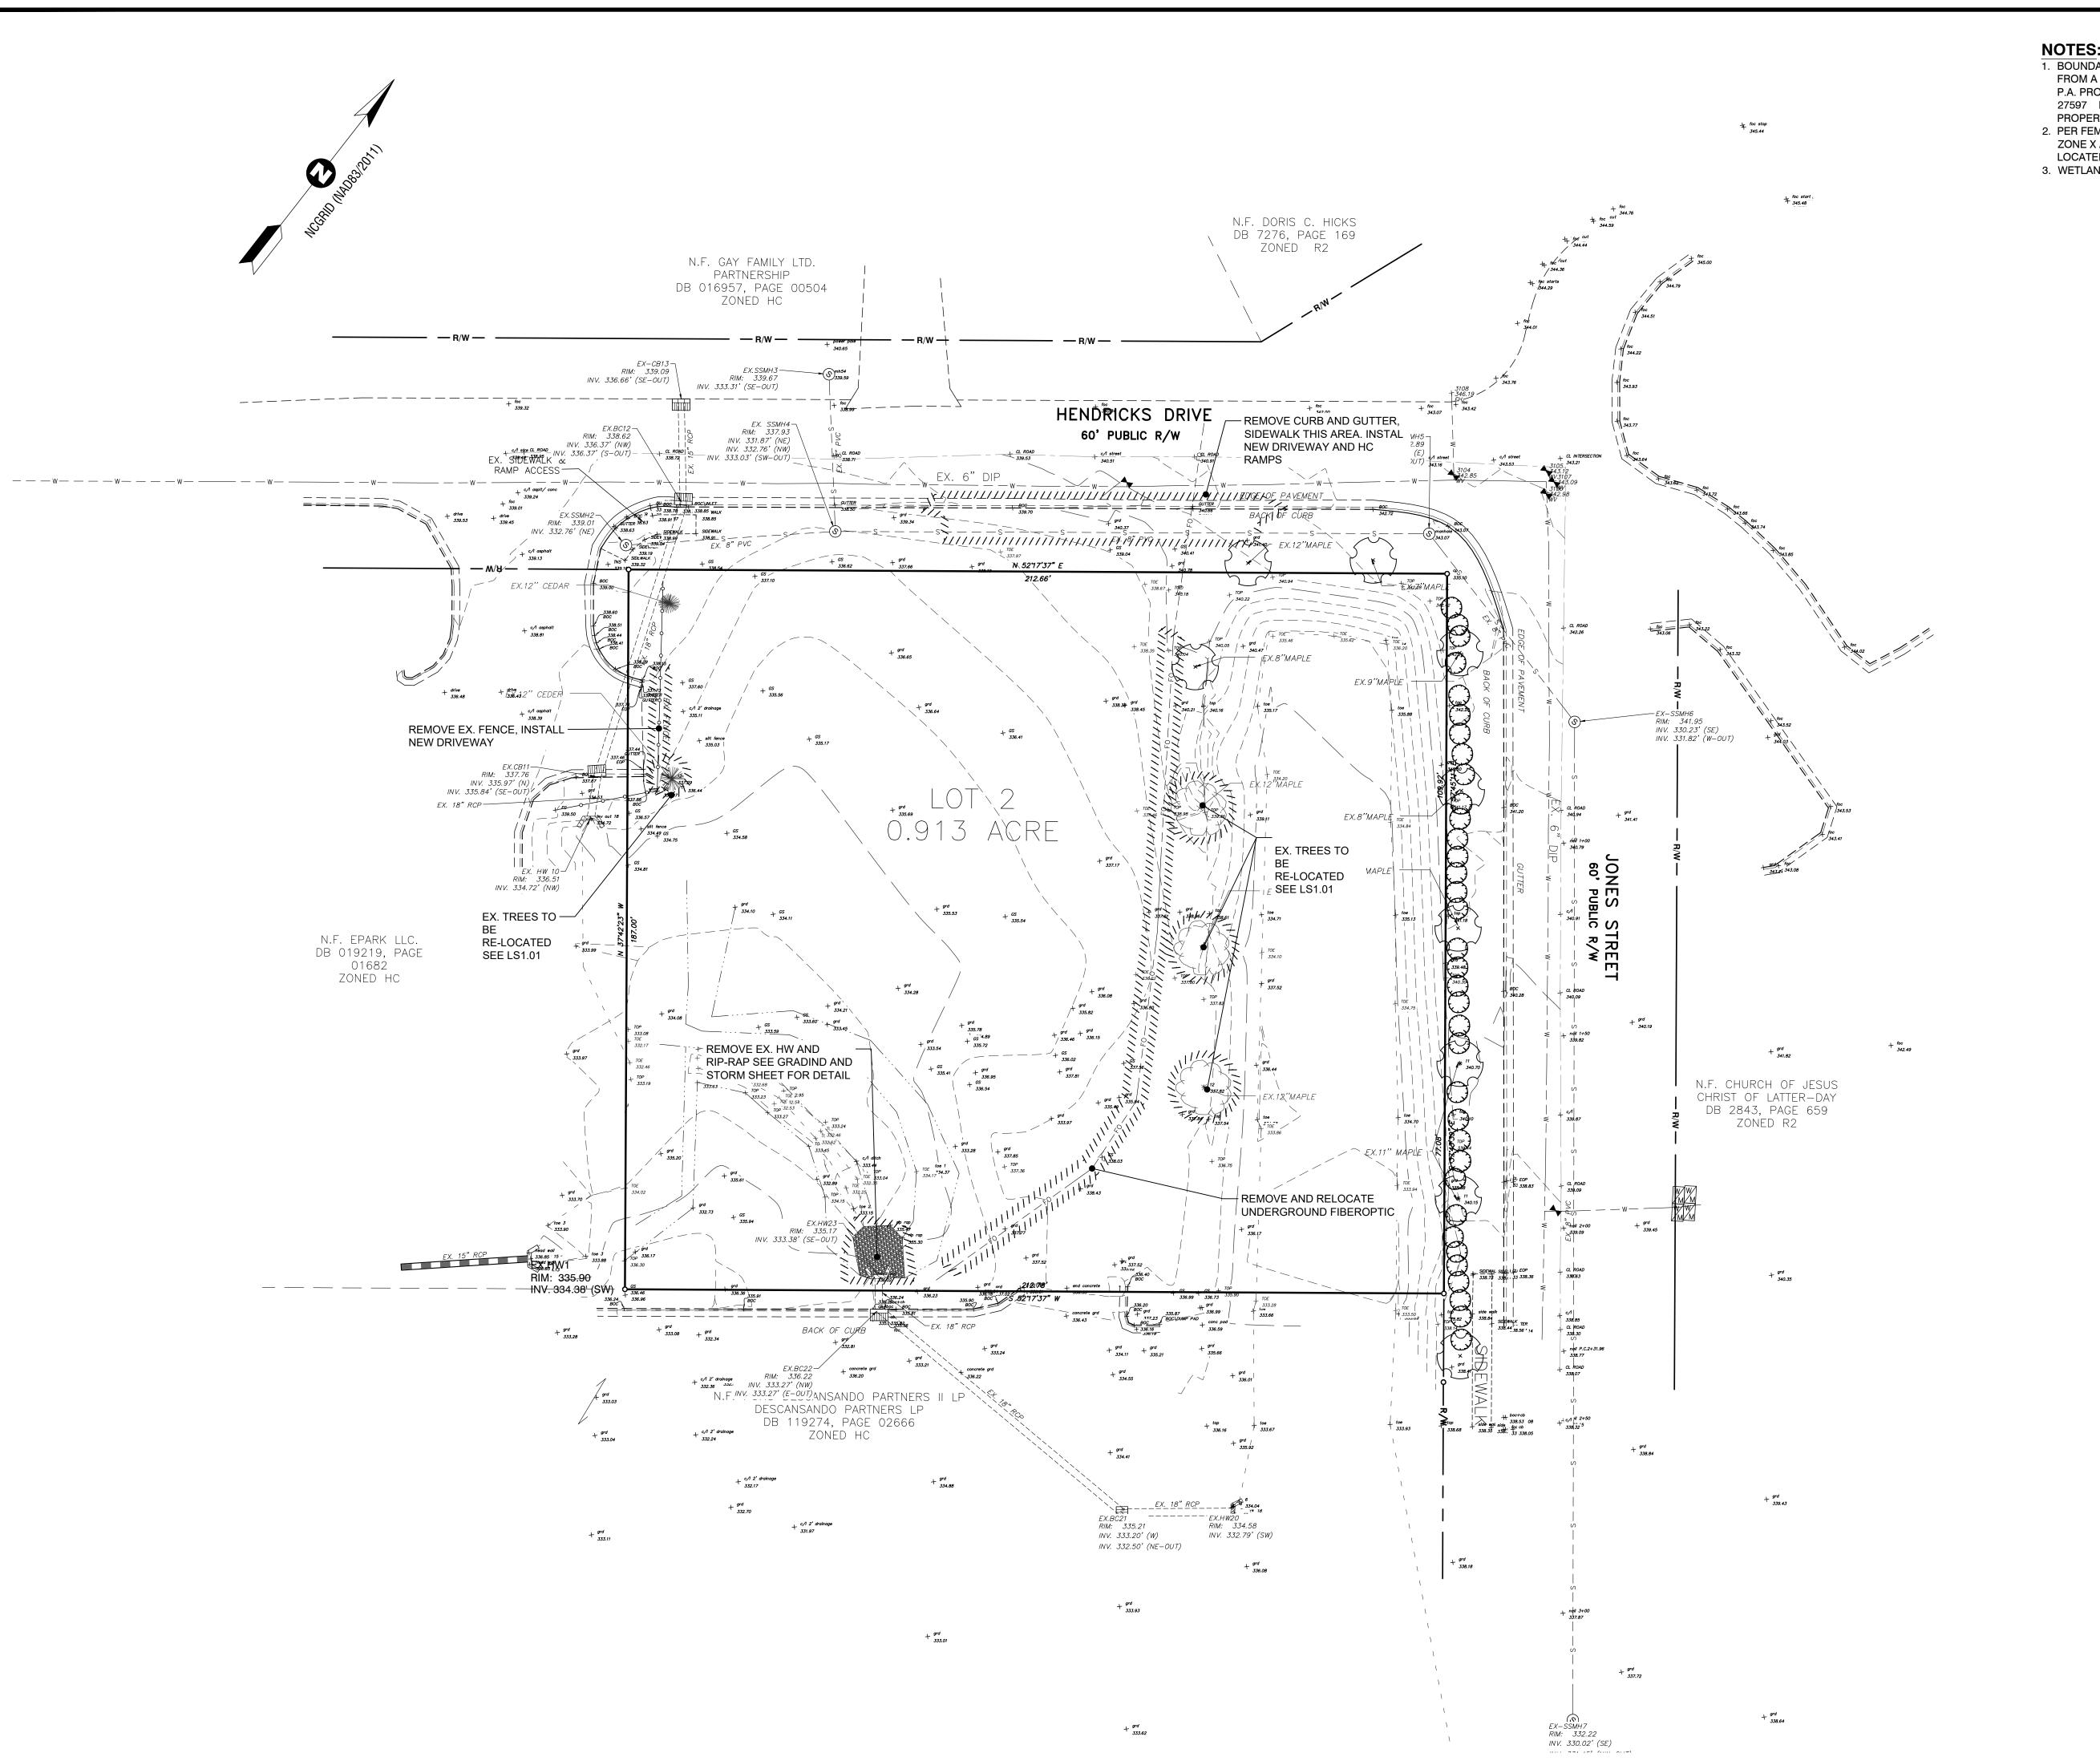
W-408⁻

REVISIONS:

C1.02

CHECKED BY:

PROJECT No.



- 1. BOUNDARY, TOPOGRAPHIC AND PLANIMETRIC FEATURES SHOWN ARE FROM A FIELD SURVEY PERFORMED BY WILLIAMS PEARCE & ASSOC., P.A. PROFESSIONAL LAND SURVEYORS P.O. BOX 892, ZEBULON, N.C. 27597 PHONE (919) 269-9605 PROPERTY SURVEY FOR: PIEDMONT
- PROPERTIES ON 12/06/2022.

 2. PER FEMA FIRM MAP 3720466000L DATED 7/7/14, THIS PROJECT IS IN ZONE X AND THEREFORE THERE IS NO REGULATORY FLOODPLAIN LOCATED ON THIS PROPERTY.
- 3. WETLANDS, STREAMS & ASSOCIATED BUFFERS TO BE DETERMINED.

& ASSOCIATES, IN Since 19





DATE	NO. DESCRIPTION	Z	
06/01/2	CONSTRUCTION DRAWINGS SUBMITTAL		
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O'S ZEBULON

WAKE COUNTY NORTH CAROLINA

ONDITION DEMOLITIO

DOMINOS WAKE COUNT TOWN OF ZEBULON WAKE COUNT

DATE: 06/08/2023

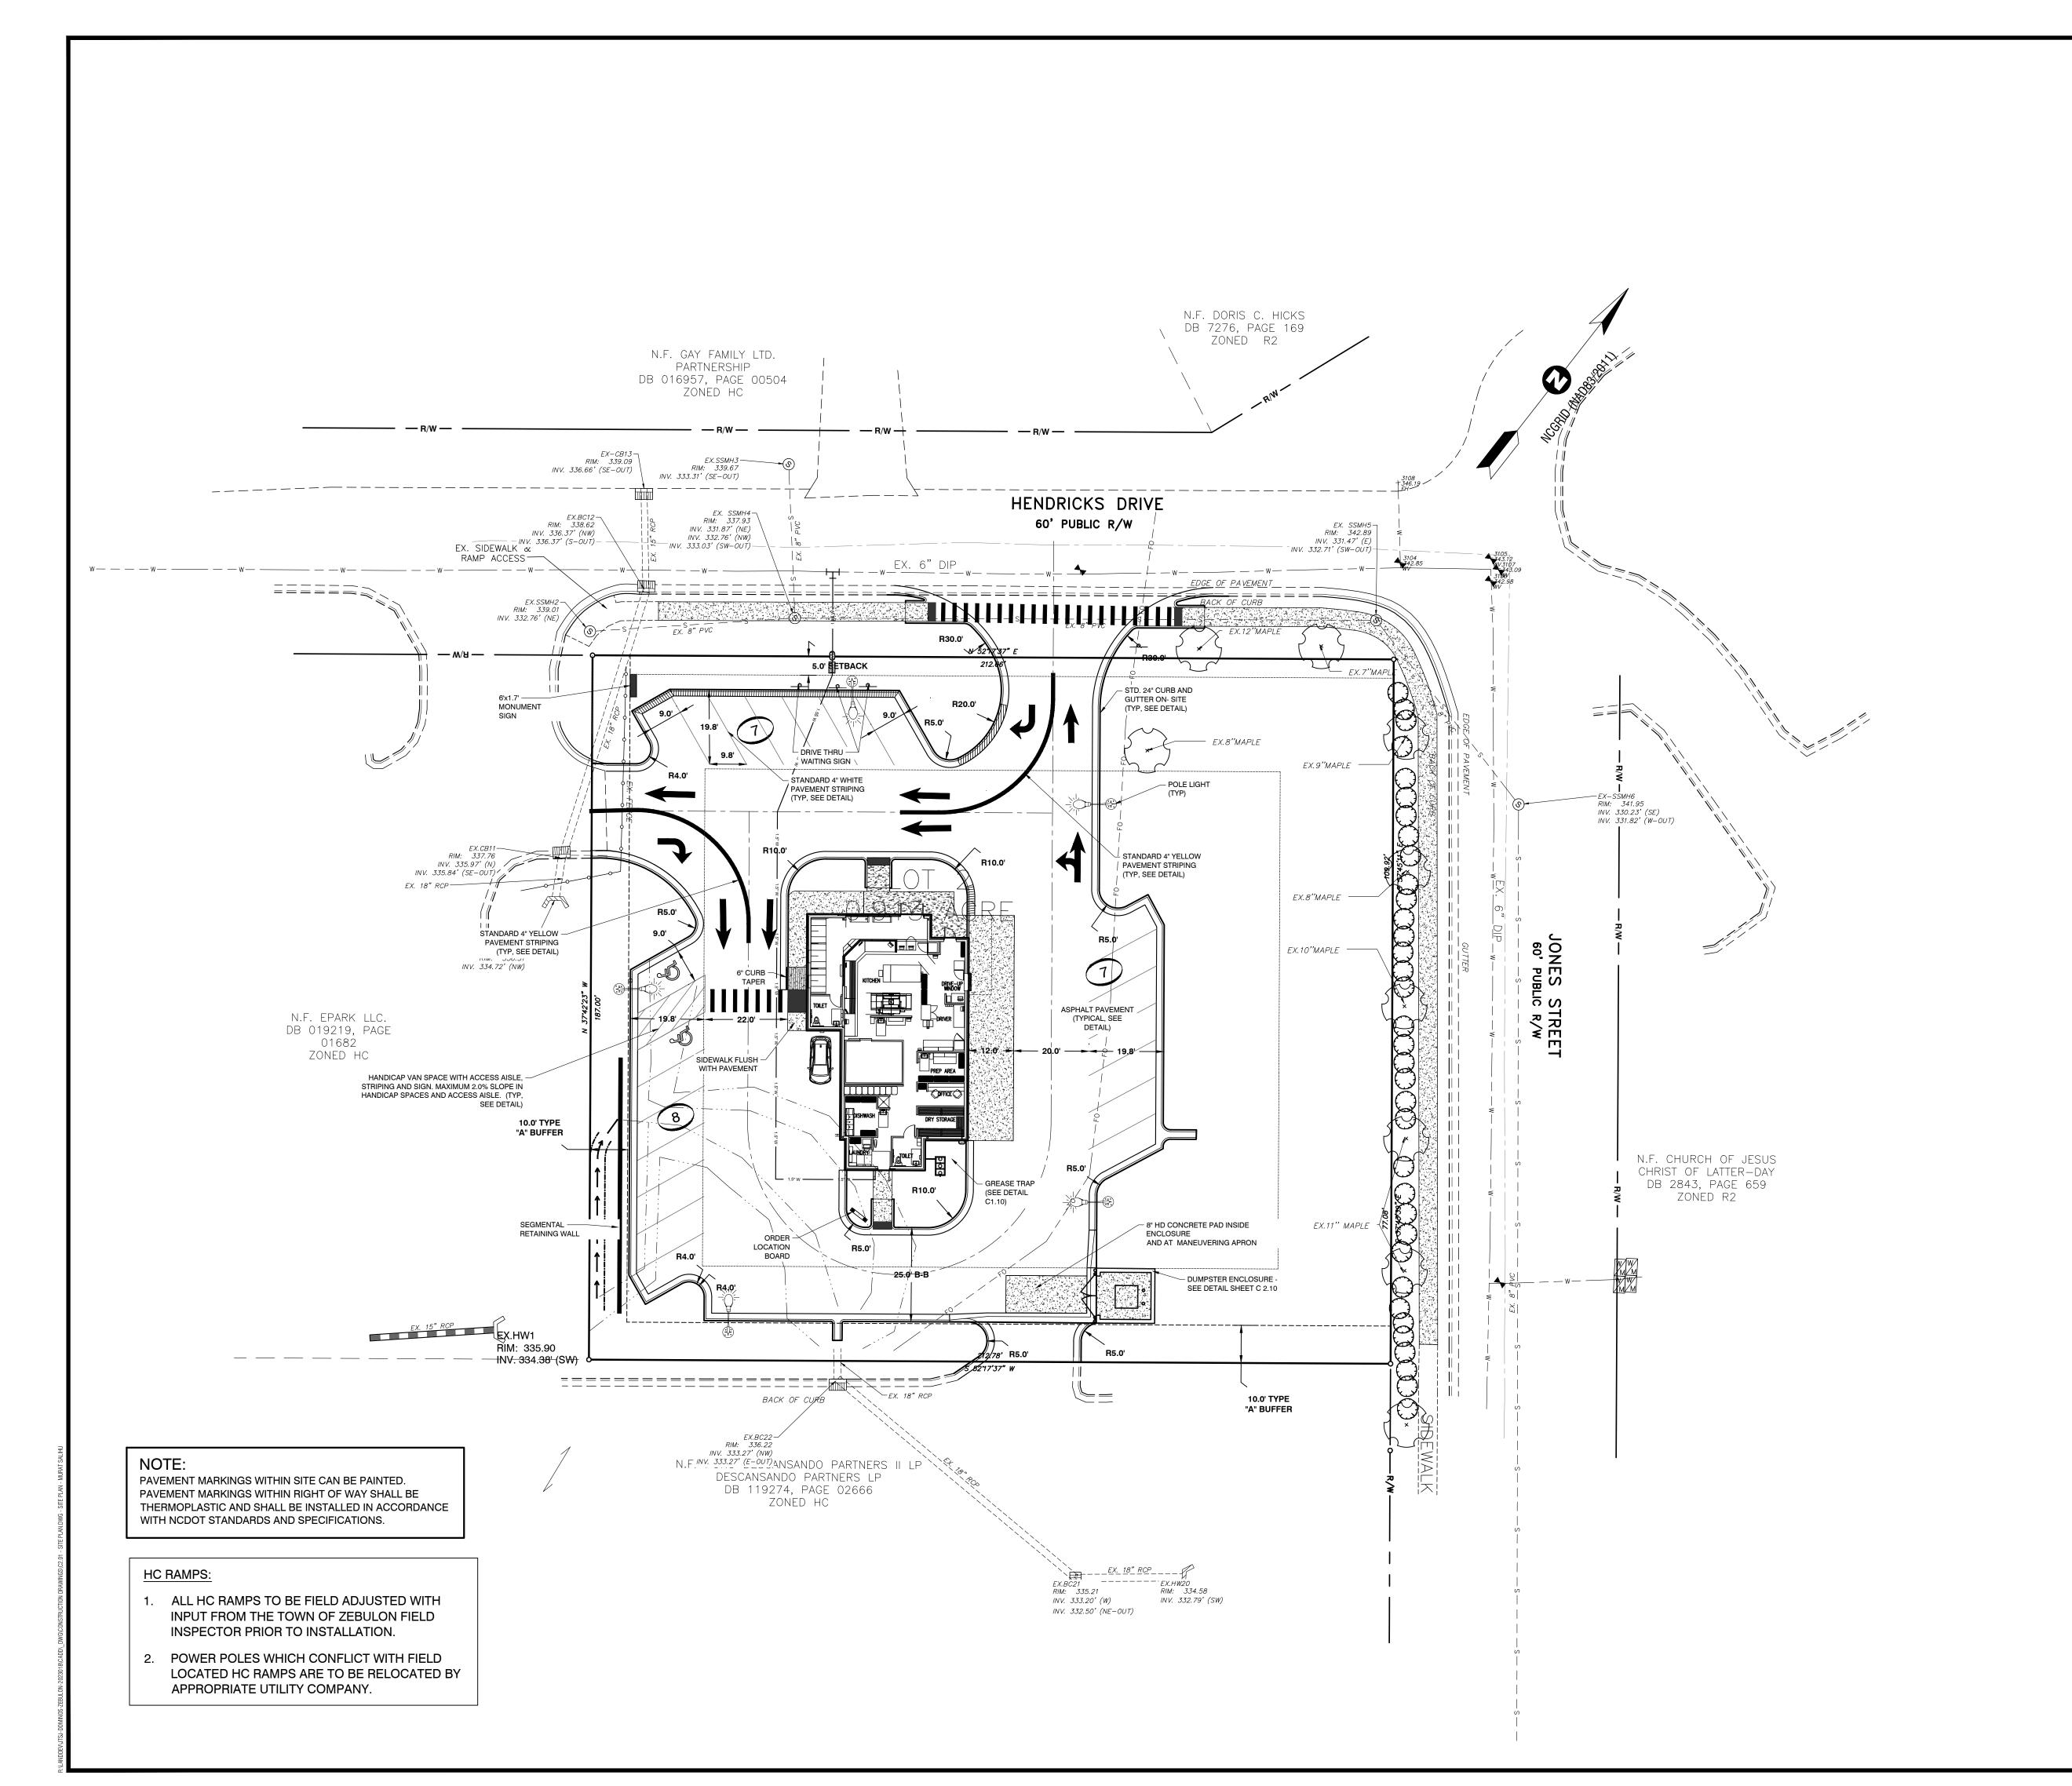
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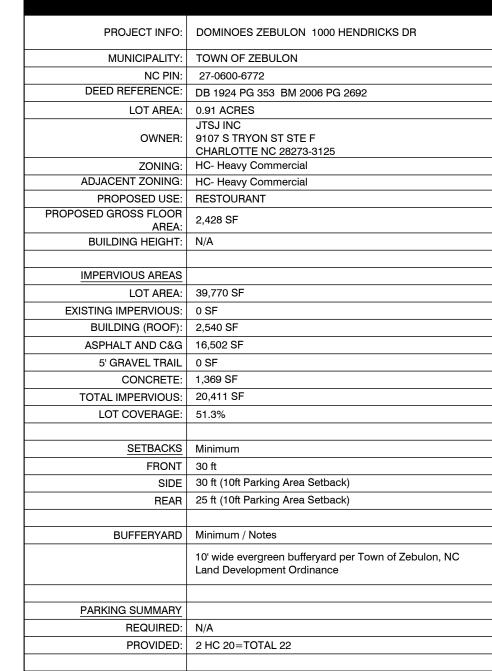
DESIGNED BY: JSJ/MS
DRAWN BY: MS
CHECKED BY: JSJ
PROJECT No. 2023018
DRAWING No. W-4081
SCALE: AS SHOWN

CALL BEFORE YOU DIG! WWW.NC811.ORG N.C. ONE-CALL CENTER IT'S THE LAW!

SCALE 1 inch = 20 ft

C1.03





GENERAL NOTES:

- 1. ALL SITE WORK SHALL BE DONE IN ACCORDANCE WITH THE PLANS PREPARED BY RIVERS AND ASSOCIATES, INC., THE CURRENT REQUIREMENTS OF THE CITY/TOWN OF CLINTON, THE APPLICABLE SECTIONS OF THE NCDOT STANDARD SPECIFICATIONS FOR ROADWAY CONSTRUCTION, AND ALL OTHER PERTINENT FEDERAL, STATE AND LOCAL LAWS.
- 2. THE CONTRACTOR SHALL COMPLY AT ALL TIMES WITH APPLICABLE FEDERAL, STATE AND LOCAL LAWS, PROVISIONS, AND POLICIES GOVERNING SAFETY AND HEALTH, INCLUDING THE FEDERAL CONSTRUCTION SAFETY ACT (PUBLIC LAW 91-54), FEDERAL REGISTER, CHAPTER XVII, PART 1926 OF TITLE 29 REGULATIONS, OCCUPATIONAL SAFETY AND HEALTH REGULATIONS FOR CONSTRUCTION, AND SUBSEQUENT PUBLICATIONS UPDATING THESE REGULATIONS. 3. THE CONTRACTOR SHALL BE RESPONSIBLE FOR EXAMINING THE AREAS AND CONDITIONS
- UNDER WHICH THE PROJECT IS TO BE CONSTRUCTED PRIOR TO THE SUBMISSION OF A BID. SUBMISSION OF A BID SHALL BE CONSTRUED TO MEAN THE CONTRACTOR HAS REVIEWED THE SITE AND IS FAMILIAR WITH CONDITIONS AND CONSTRAINTS OF THE SITE. 4. BEFORE EXCAVATION, ALL UNDERGROUND UTILITIES SHALL BE LOCATED IN THE FIELD BY THE PROPER AUTHORITIES. THE CONTRACTOR SHALL NOTIFY N.C. ONE CALL AT
- 1-800-632-4949. THE LOCATION OF ALL UTILITIES AND UNDERGROUND STRUCTURES ARE APPROXIMATE AND MAY NOT ALL BE SHOWN. IT IS THE RESPONSIBILITY OF THE CONTRACTOR TO DETERMINE THE EXISTENCE AND EXACT LOCATION OF ALL UTILITIES AND UNDERGROUND STRUCTURES. 5. CONTRACTOR SHALL REFER TO THE GEOTECHNICAL REPORT PRIOR TO INITIATION OF ANY
- EARTHWORK ACTIVITY. 6. CONTRACTOR IS RESPONSIBLE FOR TRAFFIC CONTROL PLAN - TO BE SUBMITTED TO AND
- APPROVED BY NCDOT AND THE CITY/TOWN OF CLINTON. 7. CONTRACTOR SHALL NOTIFY PUBLIC WORKS STREET MAINTENANCE DIVISION 48 HOURS PRIOR TO MAKING CONNECTIONS TO EXISTING STORM DRAINS LOCATED WITHIN PUBLIC STORM DRAINAGE FASEMENTS OR R/W.
- 8. REFER TO C1.02 FOR SURVEY CONTROL INFORMATION. 9. CONTRACTOR SHALL REFER TO OTHER PLANS WITHIN THIS CONSTRUCTION SET FOR
- OTHER PERTINENT INFORMATION. 2. PER FEMA FIRM MAP 3720466000L DATED 7/7/14, THIS PROJECT IS IN ZONE X AND
- THEREFORE THERE IS NO REGULATORY FLOODPLAIN LOCATED ON THIS PROPERTY. NO BUILDINGS, STRUCTURES OR OTHER IMPROVEMENTS, MATERIALS AND SURFACES. INCLUDING BUT NOT LIMITED TO PRINCIPLE AND ACCESSORY STRUCTURES AND ADDITIONS AND APPURTENANCES THERETO, SIGNAGE, FENCES, WALLS, MECHANICAL EQUIPMENT, CANOPIES, ANNTENNAS, MASTS, DEBRIS, SOLID WASTE COLLECTION CONTAINERS, MAIL RECEPTACLES, AND IMPERVIOUS SURFACES SHALL NOT ENCROACH WITHIN ANY DEDICATED EASEMENT WITHOUT PRIOR APPROVAL OF CITY/TOWN OF
- CLINTON PUBLIC UTILITIES DEPARTMENT. 4. SOIL EROSION AND SEDIMENTATION CONTROL PLAN IS NOT APPLICABLE, THE SITE
- DISTURBANCE IS LAST THAN ONE ACRE. 5. WETLANDS ARE VALUABLE NATURAL RESOURCES THAT PROVIDE IMPORTANT ECOLOGICAL FUNCTIONS. BE ADVISED THAT ACTIVITIES IN WETLANDS ARE REGULATED BY THE FEDERAL GOVERNMENT UNDER SECTION 404 OF THE CLEAN WATER ACT. JURISDICTIONAL WETLANDS MAY INCLUDE THE PINE-SHRUB POCOSINS THAT ARE COMMON IN THIS REGION. IF ANY PRIVATE LAND OWNER, DEVELOPER, CORPORATION, OR OTHER PERSON PROPOSES TO UNDERTAKE CONSTRUCTION/FILLING ACTIVITIES IN OR NEAR A LAKE, STREAM, CREEK TRIBUTARY OR ANY UNNAMED BODY OF WATER INCLUDING ITS ADJACENT WETLANDS, FEDERAL PERMIT AUTHORIZATION MAY BE REQUIRED FROM THE U.S. ARMY CORPS OF ENGINEERS PRIOR TO COMMENCEMENT OF SUCH LAND-DISTURBING ACTIVITIES. PLEASE CONTACT MS. TRACY WHEELER, TELEPHONE (252) 975-1616 FOR A WETLAND DETERMINATION AND INFORMATION REGARDING SPECIFIC
- PERMIT REQUIREMENTS. WETLANDS DETERMINATION PENDING, BY OTHERS. 6. APPROVAL OF SITE PLAN DOES NOT CONSTITUTE APPROVAL OF SIGNS. SEPARATE SIGN PERMITS ARE REQUIRED.
- 7. ALL SLOPES SHALL BE 3:1 (HORIZONTAL: VERTICAL) MAXIMUM UNLESS NOTED
- 8. ALL AREAS NOT PAVED SHALL BE TOPSOILED, SEEDED, MULCHED OR
- LANDSCAPED/SODDED UNLESS OTHERWISE NOTED IN THE CONSTRUCTION DRAWINGS, SITE SPECIFICATIONS OR INSTRUCTED BY THE OWNER. CONTRACTOR SHALL CONTACT THE FOLLOWING NCDOT OFFICE PRIOR TO BEGINNING
- WORK WITHIN RIGHT OF WAY (MIN. 5 DAYS NOTICE REQUIRED): SAMPSON COUNTY DISTRICT ENGINEER'S OFFICE (910)682-5100. 10. ALL REQUIRED IMPROVEMENTS SHALL COMPLY WITH THE SAMPSON COUNTY ZONING
- 11. REFUSE COLLECTION SHALL BE PROVIDED BY PRIVATE CONTRACTOR. 12. CONSTRUCTION OF ROADWAY EXTENSION BY OTHERS
- 13. CONTRACTOR IS RESPONSIBLE FOR INSTALLING AND MAINTAINING A CONSTRUCTION

ACCESS ROAD A MINIMUM OF 15' WIDE FROM THE EXISTI	NG PAVEMENT TO THE SITE
ENTRANCE. INSTALL A MINIMUM DEPTH OF 6" CABC.	
EXISTING	PROPOSED

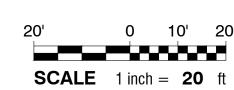
PROPERTY LINE —— —— ADJ. PROPERTY LINE RIGHT OF WAY — — — –159- — — MINOR TOPO

TREE LINE TREE LINE -----DITCH CENTERLINE ----- TOP OF DITCH

ASPHALT LOT ASPHALT ROAD

FUTURE ROAD



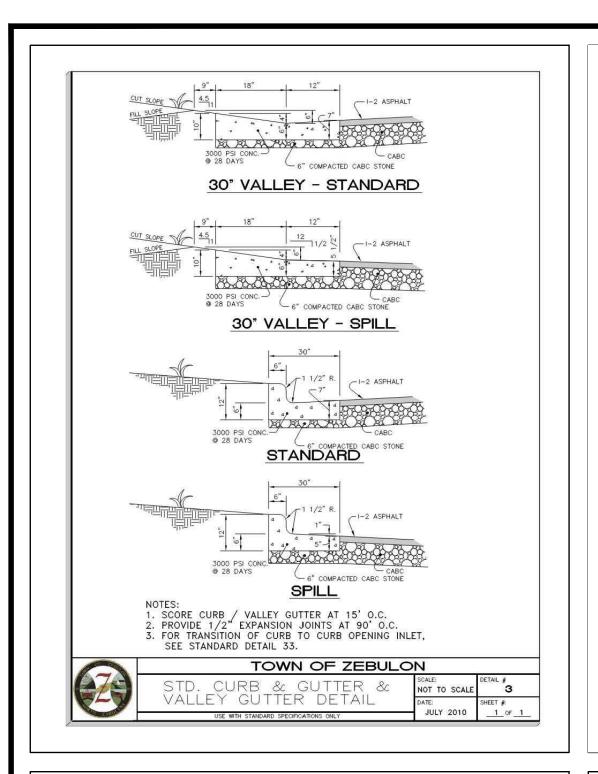


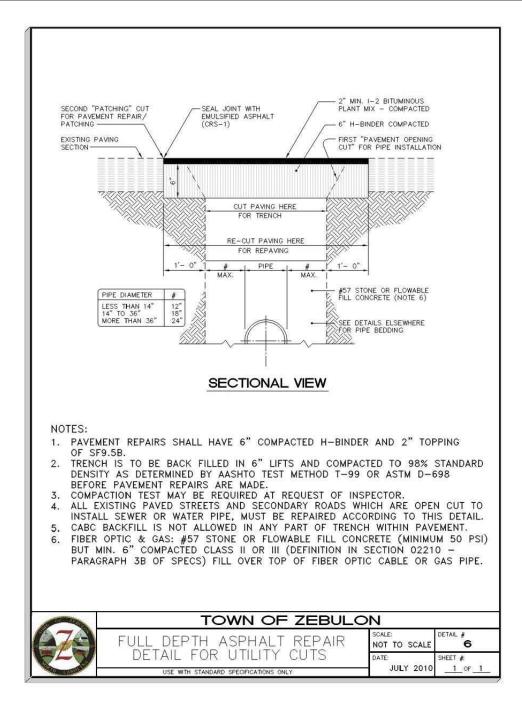


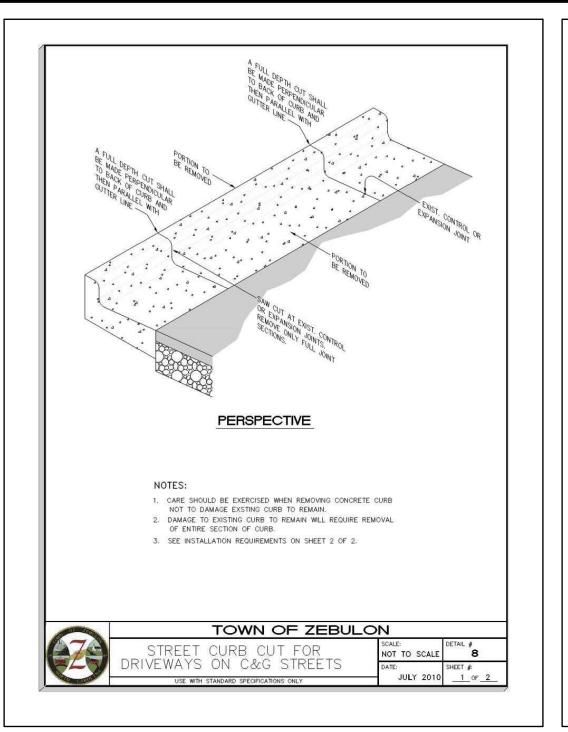
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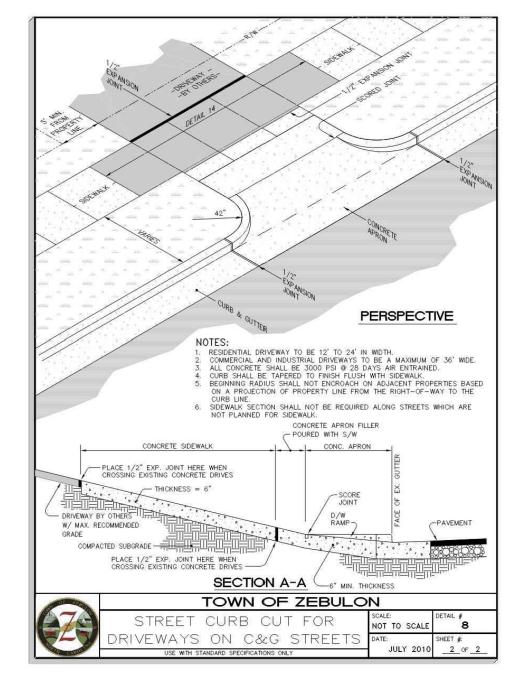
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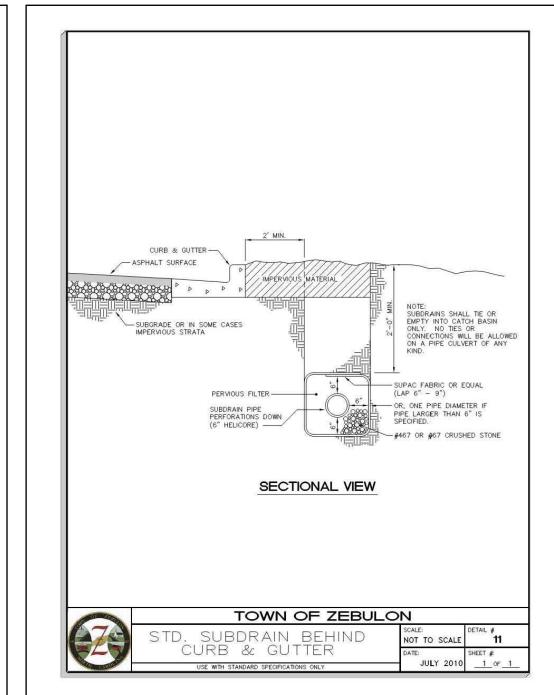
JSJ/MS DESIGNED BY: DRAWN BY: CHECKED BY: 2023018 PROJECT No. W-4081 DRAWING No. AS SHOWN SCALE:

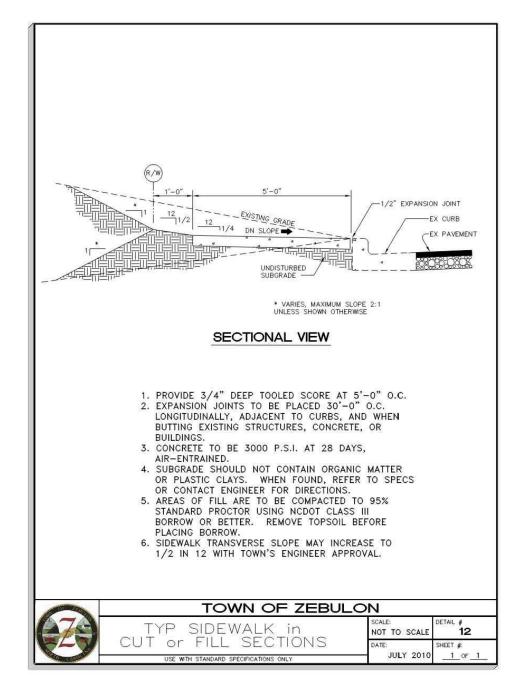


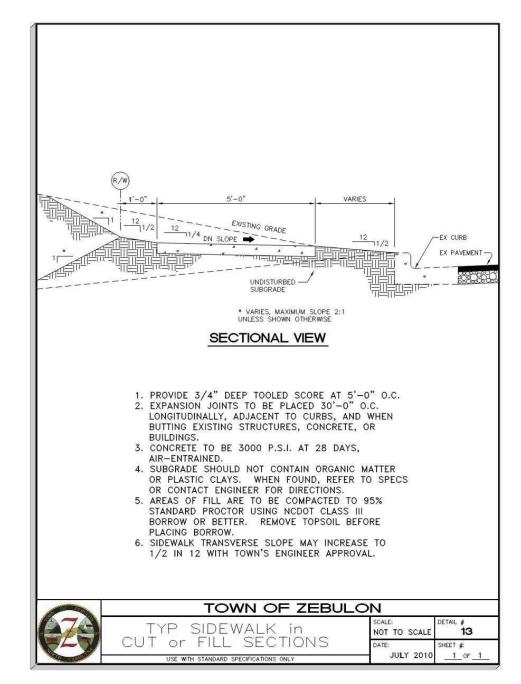


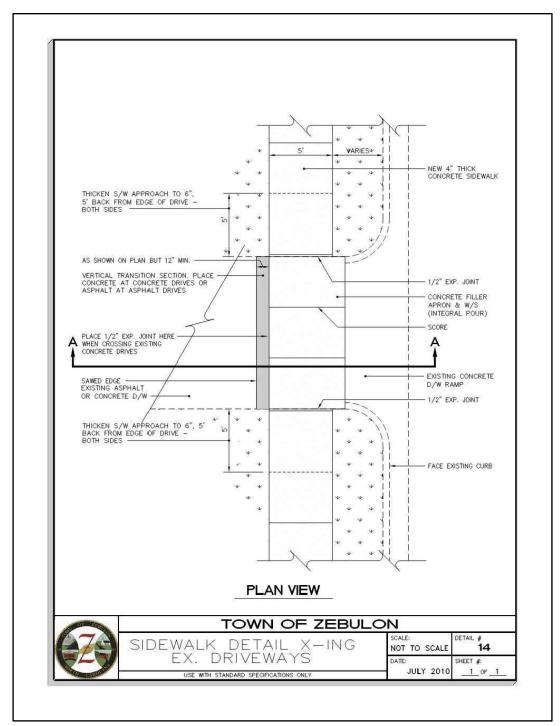


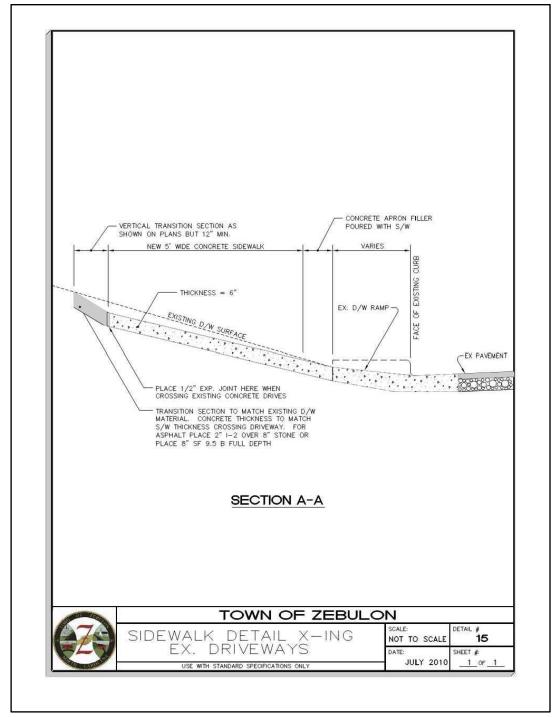


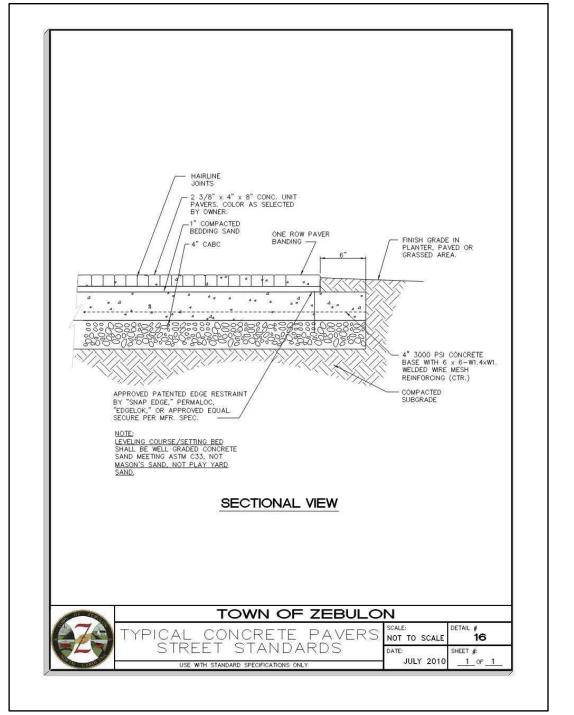


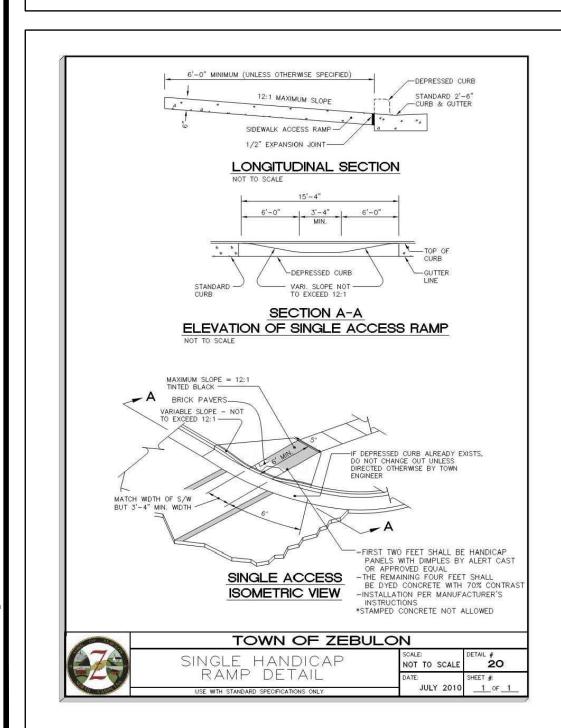


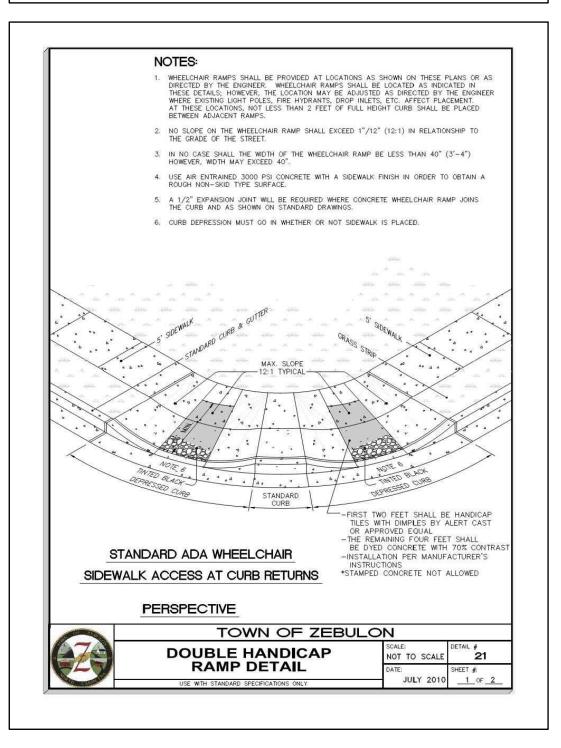


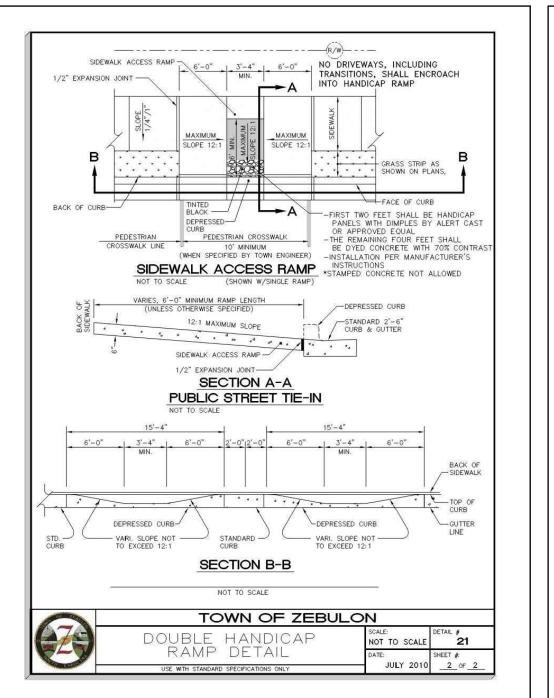


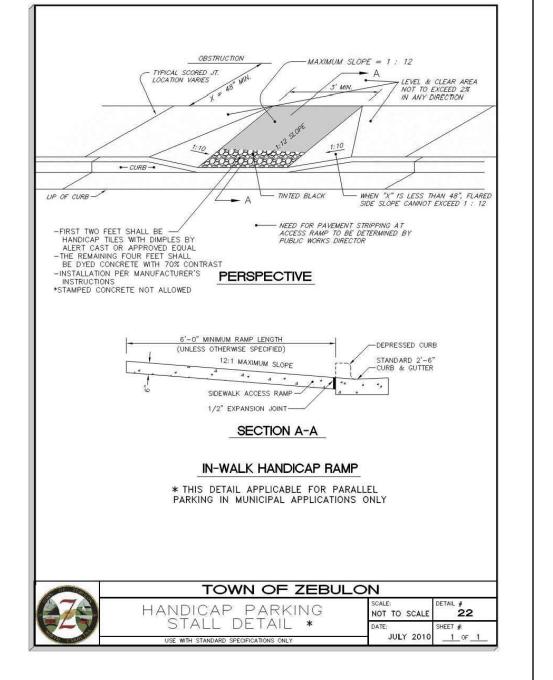












RELEASED FOR SITE PLAN REVIEW ONLY. NOT FOR CONSTUCTION.

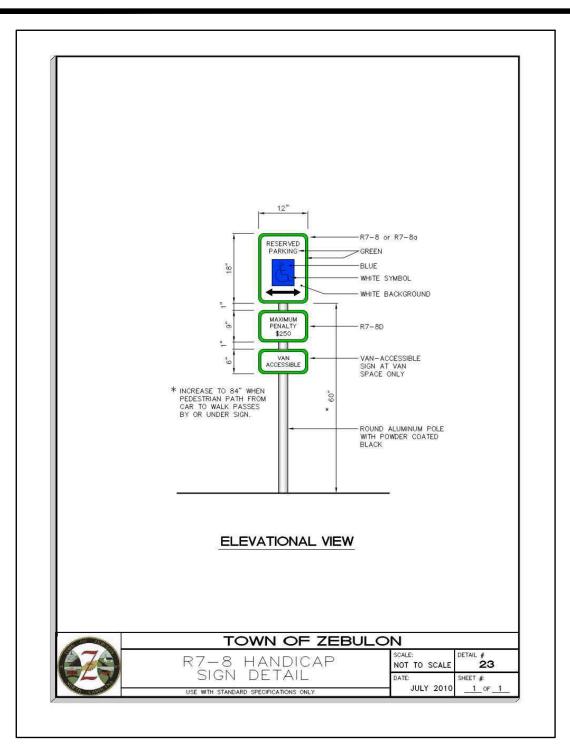


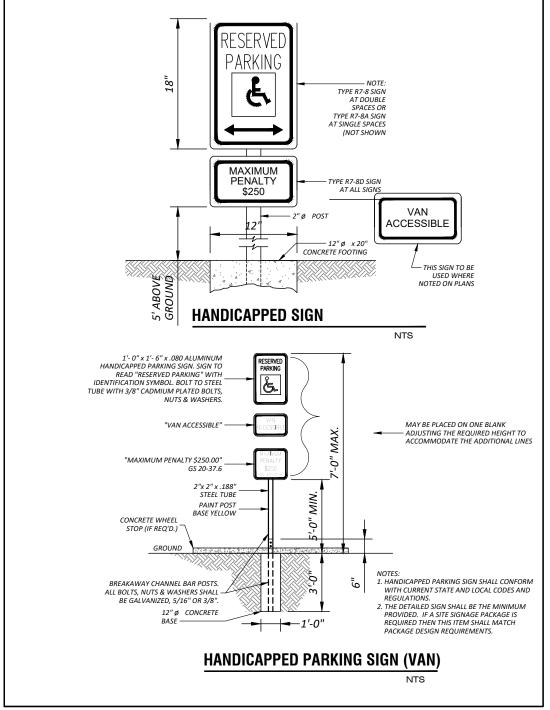
ALL CONSTRUCTION TO BE IN ACCORDANCE WITH TOWN OF ZEBULON, NCDOT & NCDEQ STANDARDS, SPECIFICATIONS AND DETAILS.

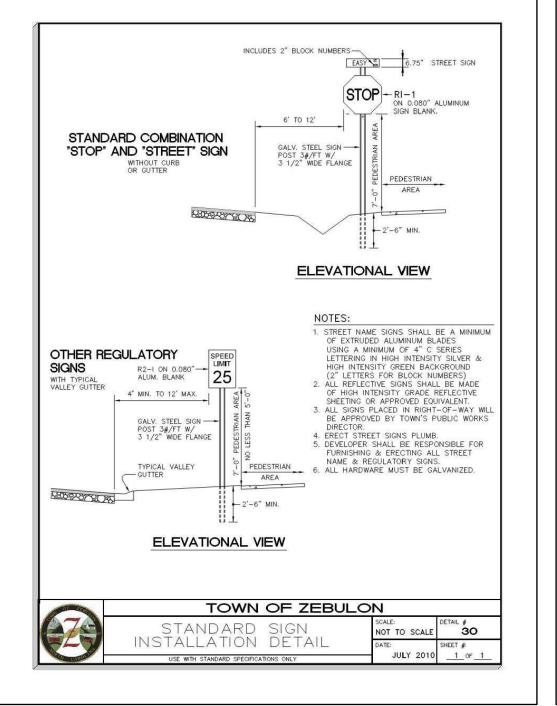
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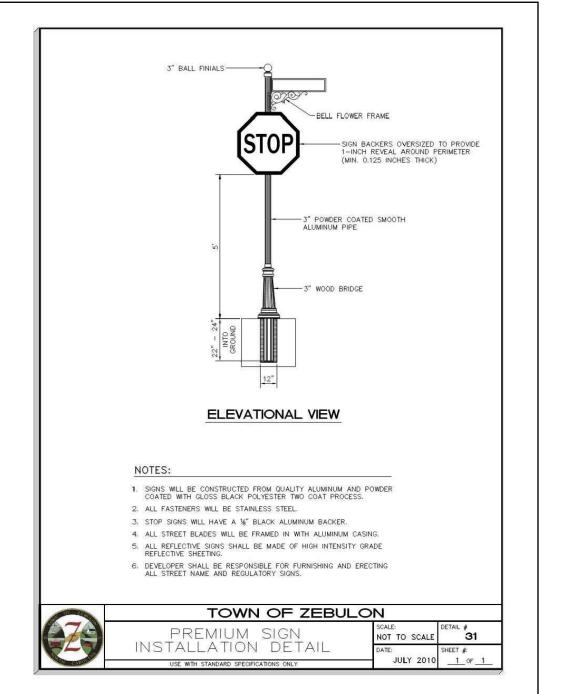
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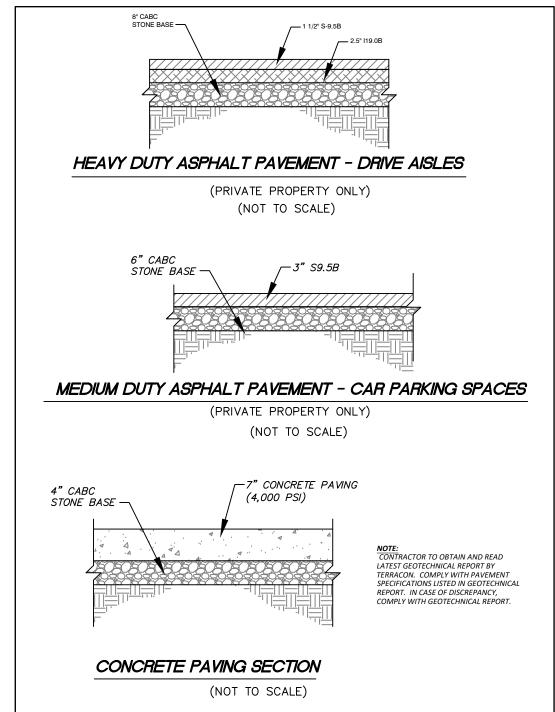
C2.10

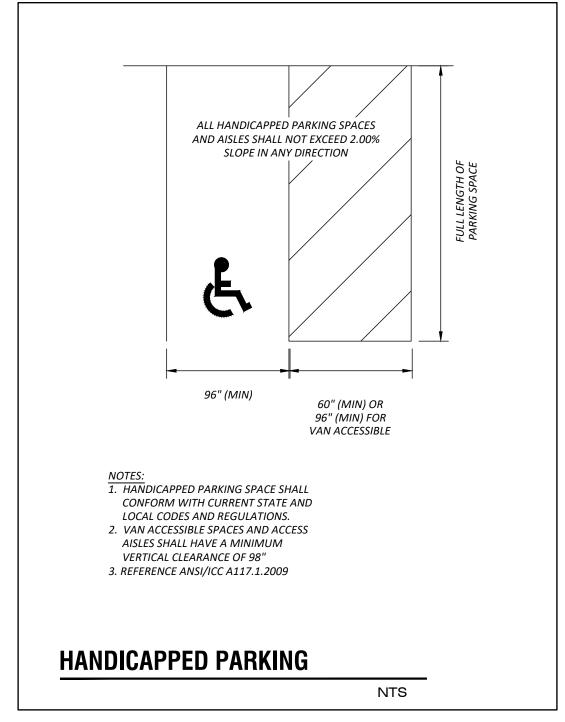


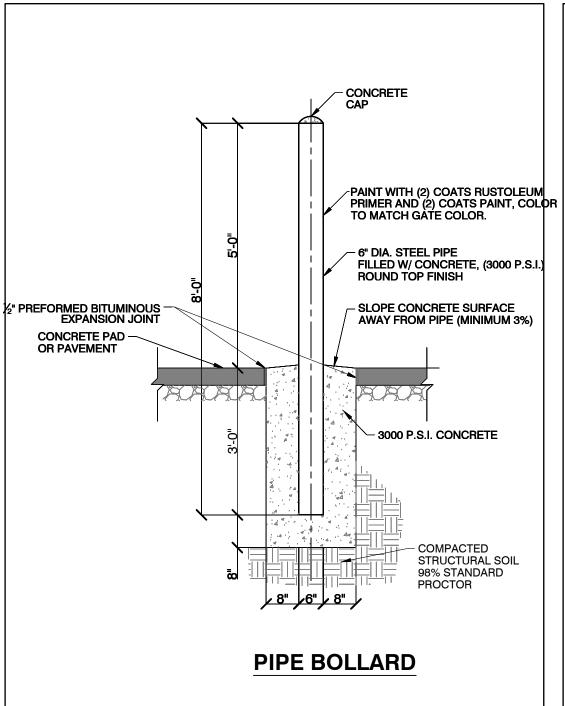


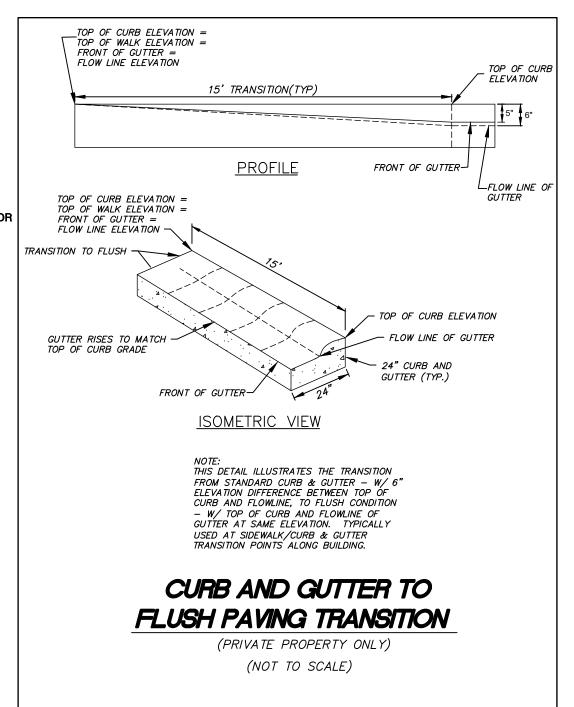


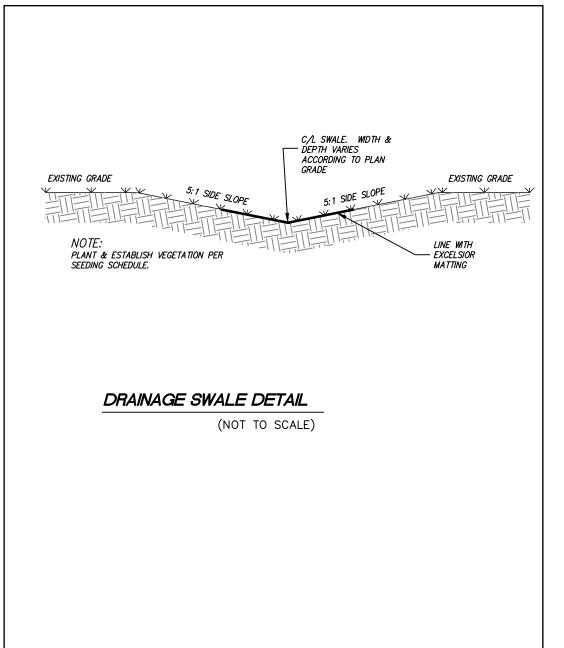














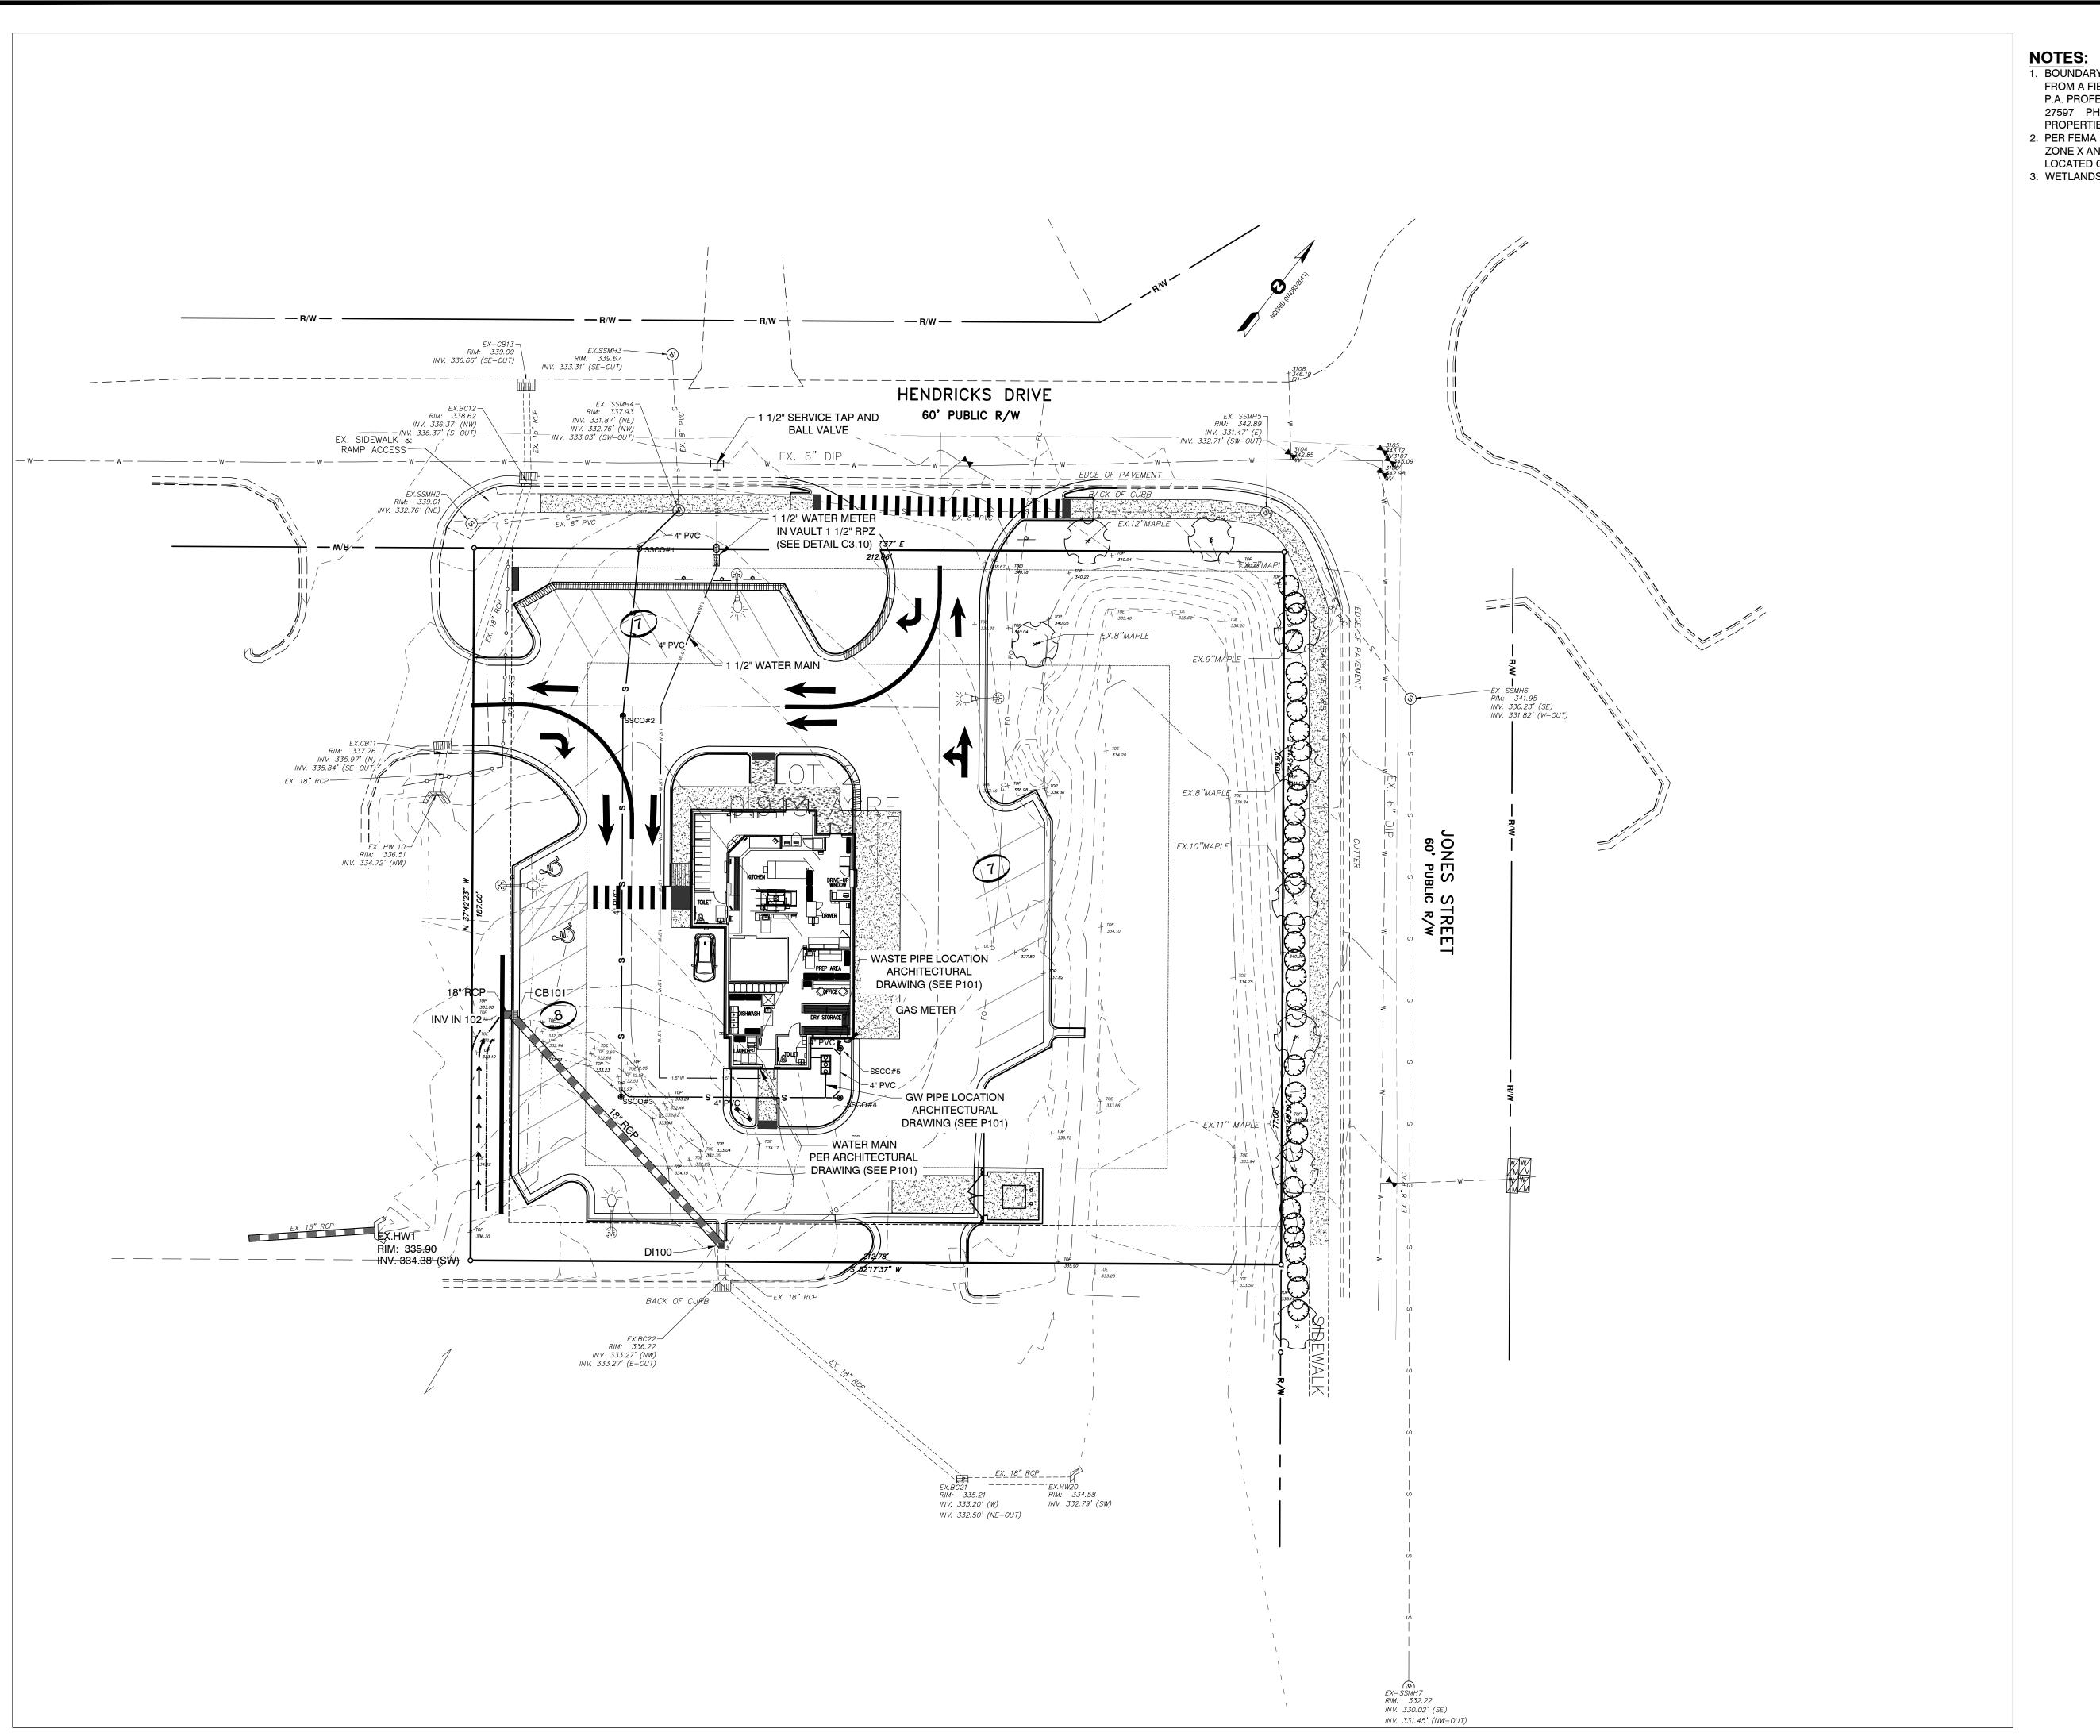
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C2.11

REVISIONS:

NOTE:

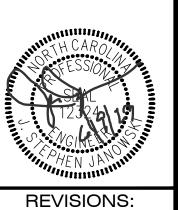
ALL CONSTRUCTION TO BE IN ACCORDANCE WITH TOWN OF GRIFTON, NCDOT & NCDEQ
RELEASED FOR SITE PLAN REVIEW ONLY. STANDARD BRECONSTIDICTION TOWN



1. BOUNDARY, TOPOGRAPHIC AND PLANIMETRIC FEATURES SHOWN ARE FROM A FIELD SURVEY PERFORMED BY WILLIAMS - PEARCE & ASSOC., P.A. PROFESSIONAL LAND SURVEYORS P.O. BOX 892, ZEBULON, N.C. 27597 PHONE (919) 269-9605 PROPERTY SURVEY FOR: PIEDMONT PROPERTIES ON 12/06/2022.

2. PER FEMA FIRM MAP 3720466000L DATED 7/7/14, THIS PROJECT IS IN ZONE X AND THEREFORE THERE IS NO REGULATORY FLOODPLAIN LOCATED ON THIS PROPERTY.

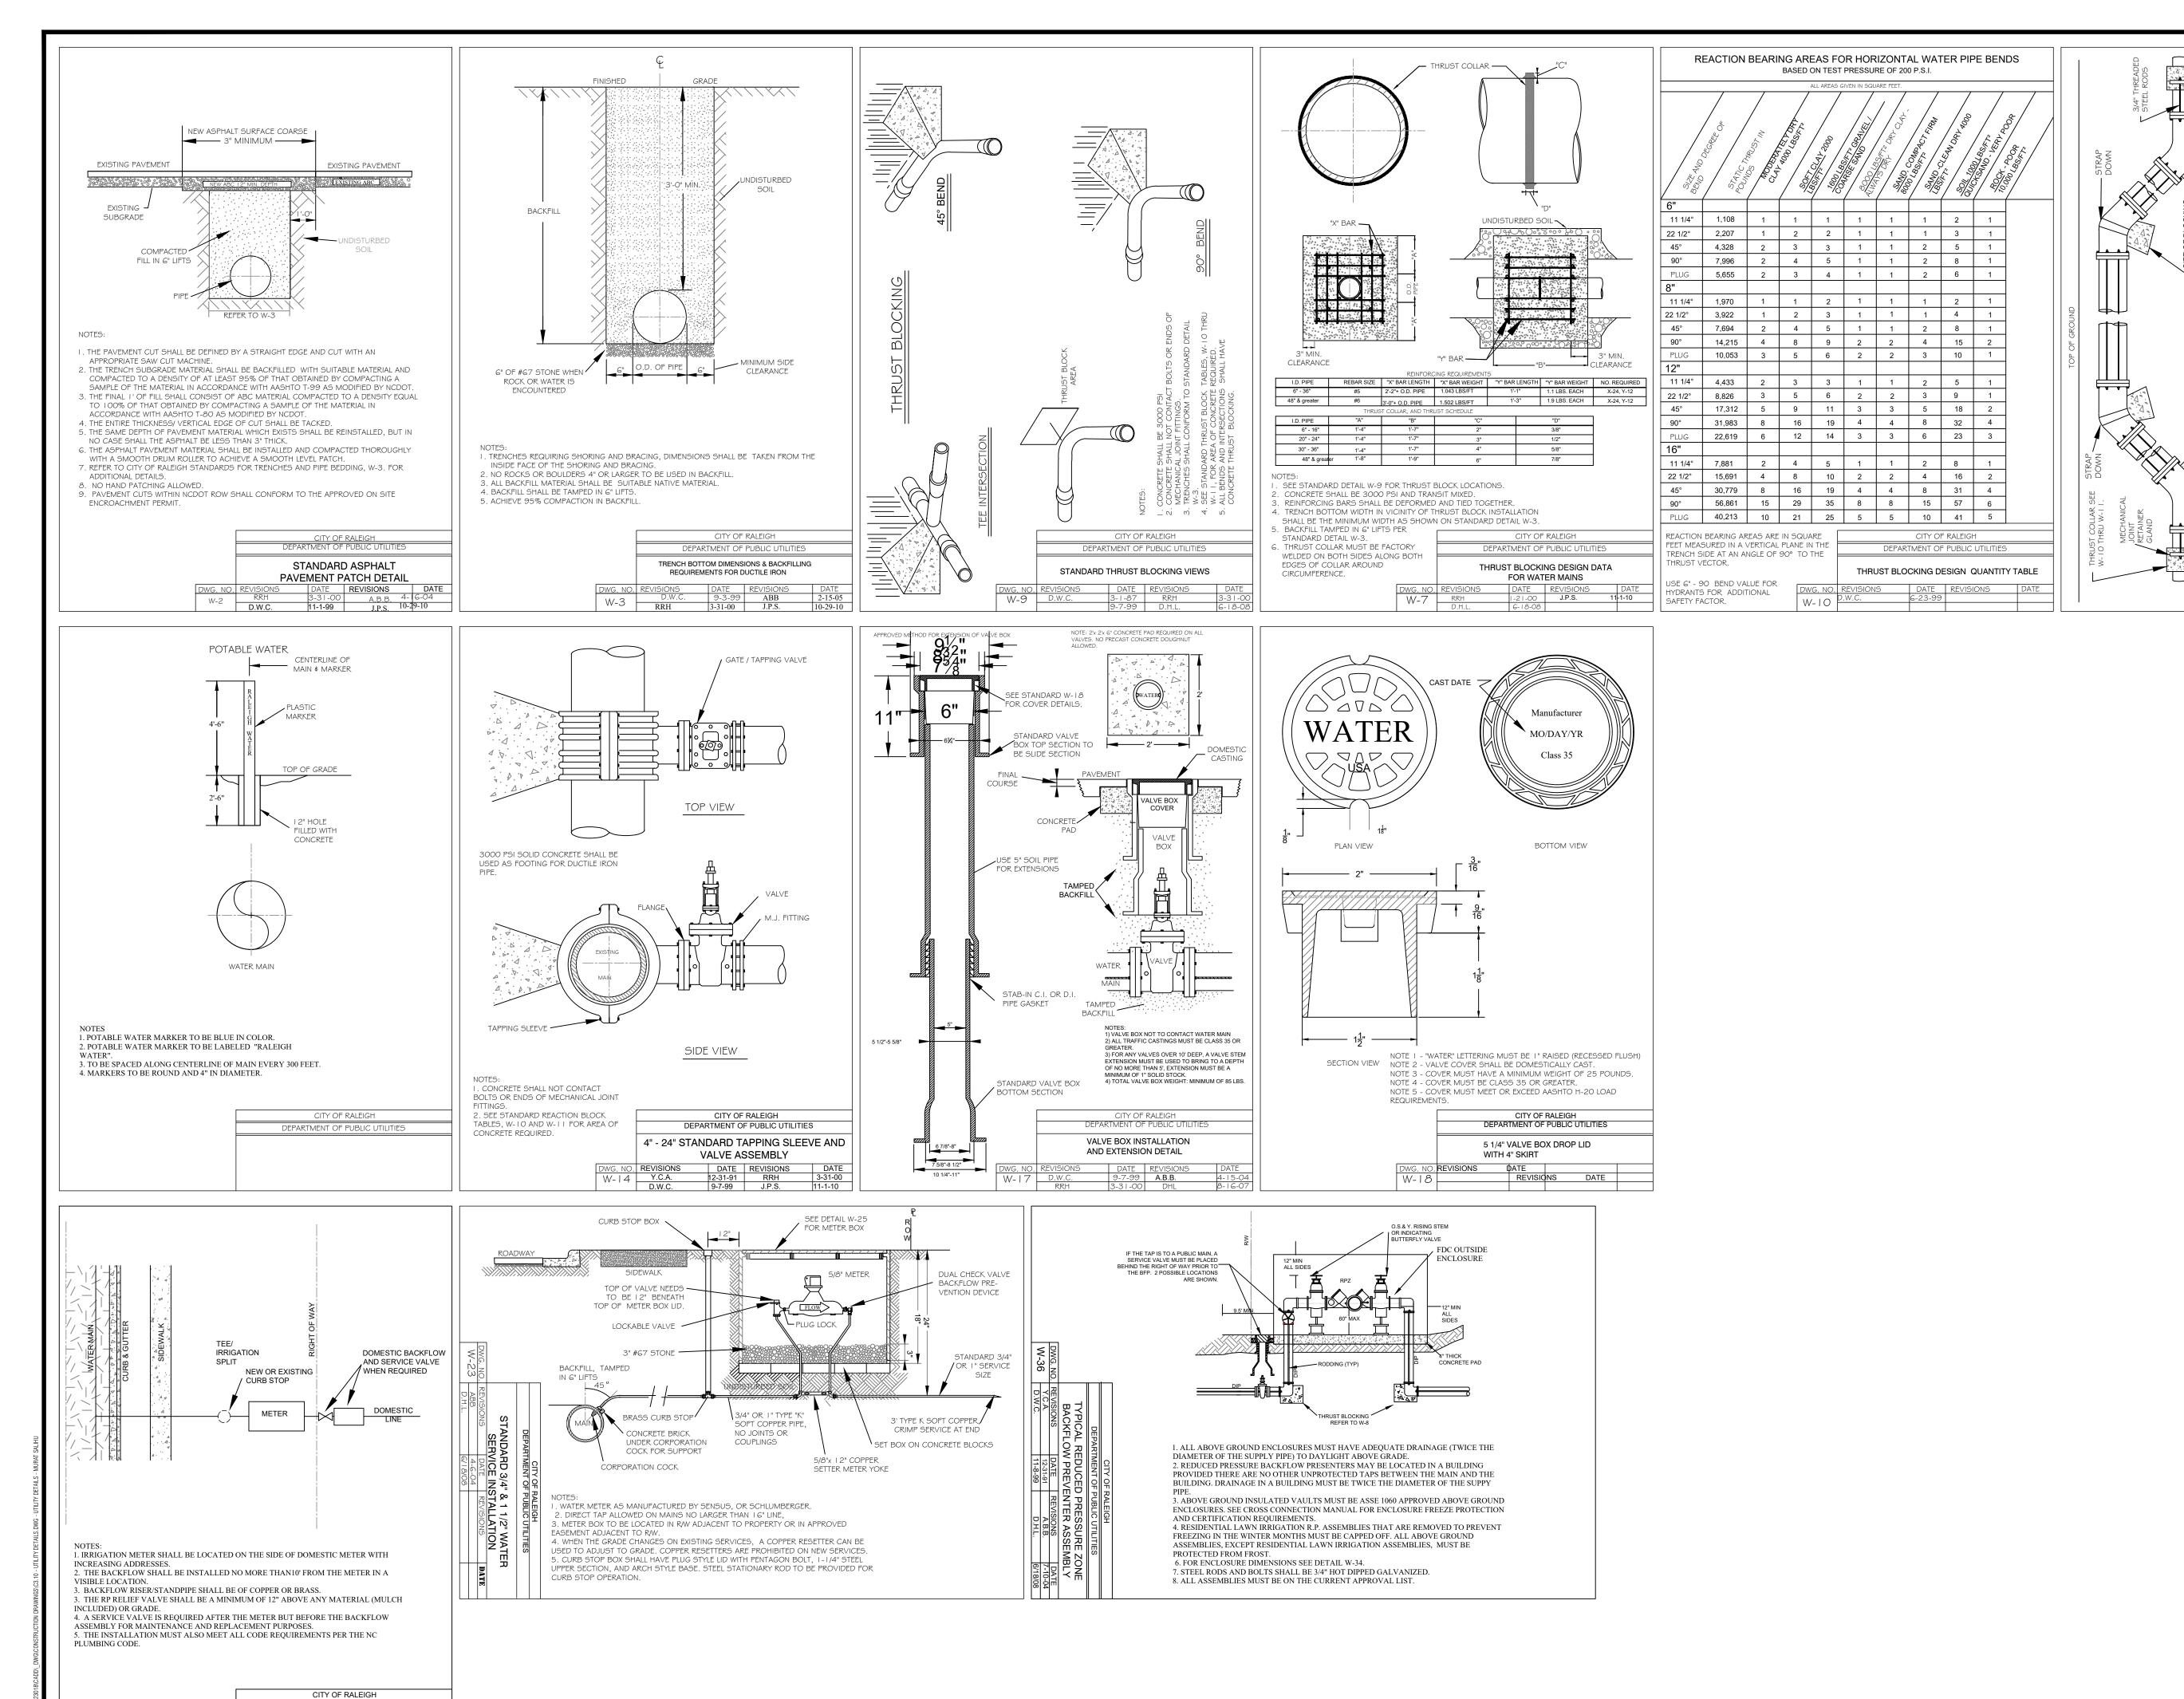
3. WETLANDS, STREAMS & ASSOCIATED BUFFERS TO BE DETERMINED.



	CONSTRUCTION DRAWINGS SUBMITTAL	06/01/23
NO.	DESCRIPTION	DATE

06/08/2023 JSJ/MS **DESIGNED BY:**

DRAWN BY: CALL BEFORE YOU DIG! WWW.NC811.ORG N.C. ONE-CALL CENTER IT'S THE LAW! CHECKED BY: 2023018 PROJECT No. W-4081 DRAWING No. AS SHOWN SCALE 1 inch = 20 ft

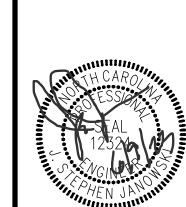


DEPARTMENT OF PUBLIC UTILITIES

IRRIGATION TAP ON NEW AND EXISTING

SERVICES

RELEASED FOR SITE PLAN REVIEW ONLY. NOT FOR CONSTUCTION.



REVISIONS:

GENERAL NOTES:

1. STEEL RODS AND BOLTS SHALL BE 3/4" HOT DIPPEE
2. CONCRETE SHALL NOT CONTACT BOLTS OR ENDS.
3. RESTRAINED MECHANICAL GLANDS TO BE USED A1
4. MUST USE DUCTILE IRON EYE BOLTS WHERE NECE
5. 3" MINIMUM COVER MUST BE MAINTAINED ON ALL M

- 4 w 4 w 1

CITY OF RALEIGH

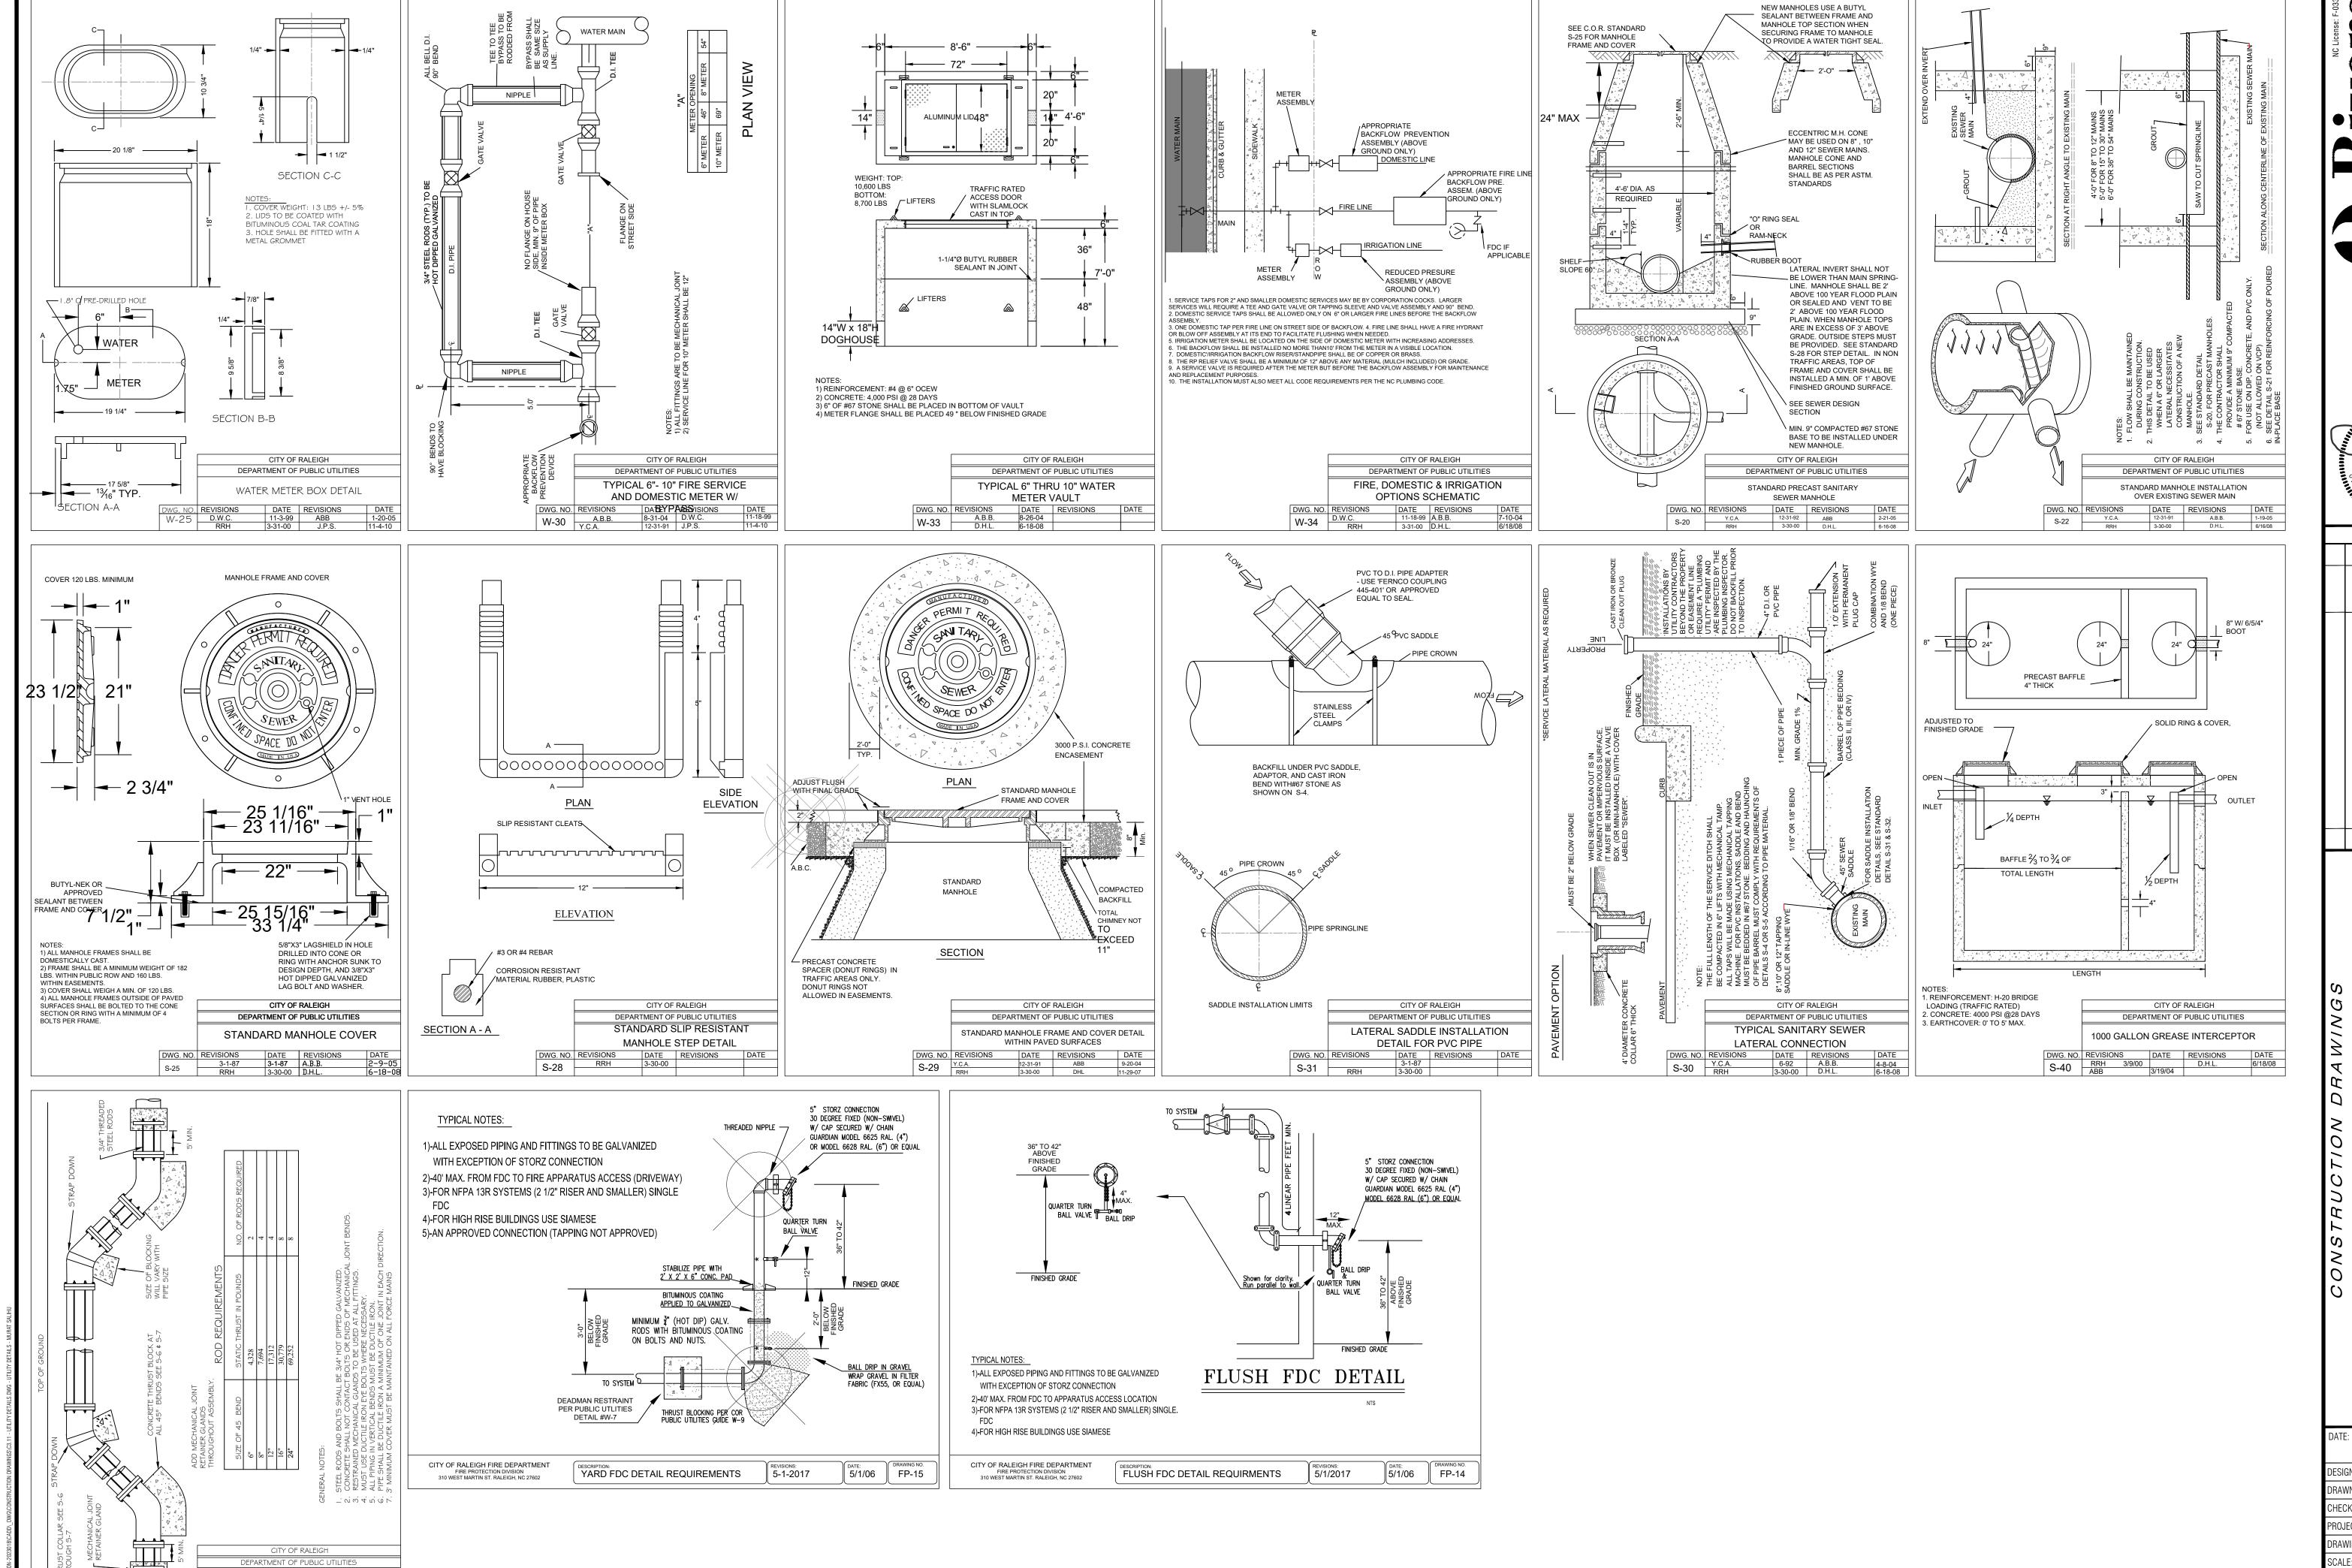
DEPARTMENT OF PUBLIC UTILITIES

STANDARD MAIN & VALVE MARKERS FOR POTABLAN RABSE WATER GALEAGEMENTS

7				
		CONSTRUCTION DRAWINGS SUBMITTAL	06/01/23	
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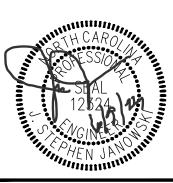
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C3.10



STANDARD VERTICAL BEND

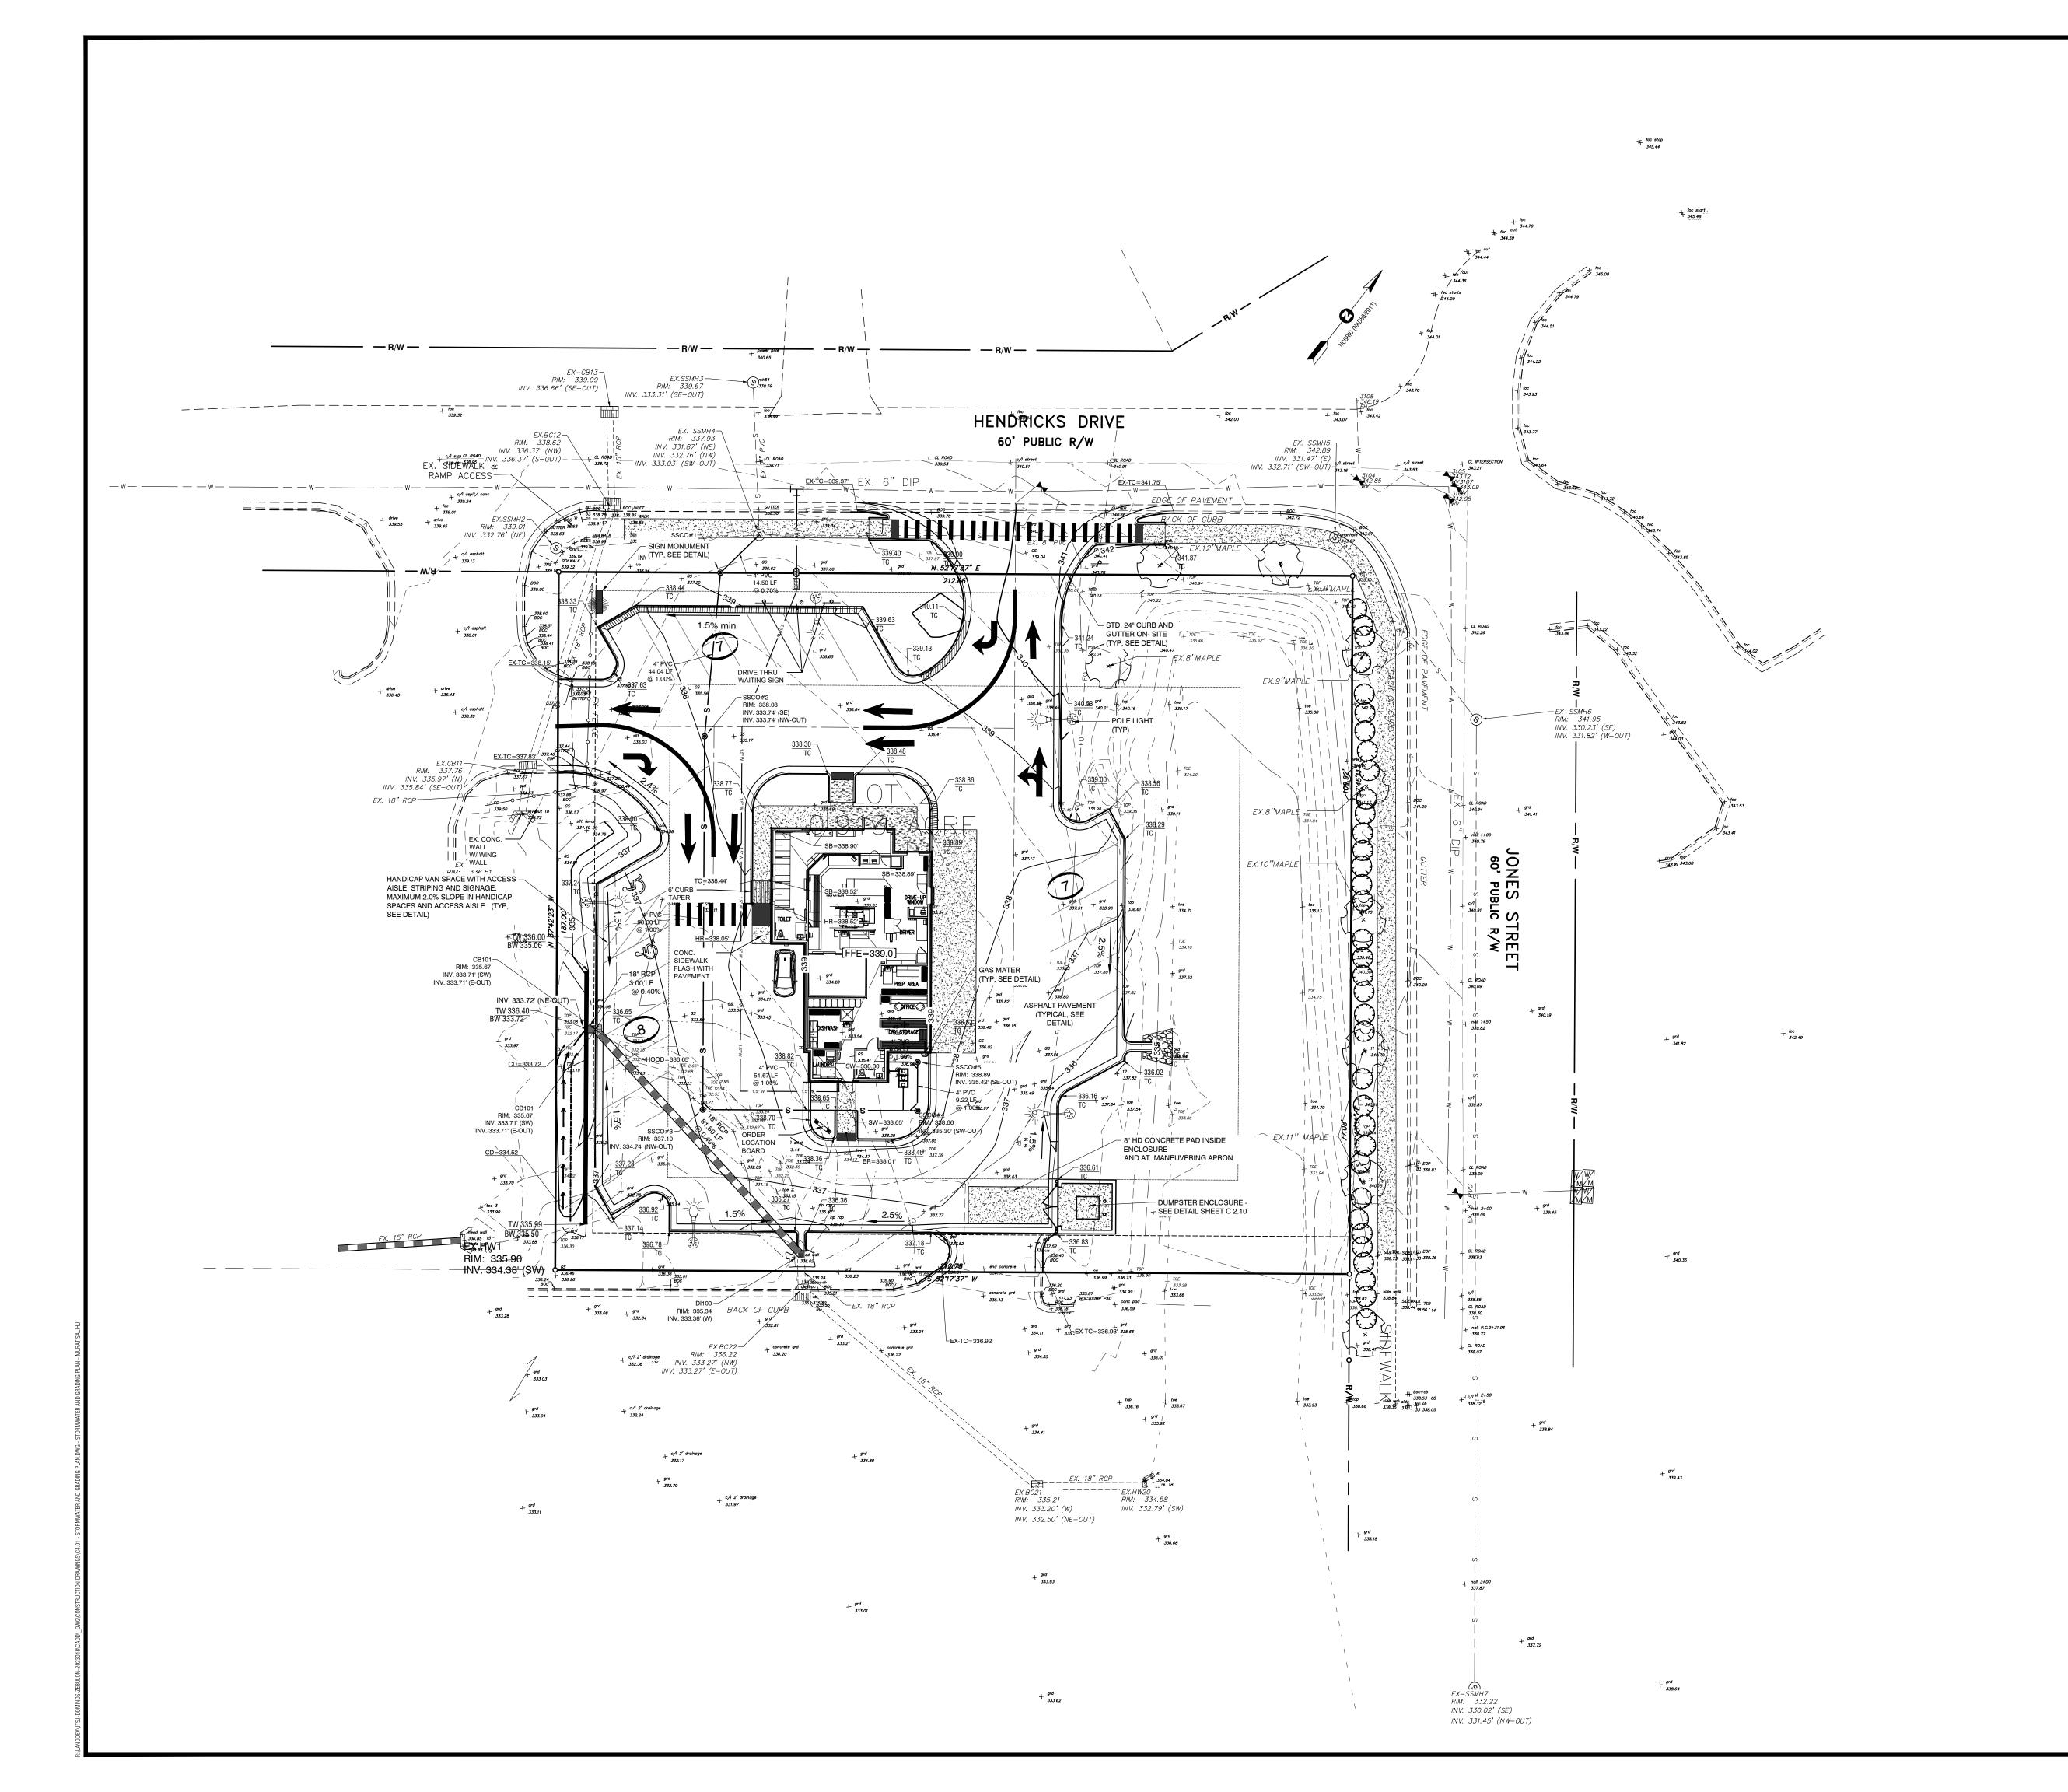




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06/08/2023 DBB/MS DESIGNED BY: DRAWN BY: DBB CHECKED BY: 2023018 PROJECT No. W-408⁻ RAWING No. AS SHOWN

C3.11



GENERAL NOTES:

- CONTRACTOR IS RESPONSIBLE FOR INSTALLING AND MAINTAINING A
 CONSTRUCTION ACCESS ROAD A MINIMUM OF 20' WIDE FROM THE
 EXISTING PAVEMENT TO THE SITE ENTRANCE. INSTALL A MINIMUM
 DEPTH OF 8" CABC.
- 2. BASE BID SHALL INCLUDE TOTAL OF 3' OF STRIPPING AND UNDERCUT FROM EXISTING GRADE IN PREPARATION OF SITE. THE AREA UNCUT SHALL EXTEND TO THE LIMITS OF DISTURBANCE WITHIN THE BOUNDARY OF THE PROPERTY TO THE PROPOSED RIGHT OF WAY.

 3. PRIOR TO PLACING FILL, EXISTING VEGETATION AND ROOT MAT SHOULD BE REMOVED. AREA BELOW THE BASE BID LIMITS SHALL BE
- FIELD MEASURED AND IDENTIFIED AS UNDERCUT.

 4. BASE BID SHALL INCLUDE STRIPPING DEPTHS UP TO 3 FEET TO REMOVE ORGANICS ASSOCIATED WITH THE CLEAR-CUT STUMPS. STUMP HOLES SHOULD BE ENLARGED, SOMEWHAT LEVELED UP AND BACKFILLED WITH COMPACTED FILL. AREAS MAY NEED TO HAVE A NON-WOVEN GEOSYNTHETIC FABRIC INSTALLED AT THE DIRECTION OF THE GEOTECHNICAL ENGINEER WHERE ADDITIONAL UNDERCUT AND BACKFILL WILL NOT BRIDGE THE EXCAVATION
- 5. AFTER STRIPPING, UNDERCUTTING, INSTALLING NON-WOVEN GEOSYNTHETIC, AND PRIOR TO PLACING FILL, THE EXPOSED SUBGRADE SOILS IN THE PAVEMENT FOOTPRINTS SHOULD BE COMPACTED/DENSIFIED IN PLACE USING A MEDIUM WEIGHT VIBRATORY ROLLER. THE PURPOSE OF THE VIBRATORY ROLLING IS TO COMPACT/DENSIFY THE EXPOSED SUBGRADE SOILS FOR PAVEMENT SUPPORT. THE ROLLER SHOULD MAKE AT LEAST SIX PASSES ACROSS THE SITE AND PROPOSED DRIVE, WITH THE SECOND SET OF THREE PASSES PERPENDICULAR TO THE FIRST SET OF THREE PASSES ON THE SITE. IF WATER IS BROUGHT TO THE SURFACE BY THE VIBRATORY ROLLING, THE OPERATION SHOULD BE DISCONTINUED UNTIL THE WATER SUBSIDES. VIBRATORY ROLLING SHOULD BE COMPLETED DURING DRY WEATHER. AFTER THE VIBRATORY ROLLING, PORE PRESSURES SHOULD BE ALLOWED TO DISSIPATE FOR A MINIMUM OF 16 HOURS.
- 6. AFTER THE WAITING PERIOD, PROOFROLLING SHOULD BE PERFORMED ON THE EXPOSED SUBGRADE SOILS IN AREAS TO RECEIVE FILL OR AT THE DESIGN GRADE WITH A FULLY LOADED, TANDEM-AXLE DUMP TRUCK OR SIMILAR RUBBER- TIRED CONSTRUCTION EQUIPMENT (20-TON MINIMUM). PROOFROLLING IS RECOMMENDED AS A MEANS OF DETECTING AREAS OF SOFT OR UNSTABLE SUBGRADE SOILS. THE PROOFROLLING SHOULD BE PERFORMED DURING A PERIOD OF DRY WEATHER TO AVOID DEGRADING AN OTHERWISE SUITABLE SUBGRADE.
- 7. A NON-WOVEN GEOSYNTHETIC IS TO BE USED AT THIS SITE. AFTER INSTALLING THE GEOSYNTHETIC, LOOSE FILL SHOULD BE DUMPED ONTO THE GEOSYNTHETIC AND SPREAD WITH TRACK/LOW GROUND PRESSURE EQUIPMENT THAT WILL NOT DAMAGE THE NON-WOVEN GEOSYNTHETIC. NO WHEEL OR TRACK TRAFFIC SHOULD OPERATE DIRECTLY ON THE GEOSYNTHETIC. THE INITIAL LIFT SHOULD BE LOOSE AND 10 TO 12 INCHES THICK. CONSTRUCTION TRAFFIC MAY OPERATE ON TOP OF THE FILL LAYER. THE NON-WOVEN GEOSYNTHETIC SHALL HAVE A TENSIL STRENGTH OF 180 LBS AND AN ELONGATION AT THE BREAK OF 50%. IT SHALL HAVE A MULLEN BURST OF 330 PSI AND HAVE A PERMITTIVITY OF 1.4 SEC⁻¹.
- 8. IT IS IMPORTANT TO NOTE THAT THE USE OF RUBBER-TIRED TRAFFIC, SUCH AS LULLS, MAY IMPACT THE PREPARED SUBGRADE SOILS LEADING TO REQUIRED RE-GRADING. WE RECOMMEND THAT THE USE OF RUBBER-TIRED TRAFFIC BE LIMITED TO THE PREPARED SUBGRADES OR THAT THE STABILIZED AREA BE PREPARED FOR SUCH

1. MAXIMUM DENSITY AND OPTIMUM WATER CONTENT AS DETERMINED BY THE STANDARD PROCTOR TEST (ASTM D 698).

2. HIGH PLASTICITY COHESIVE FILL SHOULD NOT BE COMPACTED TO MORE THAN 100% OF STANDARD PROCTOR MAXIMUM DRY DENSITY.

EXISTING PROPERTY LINE **─────** RIGHT OF WAY ——— ———— МАЈОR ТОРО — — — *159* — — — MINOR TOPO ______ TREE LINE -----DITCH CENTERLINE ----- TOP OF DITCH REINF. CONC. PIPE GRADE BREAK SLOPE ARROW ×<u>155.86</u> SPOT ELEVATION **ASPHALT** FUTURE ROAD

-1.1%

-1.1%

-1.280

VO'S ZEBULON
NO WAKE COUNTY ON ORTH CAROLINA
TER AND GRADING PL

REVISIONS:

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20' 0 10' 20 SCALE 1 inch = 20 ft DATE: 06/08/2023

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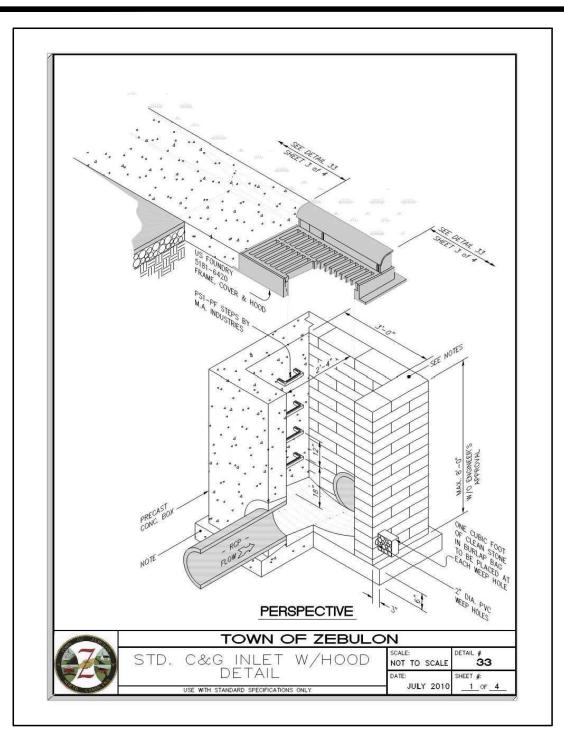
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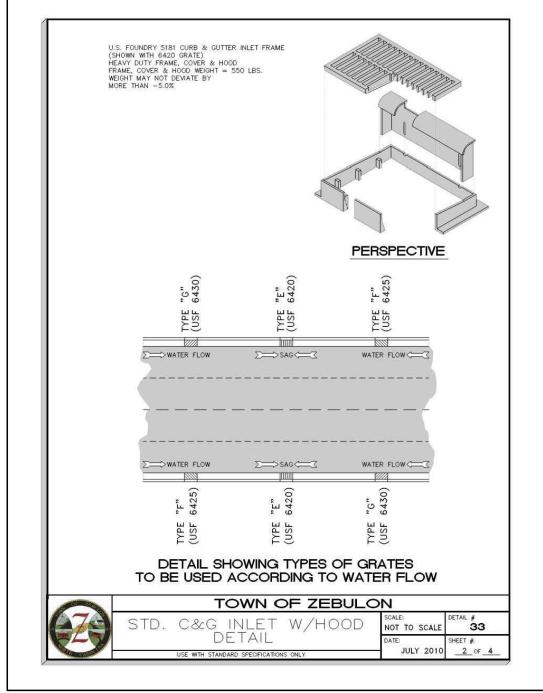
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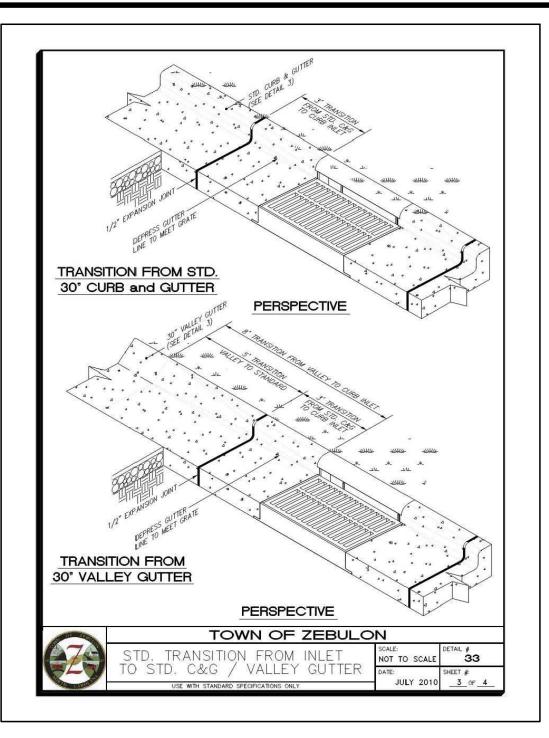
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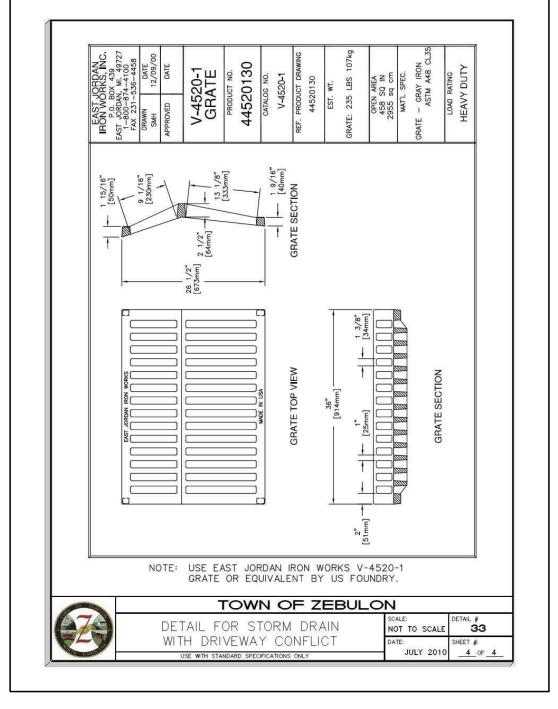
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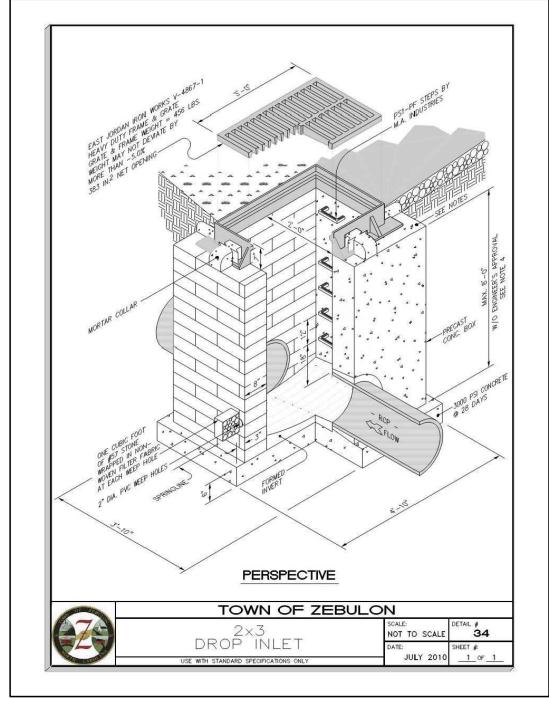
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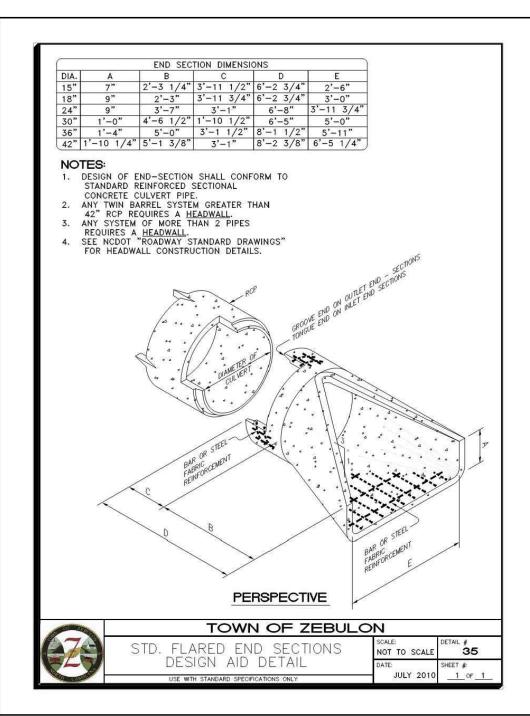


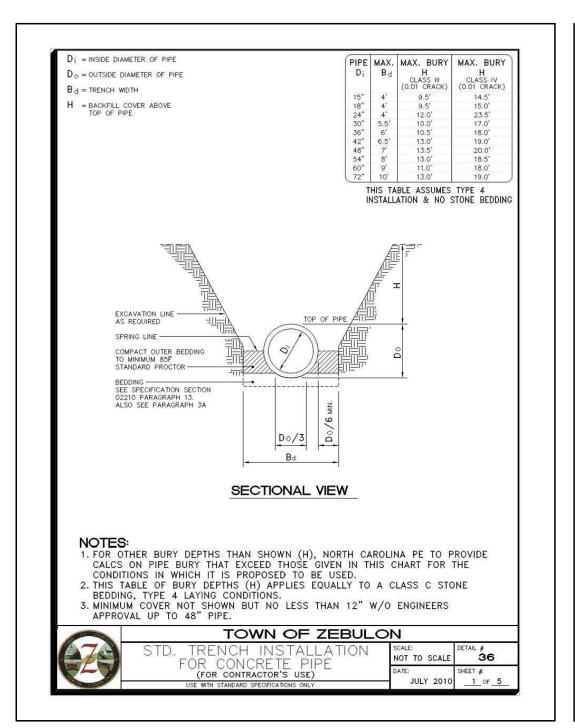


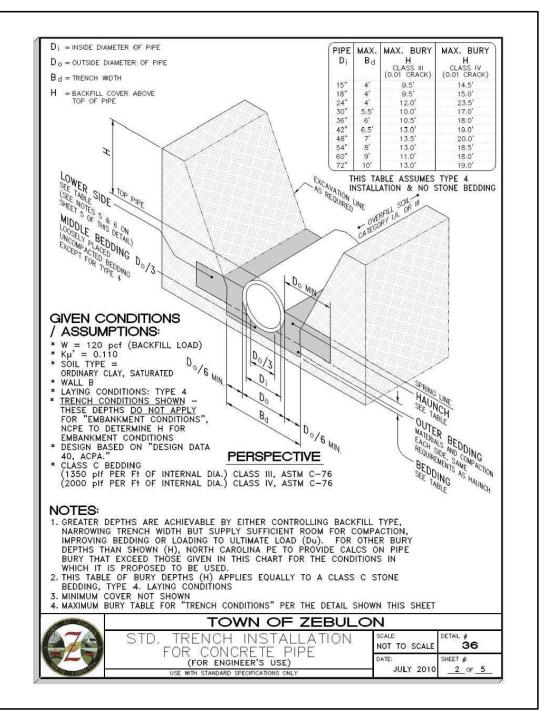












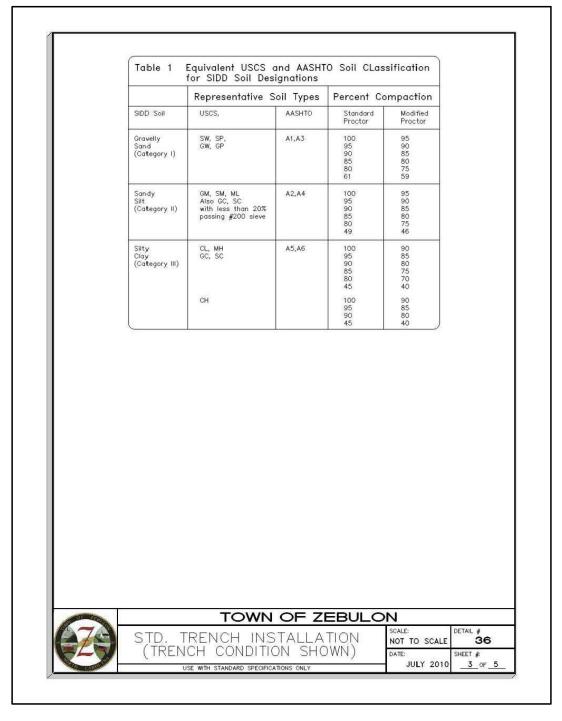
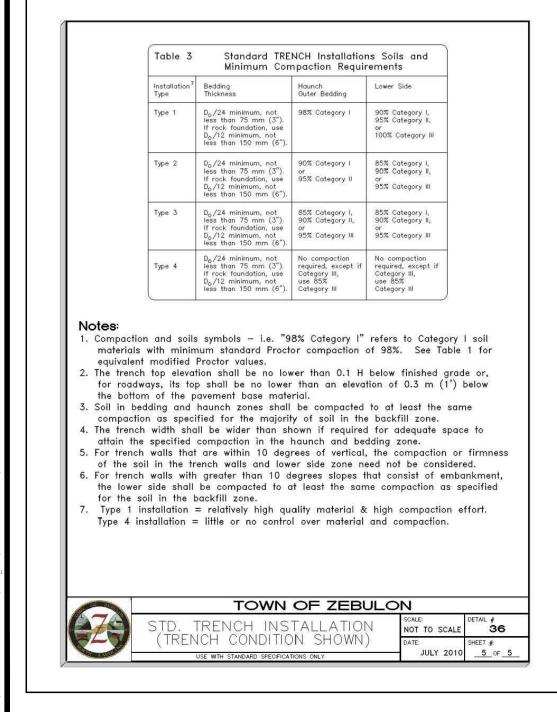
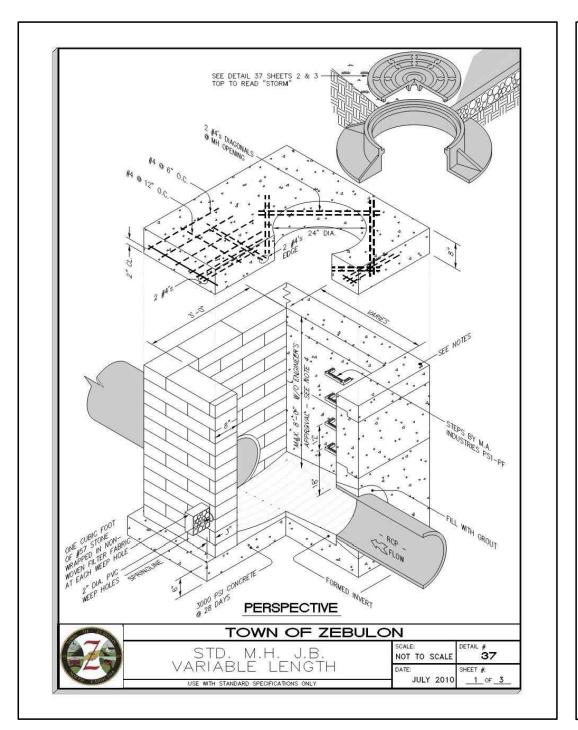
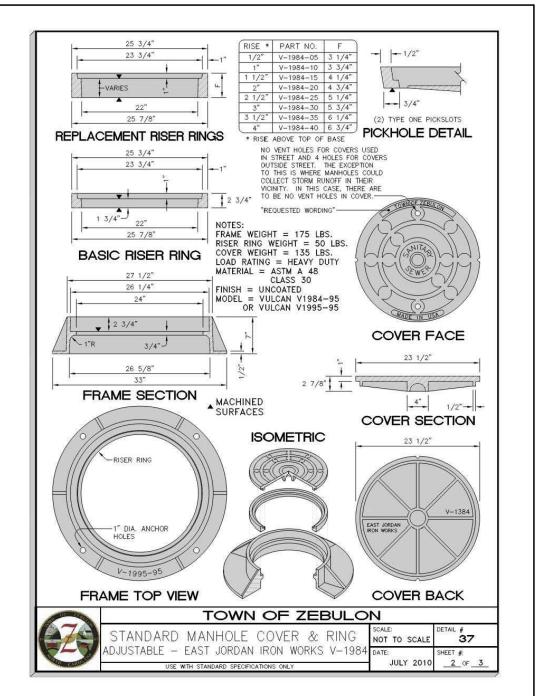
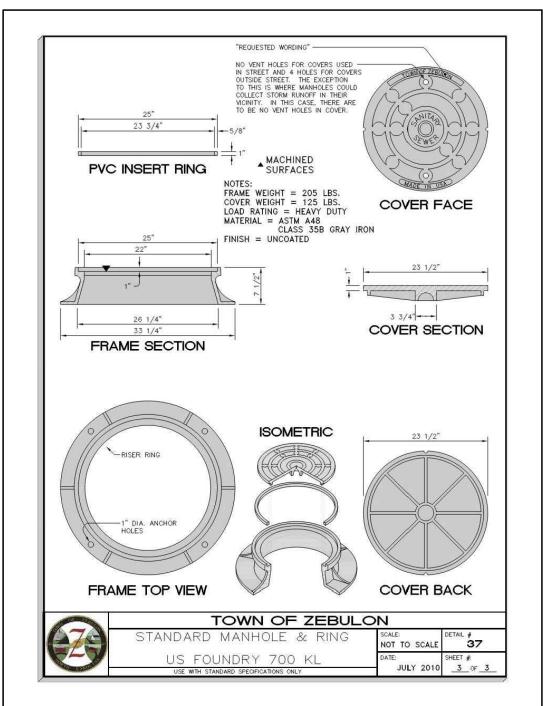


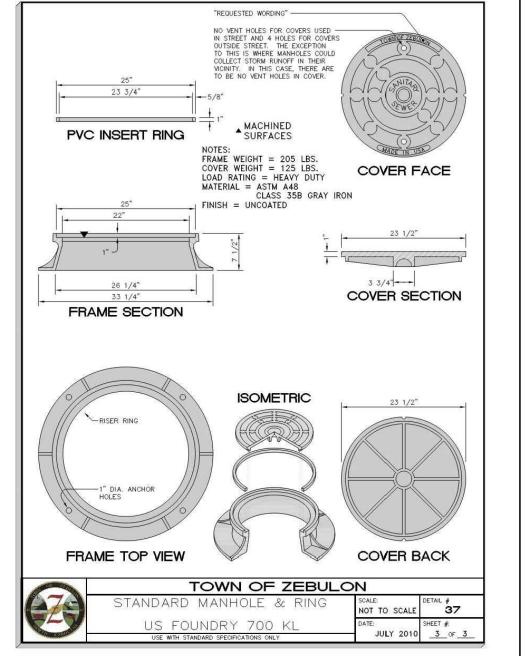
Table 2	Standard EMBANKMEN Compaction Requirem		and Minimum		
Installation Type ⁴	Bedding Thickness	Haunch and Outer Bedding	Lower Side		
Туре 1	D ₀ /24 minimum, not less than 75 mm (3"). If rock foundation,use D ₀ /12 minimum, not less than 150 mm (6").	98% Category I	90% Category I, 95% Category II, or 100% Category III		
Type 2 D ₀ /24 minimum, not les than 75 mm (3"). If rock foundation, use D ₀ /12 minimum,not less than 150 mm (6").					
Type 3	$D_0/24$ minimum, not less than 75 mm (3"). If rock foundation, use $D_0/12$ minimum, not less than 150 mm (6").	85% Category I, 90% Category II, or 95% Category III	85% Category I, 90% Category II, or 95% Category III		
Type 4	$D_0/24$ minimum, not less than 75 mm (3"). If rock foundation, use $D_0/12$ minimum, not less than 150 mm (6").	No compaction required, except if Category III, use 85% Category III	No compaction required, except if Category III, use 85% Category III		
naterial with a requivalent modification the outer he pipe springling and in the minimum with the pipe subtrenches he subtrench was compaction requipality of soil is compacted to the Type 1 installation.	coils symbols — i.e. "9 minimum standard Proceed Proctor values. bedding, haunch, and we, shall be compacted oil in the overfill zone lefined as a trench with or roadways, its top is of the pavement base of the pavement base of the pavement show attain the specified with wall of natural so ll shall be at least as rements specified for the or the overfill zone, or especified level. on = little or no control	ctor compaction of lower side zones, to at least the sate that an elevation lose material. all be 1.33 Do or compaction in the boil, any portion of firm as an equivalent tower side zone shall be removed ality material & highlights and the lower side shall waterial and the lower side zone shall be removed ality material & highlights at least the side of the lower side zone shall be removed.	98%. See Table except within DO/3 me compaction as ished grade by mer than 0.3 m (wider if required haunch and bedd the lower side zor lent soil placed to and as firm as and replaced with the compaction eff	1 for 6 from 5 the ore 1') for ng ne in 5 the the soil	



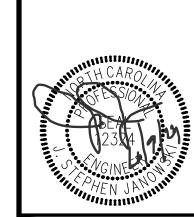






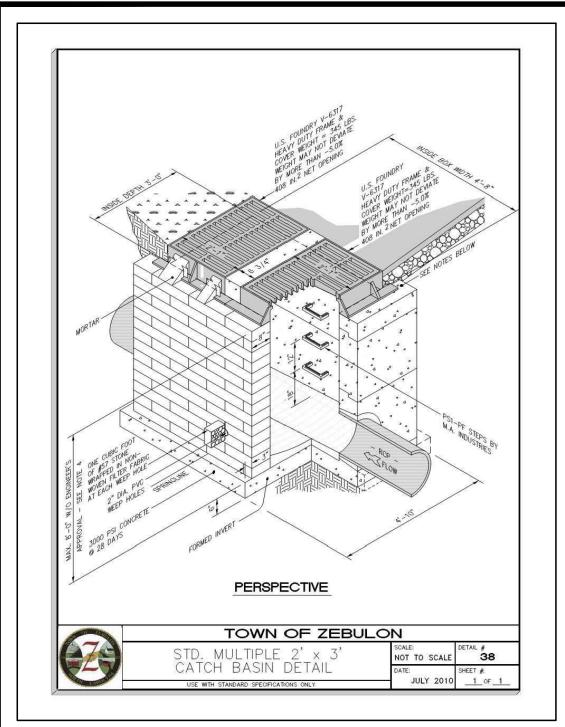


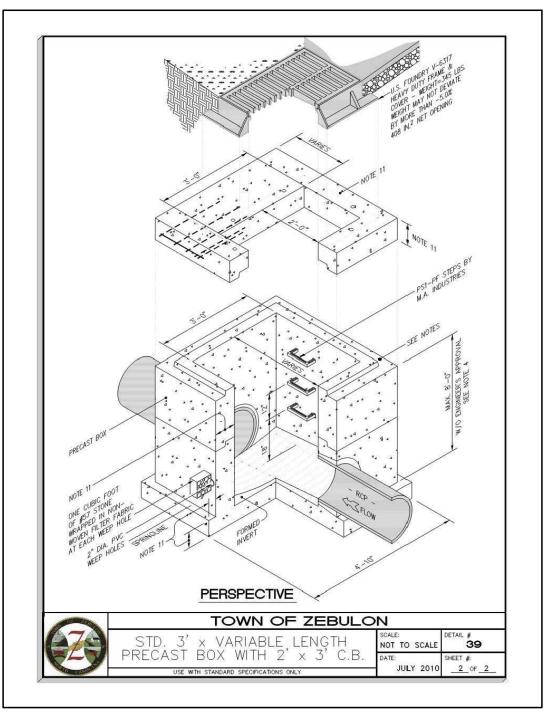
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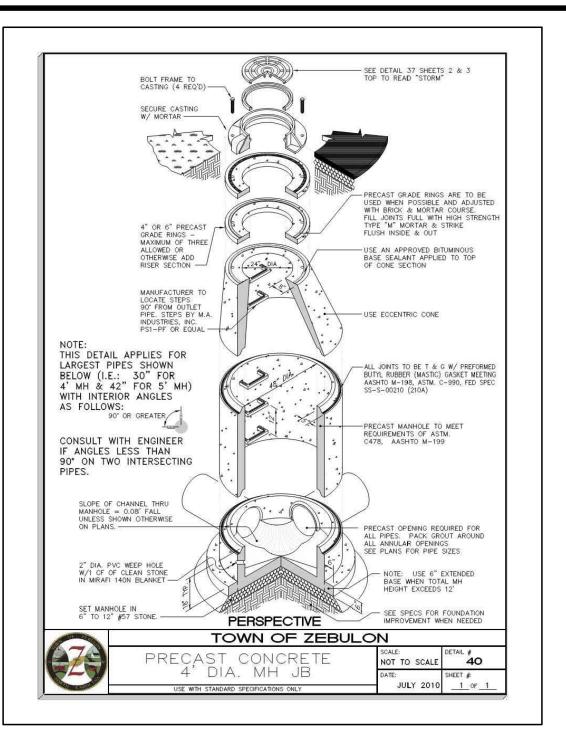


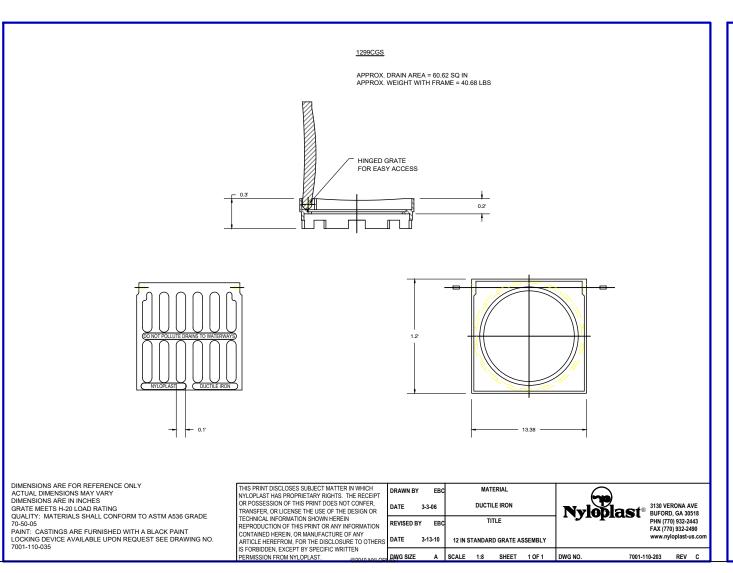
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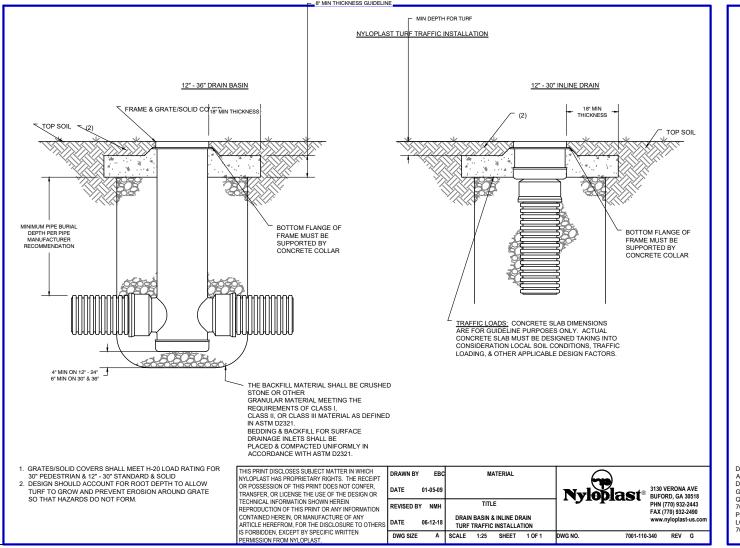
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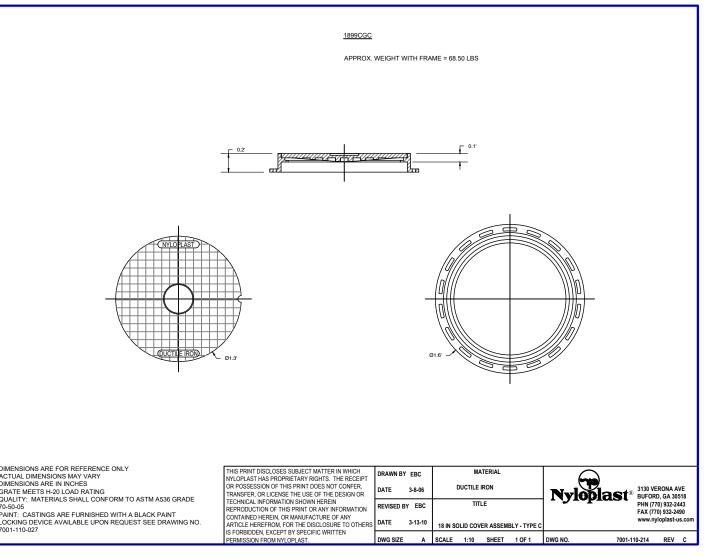


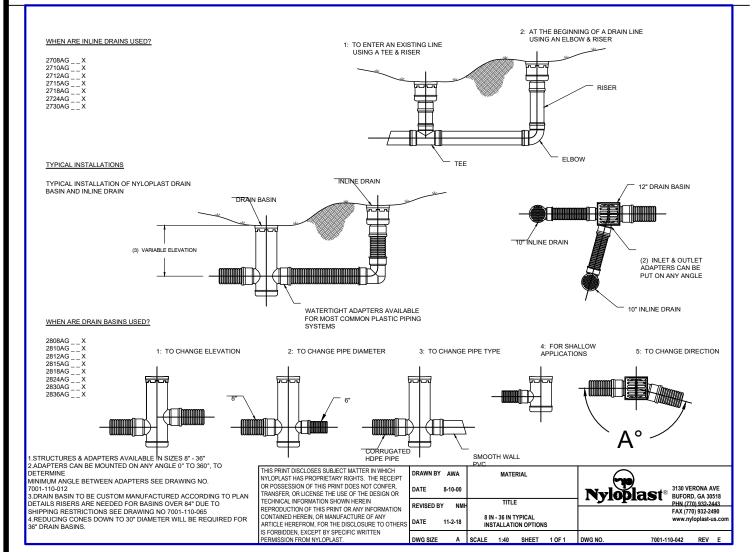


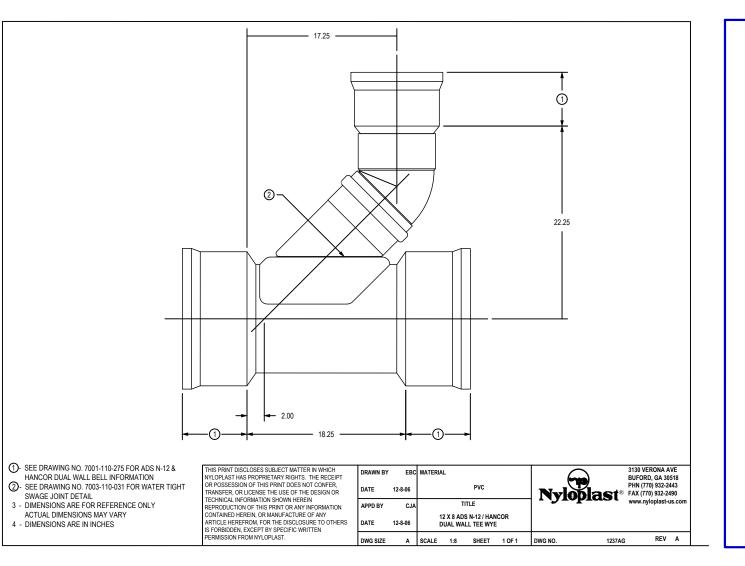


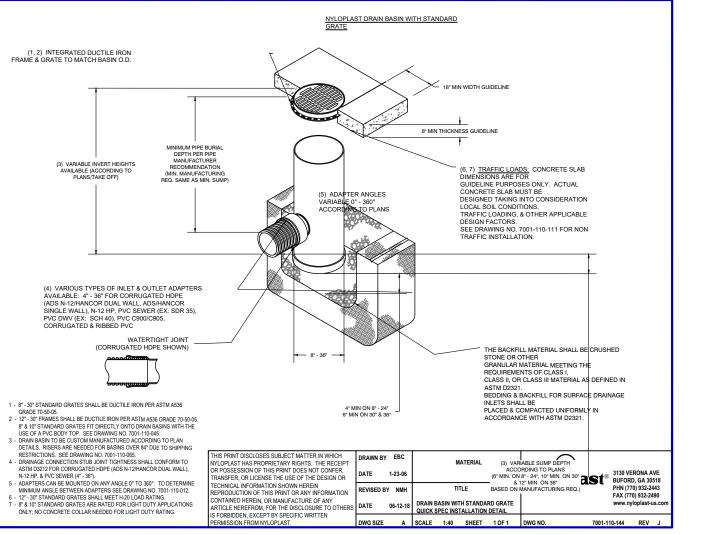


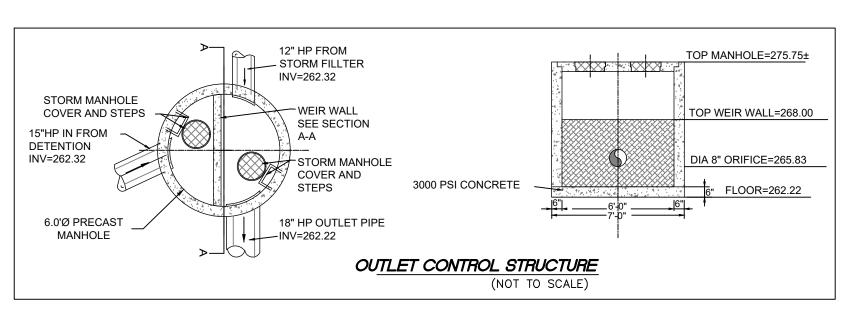












NOTE:

ALL CONSTRUCTION TO BE IN ACCORDANCE WITH
TOWN OF GRIFTON, NCDOT & NCDEQ

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LOIS ZEBULON

WN OF ZEBULON ~ WAKE COUNTY
STORM DET

DATE: 06/08/2023

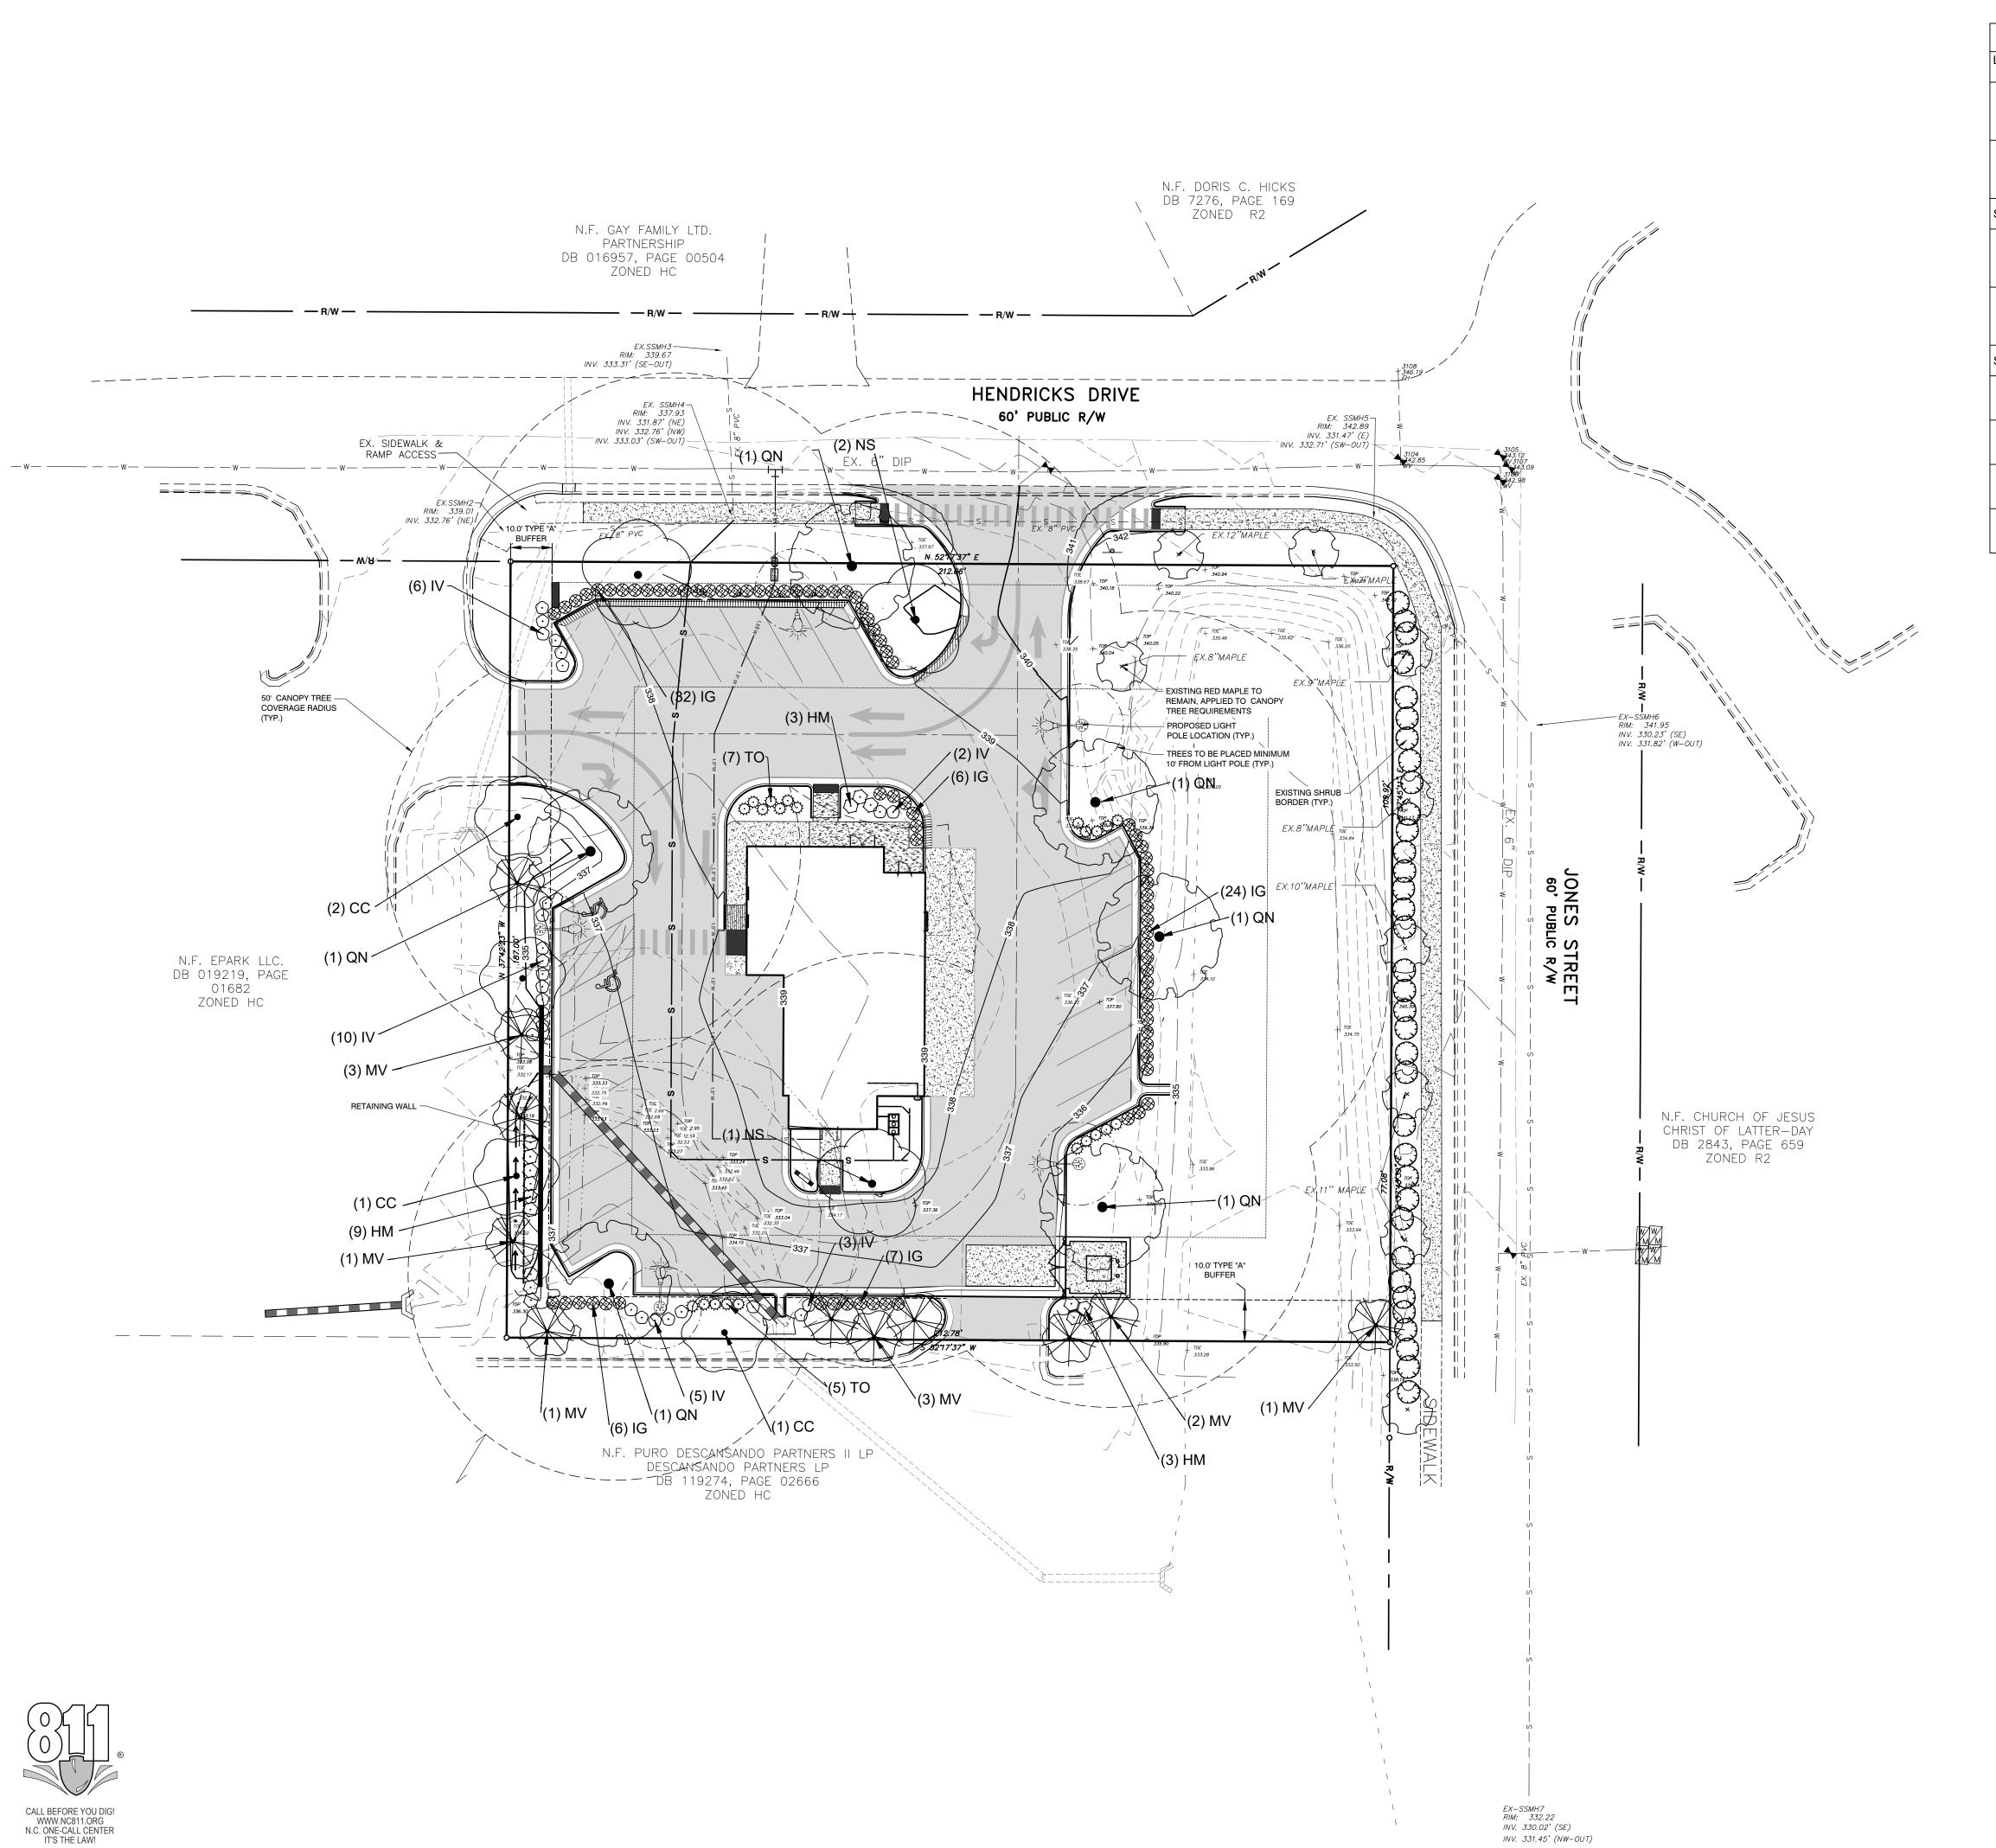
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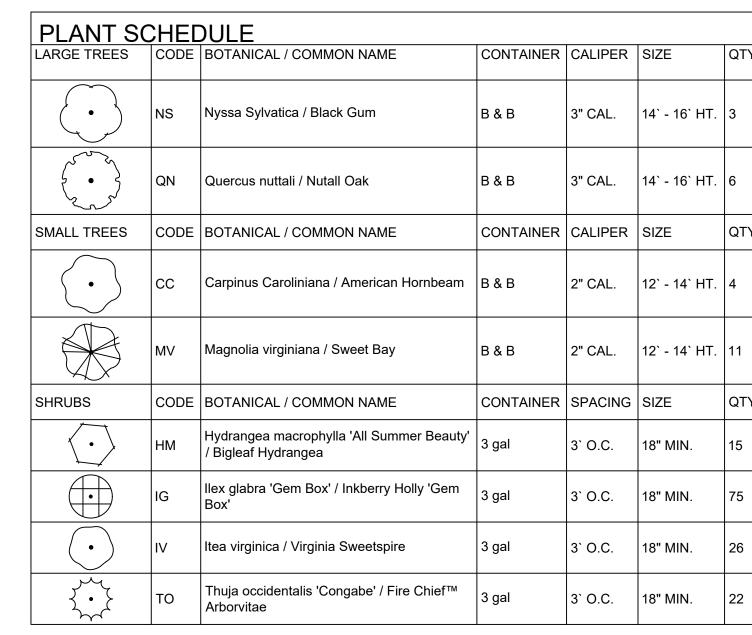
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PROJECT No. 2023018

DRAWING No. W-408
SCALE: AS SHOWN



INV. 331.45' (NW-OUT)



LANDSCAPE CALCULATIONS

PARKING LOT:

SHADE TREES -REQUIRED - 1 CANOPY TREE / 12 OFF-STREET PARKING SPACES 22 PARKING SPACES = 2 CANOPY TREE REQUIRED PROPOSED - 2 CANOPY TREES, ALL PARKING SPACES WITHIN 50' OF A CANOPY TREE TRUNK LOCATION

INTERIOR PLANTINGS -REQUIRED - 3 SHRUBS / PARKING LOT ISLAND WHERE CANOPY TREE IS NOT PROVIDED. PROPOSED - N/A

PERIMETER PLANTINGS -

REQUIRED - SINGLE CONTINUOUS ROW OF EVERGREEN SHRUBS (MAX. 3' O.C.) ADJACENT TO PARKING LOT PERIMETER, WITHIN 5' OF PARKING LOT EDGE. PERIMETER PLANTINGS NOT REQUIRED ALONG COMMON BOUNDARY BETWEEN PARKING PROPOSED - EVERGREEN SHRUB ROW ADJACENT TO PARKING LOT

AT NORTHEAST AND NORTHWEST. SOUTHEAST AND SOUTHWEST PARKING LOT SHARES COMMON BOUNDARY WITH ADJACENT PARKING LOTS. 48 TOTAL EVERGREEN SHRUBS PROVIDED.

PERIMETER BUFFERS: REQUIRED - PERIMETER BUFFER PLANTINGS ALONG ADJACENT LOTS. SITE ZONING = HC

REAR LOT - ZONE HC = TYPE 'A' BUFFER "SEPARATION" (188 LF WITHOUT DRIVEWAY WIDTH) NO CANOPY TREES REQUIRED 1 UNDERSTORY TREE / 100 LF, 188 LF = 8 TREES REQUIRED 15 SHRUBS / 100 LF, 188 LF = 29 SHRUBS REQUIRED SIDE LOT - ZONE HC = TYPE 'A' BUFFER "SEPARATION" (162 LF WITHOUT DRIVEWAY WIDTH)

NO CANOPY TREES REQUIRED 1 UNDERSTORY TREE / 100 LF, 162 LF = 7 TREES REQUIRED 15 SHRUBS / 100 LF, 187 LF = 25 SHRUBS REQUIRED

PROPOSED - REAR LOT - TYPE 'A' BUFFER 8 SMALL TREES PROVIDED, 29 SHRUBS PROVIDED SIDE LOT - TYPE 'A' BUFFER 7 SMALL TREES PROVIDED, 25 SHRUBS PROVIDED.

REQUIRED - EVERGREEN SHRUBS OR DECORATIVE GRASSES (MIN. 18") LOCATED WITHIN 10' OF BUILDING FOUNDATION WALL VISIBLE FROM PUBLIC STREET.

1 CANOPY TREE / 2,000 SF OF LOT AREA FOR FIRST 20,000 SF OF LOT. 0.91 AC = \pm 4-39640 SF, 10 TREES REQUIRED.

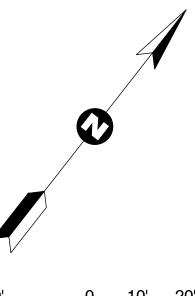
PROPOSED - 18 SHRUBS PROVIDED AT FOUNDATION FACING HENDRICKS DRIVE. 9 NEW CANOPY TREES PROVIDED, 1 EXISTING TREE

STREET BUFFERS: REQUIRED - NONE (LOT LINE NOT BOUNDED BY ANY COLLECTOR OR ARTERIAL STREETS.)

NOTES:

FOUNDATION:

1. ALL UNPAVED AREAS OF THE SITE WILL BE COVERED WITH HYBRID TURF TYPE TALL FESCUE SOD OR AGED TRIPLE SHREDDED HARDWOOD MULCH (3" - 4" DEPTH) IN A TYPICAL FASHION FOR THIS TYPE OF PROJECT.



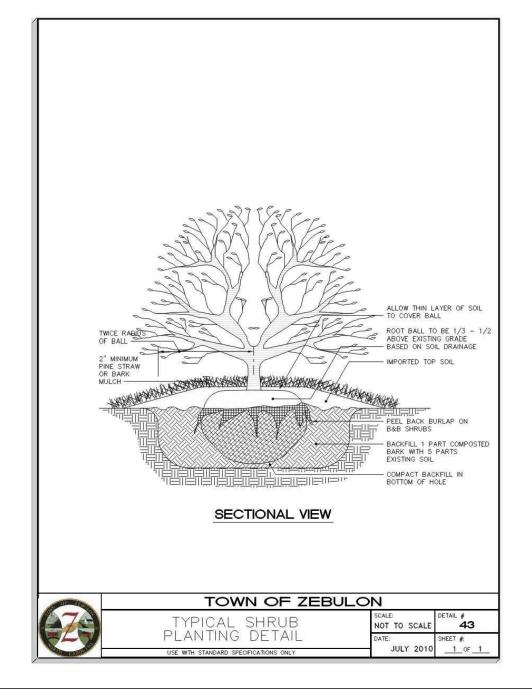
SCALE 1 inch = 20 ft

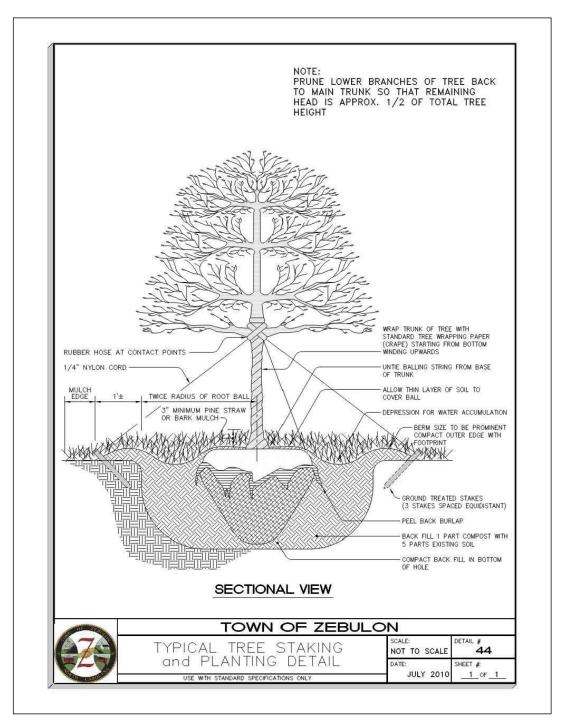


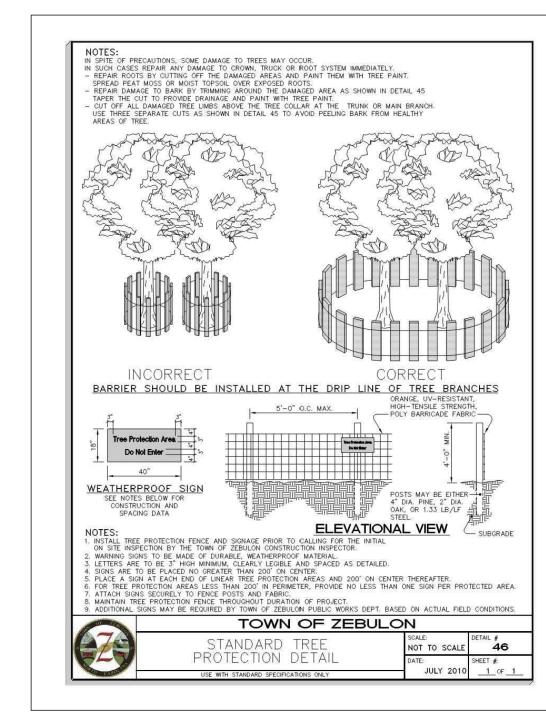
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BULON	NORTH CAROLINA		LAN	

DATE:	06/08/2023
DESIGNED BY:	SBF
DRAWN BY:	SBF
CHECKED BY:	PRM
PROJECT No.	2023018
ORAWING No.	W-4081
SCALE:	AS SHOWN







PLANTING NOTES:

- 1. ALL PLANTINGS SHALL COMPLY WITH CURRENT LOCAL ORDINANCES AND GUIDELINES.
- 2. THIS PLAN IS FOR PLANTING LOCATIONS ONLY AND ALL PLANT MATERIAL SHALL BE SPACED AND LOCATED PER SCHEDULE. HOWEVER. CONTRACTOR TO SLIGHTLY ADJUST PLANT LOCATIONS IN THE FIELD AS NECESSARY TO BE CLEAR OF DRAINAGE SWALES AND UTILITIES. IF FOUND CONDITIONS VARY FROM THIS PLAN, CONTRACTOR SHALL CONTACT OWNER AND LANDSCAPE ARCHITECT FOR RESOLUTION. FAILURE TO DO SO WILL RESULT IN CONTRACTOR'S LIABILITY TO REPLACE PLANT
- 3. REFER TO PLANTING DETAILS FOR ADDITIONAL PLANTING INFORMATION.
- 4. CONTRACTOR SHALL BE SOLELY RESPONSIBLE FOR ALL PLANT WATERING AND MAINTENANCE, INCLUDING SHRUBS AND GROUNDCOVER, AND SHALL MAINTAIN AREA IN A WEED AND DEBRIS FREE CONDITION, THROUGHOUT GUARANTEE PERIOD.
- 5. CONTRACTOR TO VERIFY PLANT LIST TOTALS WITH QUANTITIES SHOWN ON PLAN.
- 6. ALL SIZES SPECIFIED IN THE PLANT LIST ARE MINIMUM SIZES TO WHICH THE PLANTS ARE TO BE JUDGED. FAILURE TO MEET MINIMUM SIZE ON ANY PLANT WILL RESULT IN REJECTION OF THAT
- 7. PLANTING SIZE DETERMINATION: 7.1. TREES: HEIGHT SHALL BE MEASURED FROM THE CROWN OF THE ROOT BALL TO THE TOP OF MATURE GROWTH. SPREAD SHALL BE MEASURED TO THE END OF BRANCHING EQUALLY AROUND THE CROWN FROM THE CENTER OF THE TRUNK. MEASUREMENTS ARE NOT TO INCLUDE ANY TERMINAL GROWTH. SINGLE TRUNK TREES SHALL BE FREE OF "V" CROTCHES THAT COULD BE POINTS OF WEAK LIMB STRUCTURE OR DISEASE INFESTATION.
 - 7.2. ALL PLANTS SHALL BE FRESHLY DUG OR IN GROW POTS, SOUND, HEALTHY, VIGOROUS, WELL BRANCHED, FREE OF DISEASE, INSECT EGGS, AND LARVAE, AND SHALL BE WELL ROOTED.
- 8. FINISHED PLANTING BEDS SHALL BE GRADED SO AS TO NOT IMPEDE DRAINAGE AWAY FROM BUILDINGS. IF SIGNIFICANT RELOCATIONS ARE REQUIRED, CONTRACTOR SHALL CONTACT LANDSCAPE ARCHITECT FOR RESOLUTION. FAILURE TO MAKE SUCH RELOCATIONS KNOWN TO THE OWNER AND LANDSCAPE ARCHITECT WILL RESULT IN CONTRACTOR'S LIABILITY FOR PLANT MATERIALS AND STORMWATER DAMAGE.
- FIELD LOCATE AND VERIFY UNDERGROUND UTILITIES LOCATIONS PRIOR TO PLANTING. FINAL TREE LOCATIONS TO BE FIELD ADJUSTED TO AVOID CONFLICTS WITH UTILITIES, LIGHTING AND DRIVEWAY LOCATIONS WHERE POSSIBLE. CONTACT LANDSCAPE ARCHITECT FOR A COORDINATED SOLUTION FOR ANY UTILITY CONFLICTS. CONTRACTOR SHALL BE LIABLE FOR DAMAGE TO ANY AND ALL PUBLIC OR PRIVATE UTILITIES.
- 10. TREES SHALL BE STAKED WITH AN AT GRADE TREE STAKING SYSTEM. STAKING MUST BE REMOVED AS SOON AS POSSIBLE OR WITHIN ONE (1) YEAR OF PLANTING. MULCH SHALL BE APPLIED IN AN EVEN THREE INCH (3") TO TO FOUR INCH (4") LAYER AROUND THE TREE PIT IN ACCORDANCE WITH ACCEPTED PRACTICES IN THE LANDSCAPE INDUSTRY.
- 11. CONTRACTOR SHALL NOT PLACE MULCH IN CONTACT WITH THE TRUNKS OF TREES OR SHRUBS.
- 12. ALL TREE PITS, SHRUB BEDS AND PREPARED PLANTING BEDS ARE TO BE COMPLETELY EXCAVATED IN ACCORDANCE WITH THE PLANTING DETAILS.
- 13. THE ROOT CROWN SHALL BE TWO INCHES (2") TO FOUR INCHES (4") ABOVE FINISHED GRADE (AFTER SETTLING) FOR SHRUBS AND ONE QUARTER $(\frac{1}{4})$ TO ONE HALF $(\frac{1}{2})$ THE BALL DEPTH ABOVE FINISH GRADE (AFTER SETTLING) FOR TREES.
- 14. ALL SUBSTITUTIONS OF PLANT MATERIAL ARE TO BE REQUESTED IN WRITING TO THE LANDSCAPE ARCHITECT AND APPROVED IN WRITING BY THE OWNER PRIOR TO INSTALLATION. FAILURE TO OBTAIN SUBSTITUTION APPROVAL IN WRITING MAY RESULT IN LIABILITY TO THE CONTRACTOR.
- 15. DEAD PLANTS ARE TO BE REMOVED FROM THE JOB BY THE CONTRACTOR WEEKLY. CONTRACTOR SHALL MAINTAIN AN UPDATED, COMPREHENSIVE LIST OF ALL DEAD MATERIALS REMOVED AND PRESENT A COPY OF THE LIST TO THE OWNER AND THE LANDSCAPE ARCHITECT AT THE END OF EVERY MONTH DURING THE CONTRACT PERIOD.
- 16. TOPSOIL REQUIRED FOR SOIL MIXES AND SPECIAL SEEDING AREAS SHALL BE PROVIDED BY THE CONTRACTOR. CONTRACTOR MUST LOAD, HAUL, MIX, AND SPREAD ALL TOPSOIL AND OTHER SOIL ADDITIVES AS REQUIRED.
- 17. THE PROPERTY OWNER AND/OR LESSEE SHALL, UPON COMPLETION OF THE GUARANTEE PERIOD AND FINAL ACCEPTANCE OF THE LANDSCAPE MATERIALS, MAINTAIN ALL LANDSCAPE MATERIALS AND LANDSCAPE AREAS IN ACCORDANCE WITH THE APPROVED LANDSCAPE PLAN. MAINTENANCE SHALL INCLUDE WATERING, WEEDING, MOWING, FERTILIZING, TREATING PESTS, MULCHING, PRUNING, REMOVAL AND REPLACEMENT OF DEAD OR DISEASED TREES AND SHRUBS. MAINTENANCE SHALL BE PERFORMED ON A REGULAR BASIS IN ORDER TO MAINTAIN PLANT VIGOR AND STABILITY AND TO PRESENT A NEAT AND WELL-KEPT APPEARANCE AT ALL TIMES.
- 18. CONTRACTOR SHALL GUARANTEE ALL LANDSCAPE IMPROVEMENTS, INCLUDING SEEDING, AS REQUIRED BY THE SPECIFICATIONS. CONTRACTOR MUST CONTACT THE OWNER AND THE LANDSCAPE ARCHITECT AT LEAST 10 WORKING DAYS IN ADVANCE TO SCHEDULE ACCEPTANCE INSPECTION(S). CONTRACTOR MUST REPLACE ALL DEAD OR UNACCEPTABLE PLANTS DURING THE FOLLOWING RECOMMENDED PLANTING SEASON.
- 19. ALL TREES AND SHRUBS SHALL MEET THE NORMAL REQUIREMENTS FOR THE AMERICAN STANDARD FOR NURSERY STOCK, LATEST EDITION, PUBLISHED BY THE AMERICAN ASSOCIATION OF NURSERYMAN (AAN) OR AMERICANHORT, ANSI Z60.1.
- 20. MULCH SHALL BE FREE OF DEBRIS AND WOOD CHIPS. IT SHALL CONSIST OF AGED TRIPLE-SHREDDED HARDWOOD MULCH, FREE OF EXCESS TANNIC ACID OR OTHER MULCH AS SPECIFIED ON THE PLANS. SAMPLES OF MULCH SHALL BE PROVIDED FOR THE THE LANDSCAPE ARCHITECT'S APPROVAL PRIOR TO DELIVERING THE MULCH. THE OWNER RESERVES THE RIGHT TO REJECT ANY MULCH WHICH IS CONSIDERED TO BE UNSUITABLE. ALL MULCHES SHALL BE FREE OF ANY FOREIGN MATERIALS, PIECES LARGER THAN 6 INCHES, AND/OR GREEN WOOD.
- 21. ALL STRAPPING AND TOP 2/3 OF WIRE BASKET MUST BE CUT AWAY AND REMOVED FROM ROOT BALL PRIOR TO BACKFILLING PLANTING PIT. REMOVE TOP 1/3 OF THE BURLAP FROM THE ROOT BALL. REMOVE ALL SYNTHETIC MATERIALS: BURLAP, STRAPPING CORDAGE, ETC. PRIOR TO BACKFILLING ALL PLANT MATERIALS.
- 22. NO PLANTING IDENTIFIED AS REACHING A MATURE HEIGHT OF MORE THAN TWENTY FEET (20') SHALL BE PLACED WITHIN A TRANSMISSION POWER LINE RIGHT-OF-WAY OR WITHIN TEN FEET (10') OF AN OVERHEAD UTILITY LINE.
- 23. TREES WHICH OVERHANG THE PEDESTRIAN CIRCULATION ROUTES AT THE STREETS, SIDEWALKS OR WITHIN OPEN SPACE AREAS SHALL NOT EXTEND GREATER THAN FOUR INCHES INTO THE CIRCULATION ROUTE AT A HEIGHT LESS THAN 80 INCHES ABOVE THE ADJACENT GRADE. ALL TREES SHALL BE LIMBED TO PROVIDE 80 INCHES OF CLEARANCE AT WALKWAYS TO MEET A.D.A AND ANSI Z60.1 REQUIREMENTS.

- BOUNDARY AND TOPOGRAPHIC SURVEY PROVIDED BY WILLIAMS-PIERCE & ASSOCIATES, P.A. CONTRACTOR SHALL FIELD VERIFY LOCATION, SIZE, AND MATERIAL OF EXISTING SITE AND VICINITY FEATURES AND UTILITIES PRIOR TO BEGINNING DEMOLITION AND CONSTRUCTION ACTIVITIES. CONTRACTOR SHALL NOTIFY THE CIVIL ENGINEER AND LANDSCAPE ARCHITECT OF ANY DISCREPANCIES THAT ARE FOUND BETWEEN THE EXISTING FIELD CONDITIONS AND THE SITE PLANS OR CONSTRUCTION DRAWINGS, WHENEVER THEY ARE FOUND, DURING ALL
- 3. THE PRUNING OF SCREENING SHRUBS SHALL ALLOW FOR LATERAL GROWTH OF BRANCHES SO AS TO FORM A HEDGE.
- 4. ALL LANDSCAPE ISLANDS, BEDS AND LAWNS SHALL BE GRADED FOR POSITIVE DRAINAGE WITH NO LOW SPOTS ALLOWING WATER TO BE TRAPPED.
- 5. CONTRACTOR SHALL PLANT TREES AND SHRUBS 5 FEET FROM BACK OF CURB WHEN
- PLANTED PERPENDICULAR FROM PARKING SPACES.
- 6. WHEEL STOPS ARE REQUIRED IF LANDSCAPING CANNOT BE SET BACK 5 FEET.
- 7. CONTRACTOR SHALL INSTALL ALL SHRUBS IN MULCHED BEDS.
- 8. CONTRACTOR SHALL INSTALL ALL TREES IN MINIMUM 4-6' DIA. MULCHED BEDS. 9. WHERE TREES AND SHRUBS ARE LOCATED TOGETHER IN LANDSCAPE BUFFERS, THE
- CONTRACTOR SHALL MULCH THE FULL WIDTH AND LENGTH OF THE BUFFER. 10. ALL UN-MULCHED AREAS OF THE SITE SHALL BE SEEDED WITH LAWN GRASS. GRASS SEED SELECTION SHALL BE SUBMITTED TO AND APPROVED BY THE LANDSCAPE ARCHITECT, PRIOR TO PURCHASE AND INSTALLATION.







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06/08/2023 DESIGNED BY: SBF DRAWN BY: PRM, JSJ CHECKED BY: PROJECT No. 2023018 W-4081 DRAWING No.

AS SHOWN SCALE: