

ARENDELL AVE

SITE PLAN SET

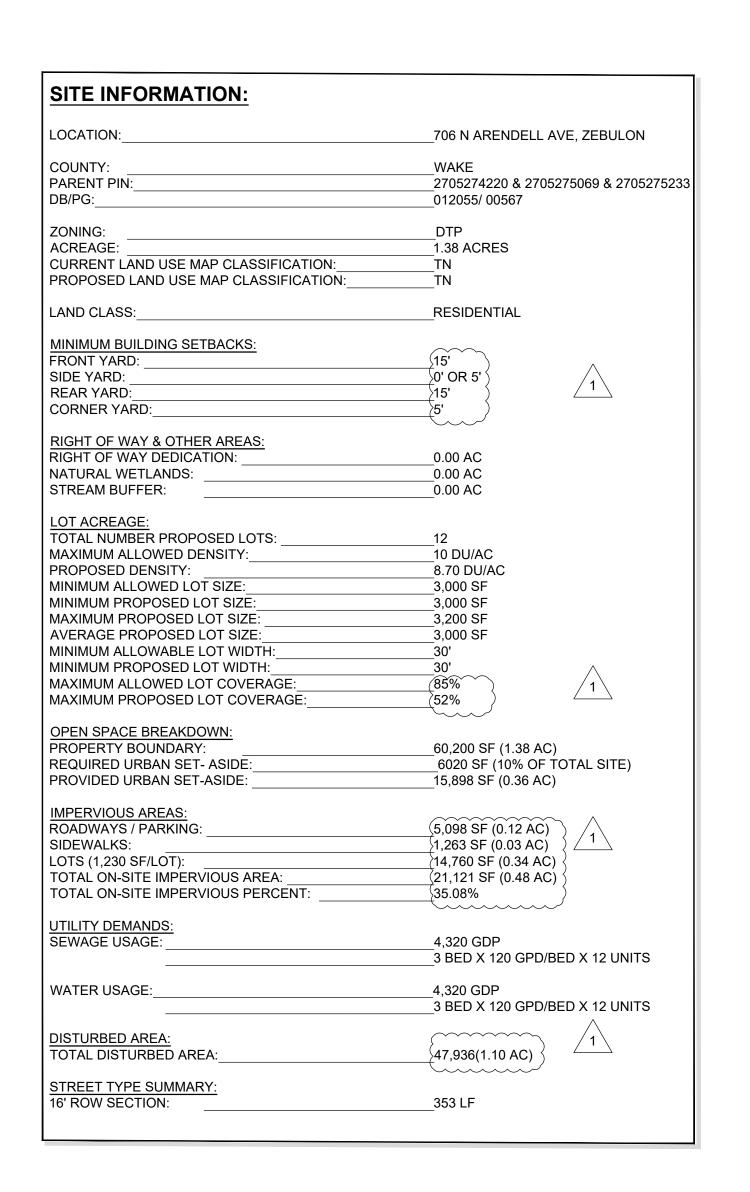

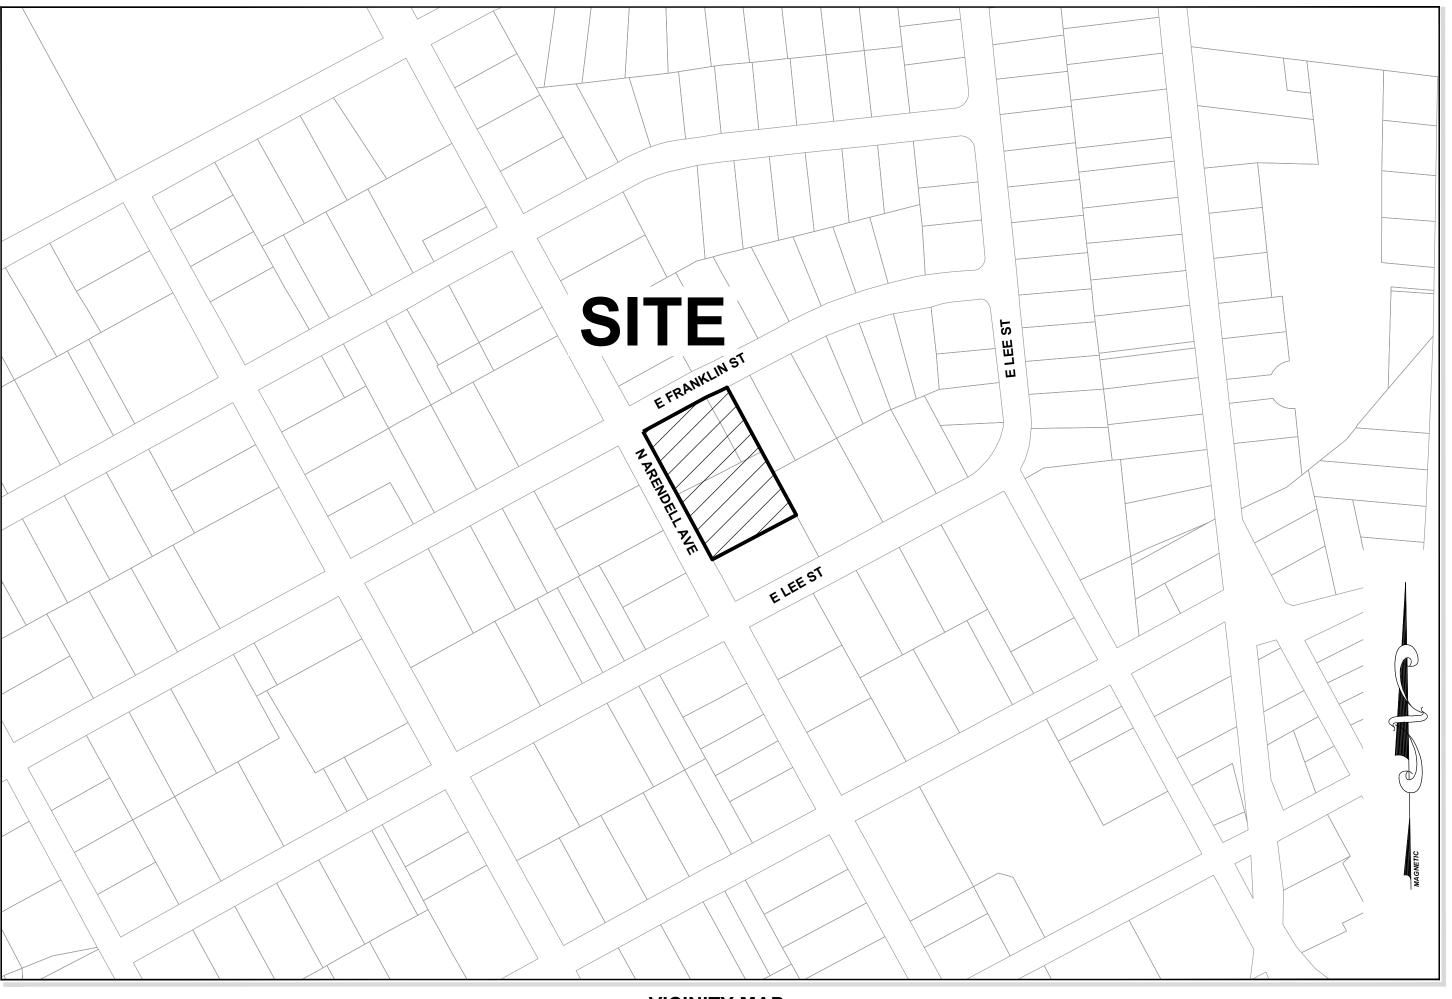

VICINITY MAP

1" = 200'

XX-XX-2020

XX-XX-2020

W-XXXX

S-XXXX

_SEC-XXXXXXX-XXXX

_E51-XXX-XXXX (DATE: XX-XX-XXXX)

PUBLIC UTILITY IMPROVEMENTS:

SHEET INDEX

C-1.0 EXISTING CONDITIONS PLAN

C-0.0 COVER SHEET

C-2.0 SITE PLAN

C-3.0 UTILITY PLAN

C-4.0 GRADING PLAN

C-5.0 STORMWATER PLAN

C-7.0 LANDSCAPING PLAN

D-2.0 WATER DETAILS D-2.1 | SITE DETAILS

D-2.2 | SITE DETAILS

D-1.0 BUILDING ELEVATIONS

C-6.0 EROSION CONTROL PLAN

WATER MAIN: 205 SF SEWER MAIN: 76 SF WATER STUBS: 5 SEWER STUBS: 1

PERMIT INFORMATION:

PERMITTING AUTHORITY, PERMIT IDENTIFIERS, & EFFECTIVE DATES)

OWN OF ZEBULON PLANNING AND ZONING:

EFFECTIVE DATE OF ZONING APPROVAL: EFFECTIVE DATE OF MASTER PLAN APPROVAL:

WAKE COUNTY ENVIRONMENTAL: -LAND DISTURBANCE PERMIT:

-STORMWATER PERMIT: SWF-XXXXXX-XXXX

ICDWR/CITY OF ZEBULON PUBLIC UTILITIES: WATER EXTENSION PERMIT -SEWER EXTENSION PERMIT:_

NC DEPT. OF TRANSPORTATION: DRIVEWAY PERMIT:_

D51-XXX-XXXX (DATE: XX-XX-XXXX) 2 PARTY ENCROACHMENT AGMT: E51-XXX-XXXX (DATE: XX-XX-XXXX)

3 PARTY ENCROACHMENT AGMT:_

J.S. ARMY CORPS OF ENGINEERS: NOT REQUIRED

IC DIVISION OF WATER QUALITY:

BUFFER IMPACT AUTHORIZATION

IMPACT PERMIT:

NOT REQUIRED

SURVEYOR:

TAYLOR LAND CONSULTANTS 5448 APEX PEAKWAY APEX, NC 27502 919-801-1104 (O) 919-337-7998 (M) CONTACT: JEREMY TAYLOR, PLS jeremy@taylorlc.com

CIVIL ENGINEERING:

STRONG ROCK ENGINEERING GROUP, PLLC PO BOX 55992 RALEIGH, NC 27624 COMPANY LICENSE #: P-2166 CONTACT: RHONDA BREWINGTON, PE 910-527-9209 (P) rhonda@strongrockgroup.com

SITE PERMITTING APPROVAL:

WATER AND SEWER PERMITS (IF APPLICABLE)

THE TOWN OF ZEBUL CONSENTS TO THE CONNECTION AND EXTENSION OF THE CITY'S PUBLIC SEWER SYSTEM AS SHOWN ON THIS PLAN. THE MATERIAL AND CONSTRUCTION METHODS USED FOR THIS PROJECT SHALL CONFORM TO THE STANDARDS AND SPECIFICATIONS OF THE CITY'S PUBLIC UTILITIES HANDBOOK. TOWN OF ZEBUL PUBLIC UTILITIES DEPARTMENT PERMIT #

TOWN OF ZEBUL CONSENTS TO THE CONNECTION AND EXTENSION OF THE CITY'S PUBLIC WATER SYSTEM AS SHOWN ON THIS PLAN. THE MATERIAL AND CONSTRUCTION METHODS USED FOR THIS PROJECT SHALL CONFORM TO THE STANDARDS AND SPECIFICATIONS OF THE CITY'S PUBLIC UTILITIES HANDBOOK.

TOWN OF ZEBUL PUBLIC. UTILITIES DEPARTMENT PERMIT #_

TOWN OF ZEBUL - PLANS AUTHORIZED FOR CONSTRUCTION

ELECTRONIC APPROVAL: THIS APPROVAL IS BEING ISSUED ELECTRONICALLY. THIS APPROVAL IS VALID ONLY UPON THE SIGNATURE OF A TOWN OF ZEBUL REVIEW OFFICER BELOW. THE CITY WILL RETAIN A COPY OF THE APPROVED PLANS. ANY WORK AUTHORIZED BY THIS APPROVAL MUST PROCEED IN ACCORDANCE WITH THE PLANS KEPT ON FILE WITH THE CITY. THIS ELECTRONIC APPROVAL MAY NOT BE EDITED ONCE ISSUED. ANY MODIFICATION TO THIS APPROVAL ONCE ISSUED WILL INVALIDATE THIS APPROVAL.

TOWN OF ZEBUL DEVELOPMENT APPROVAL

TOWN OF ZEBUL WATER REVIEW OFFICER





SHE


OVER


BULON-ARENDELL WAKE COUNTY, NORTH CAROLII

DRAWING SHEET


C-0.0



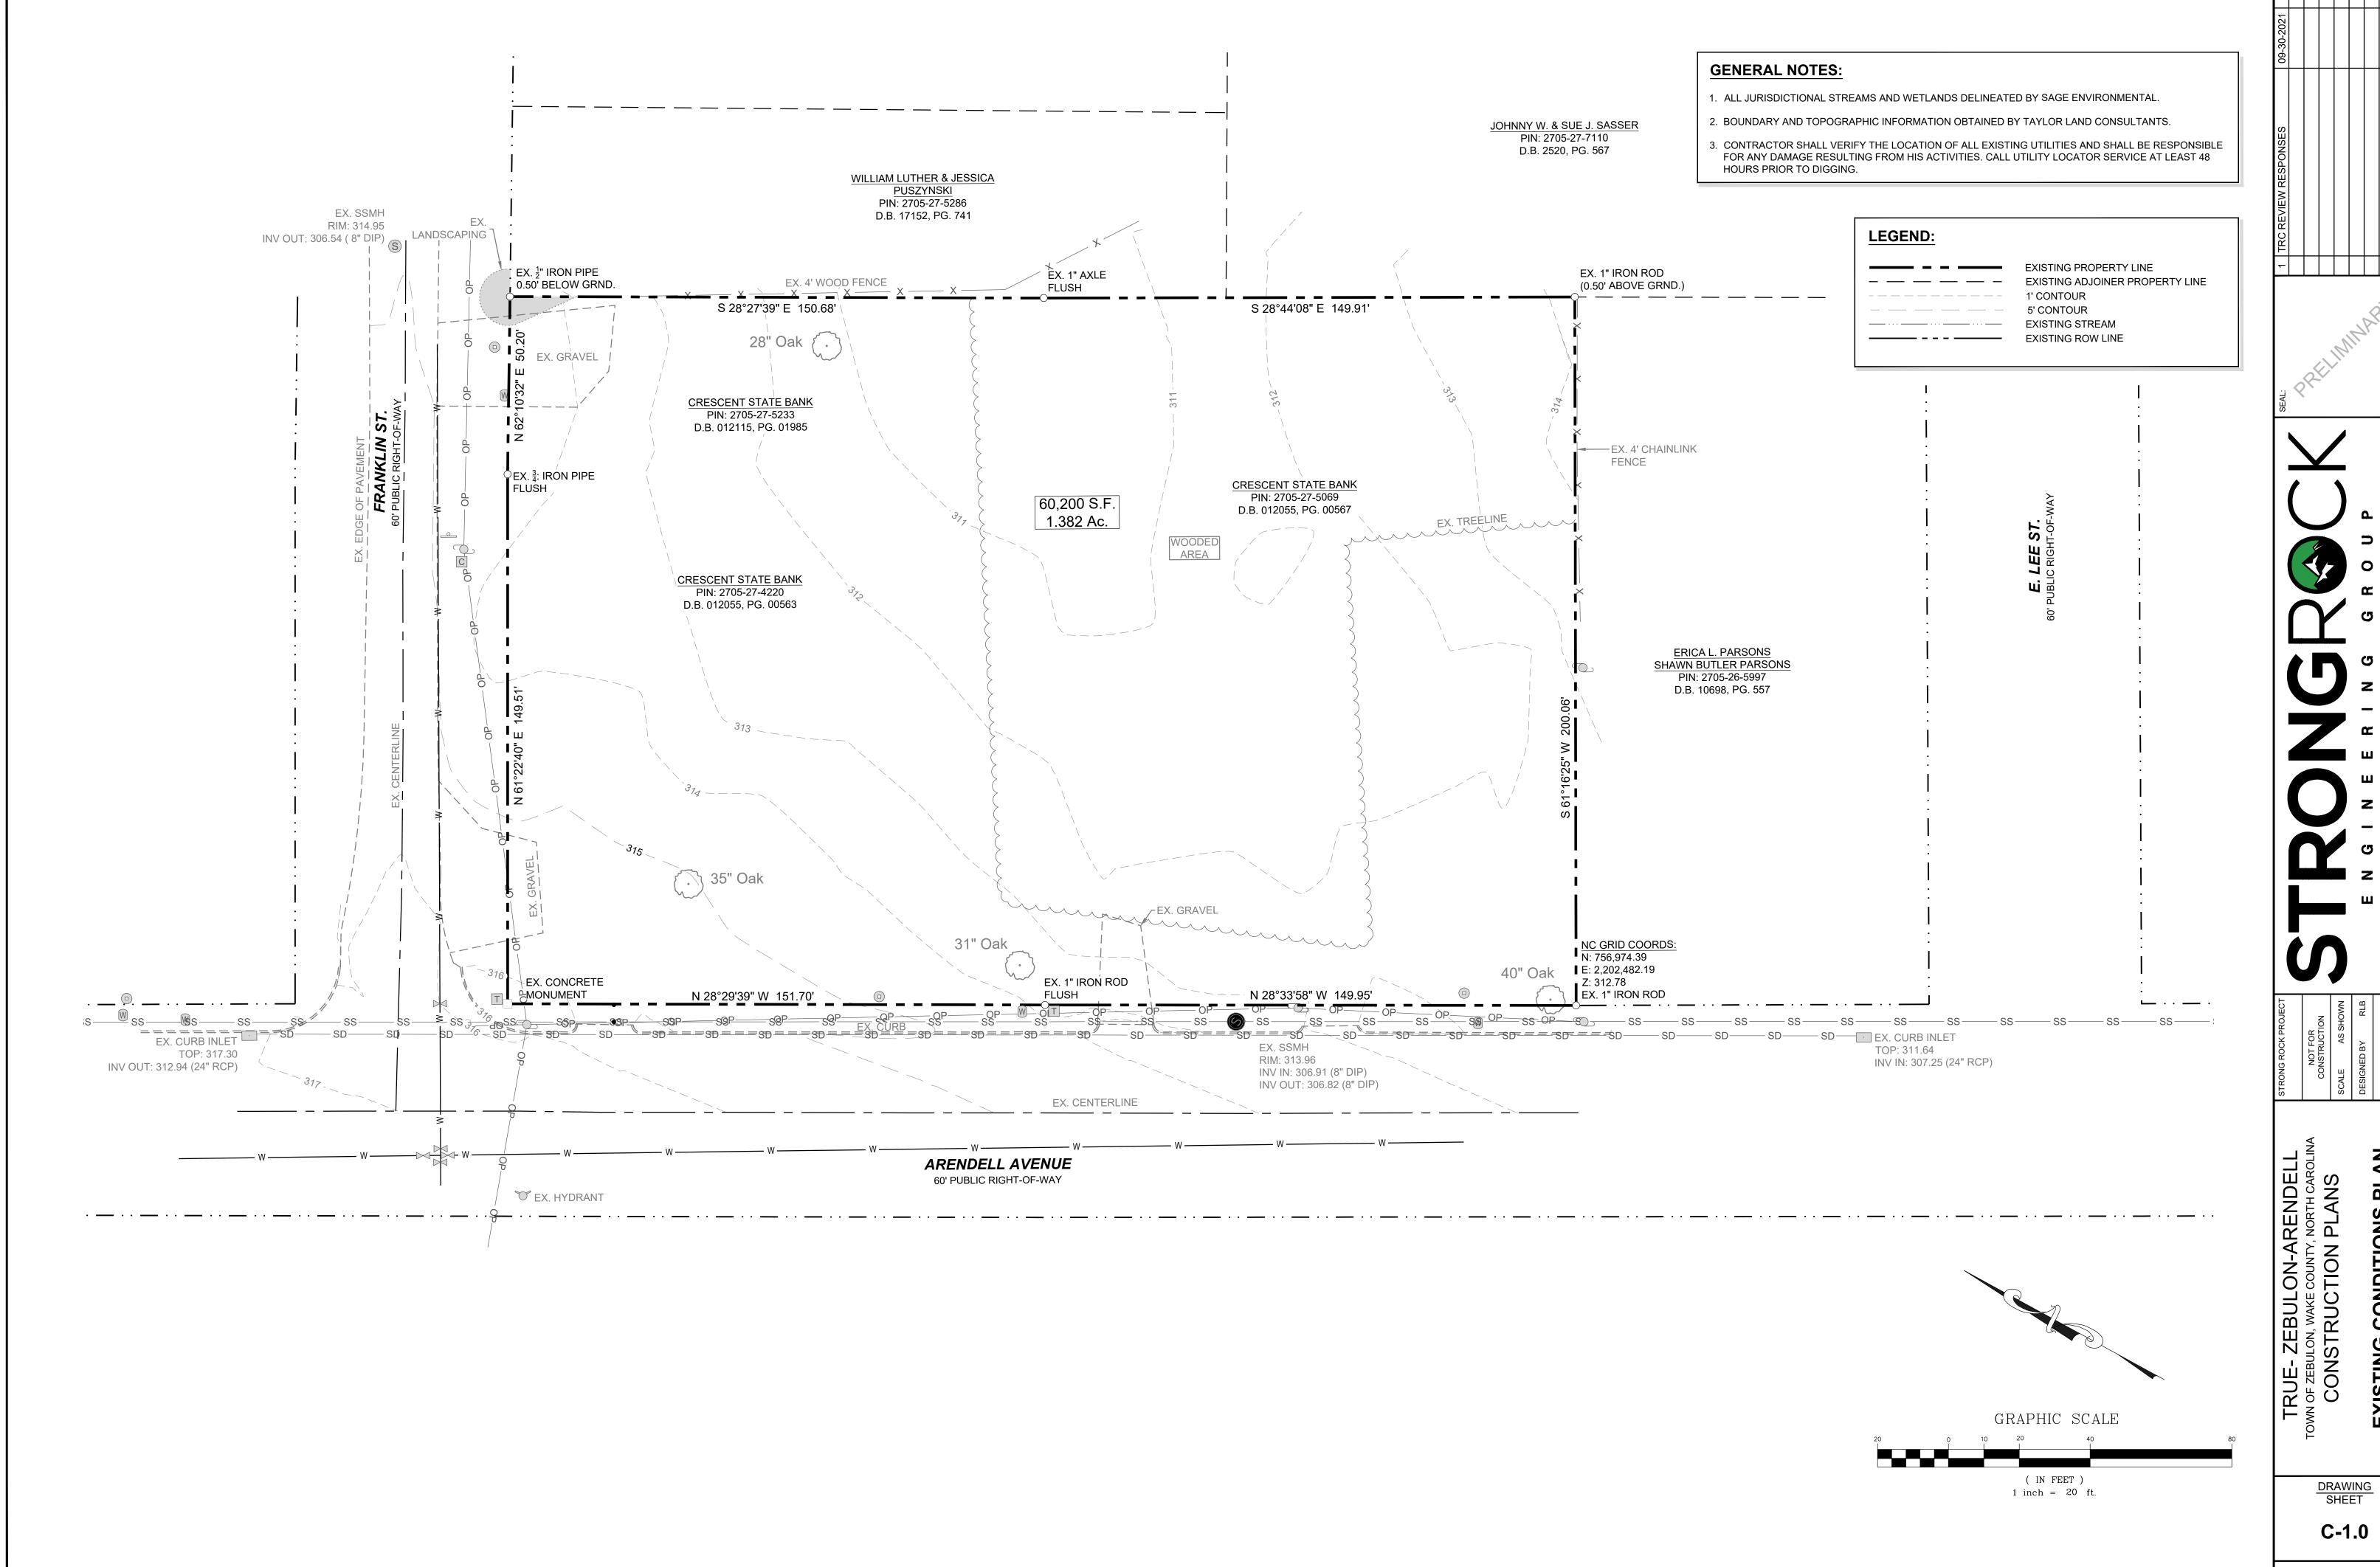

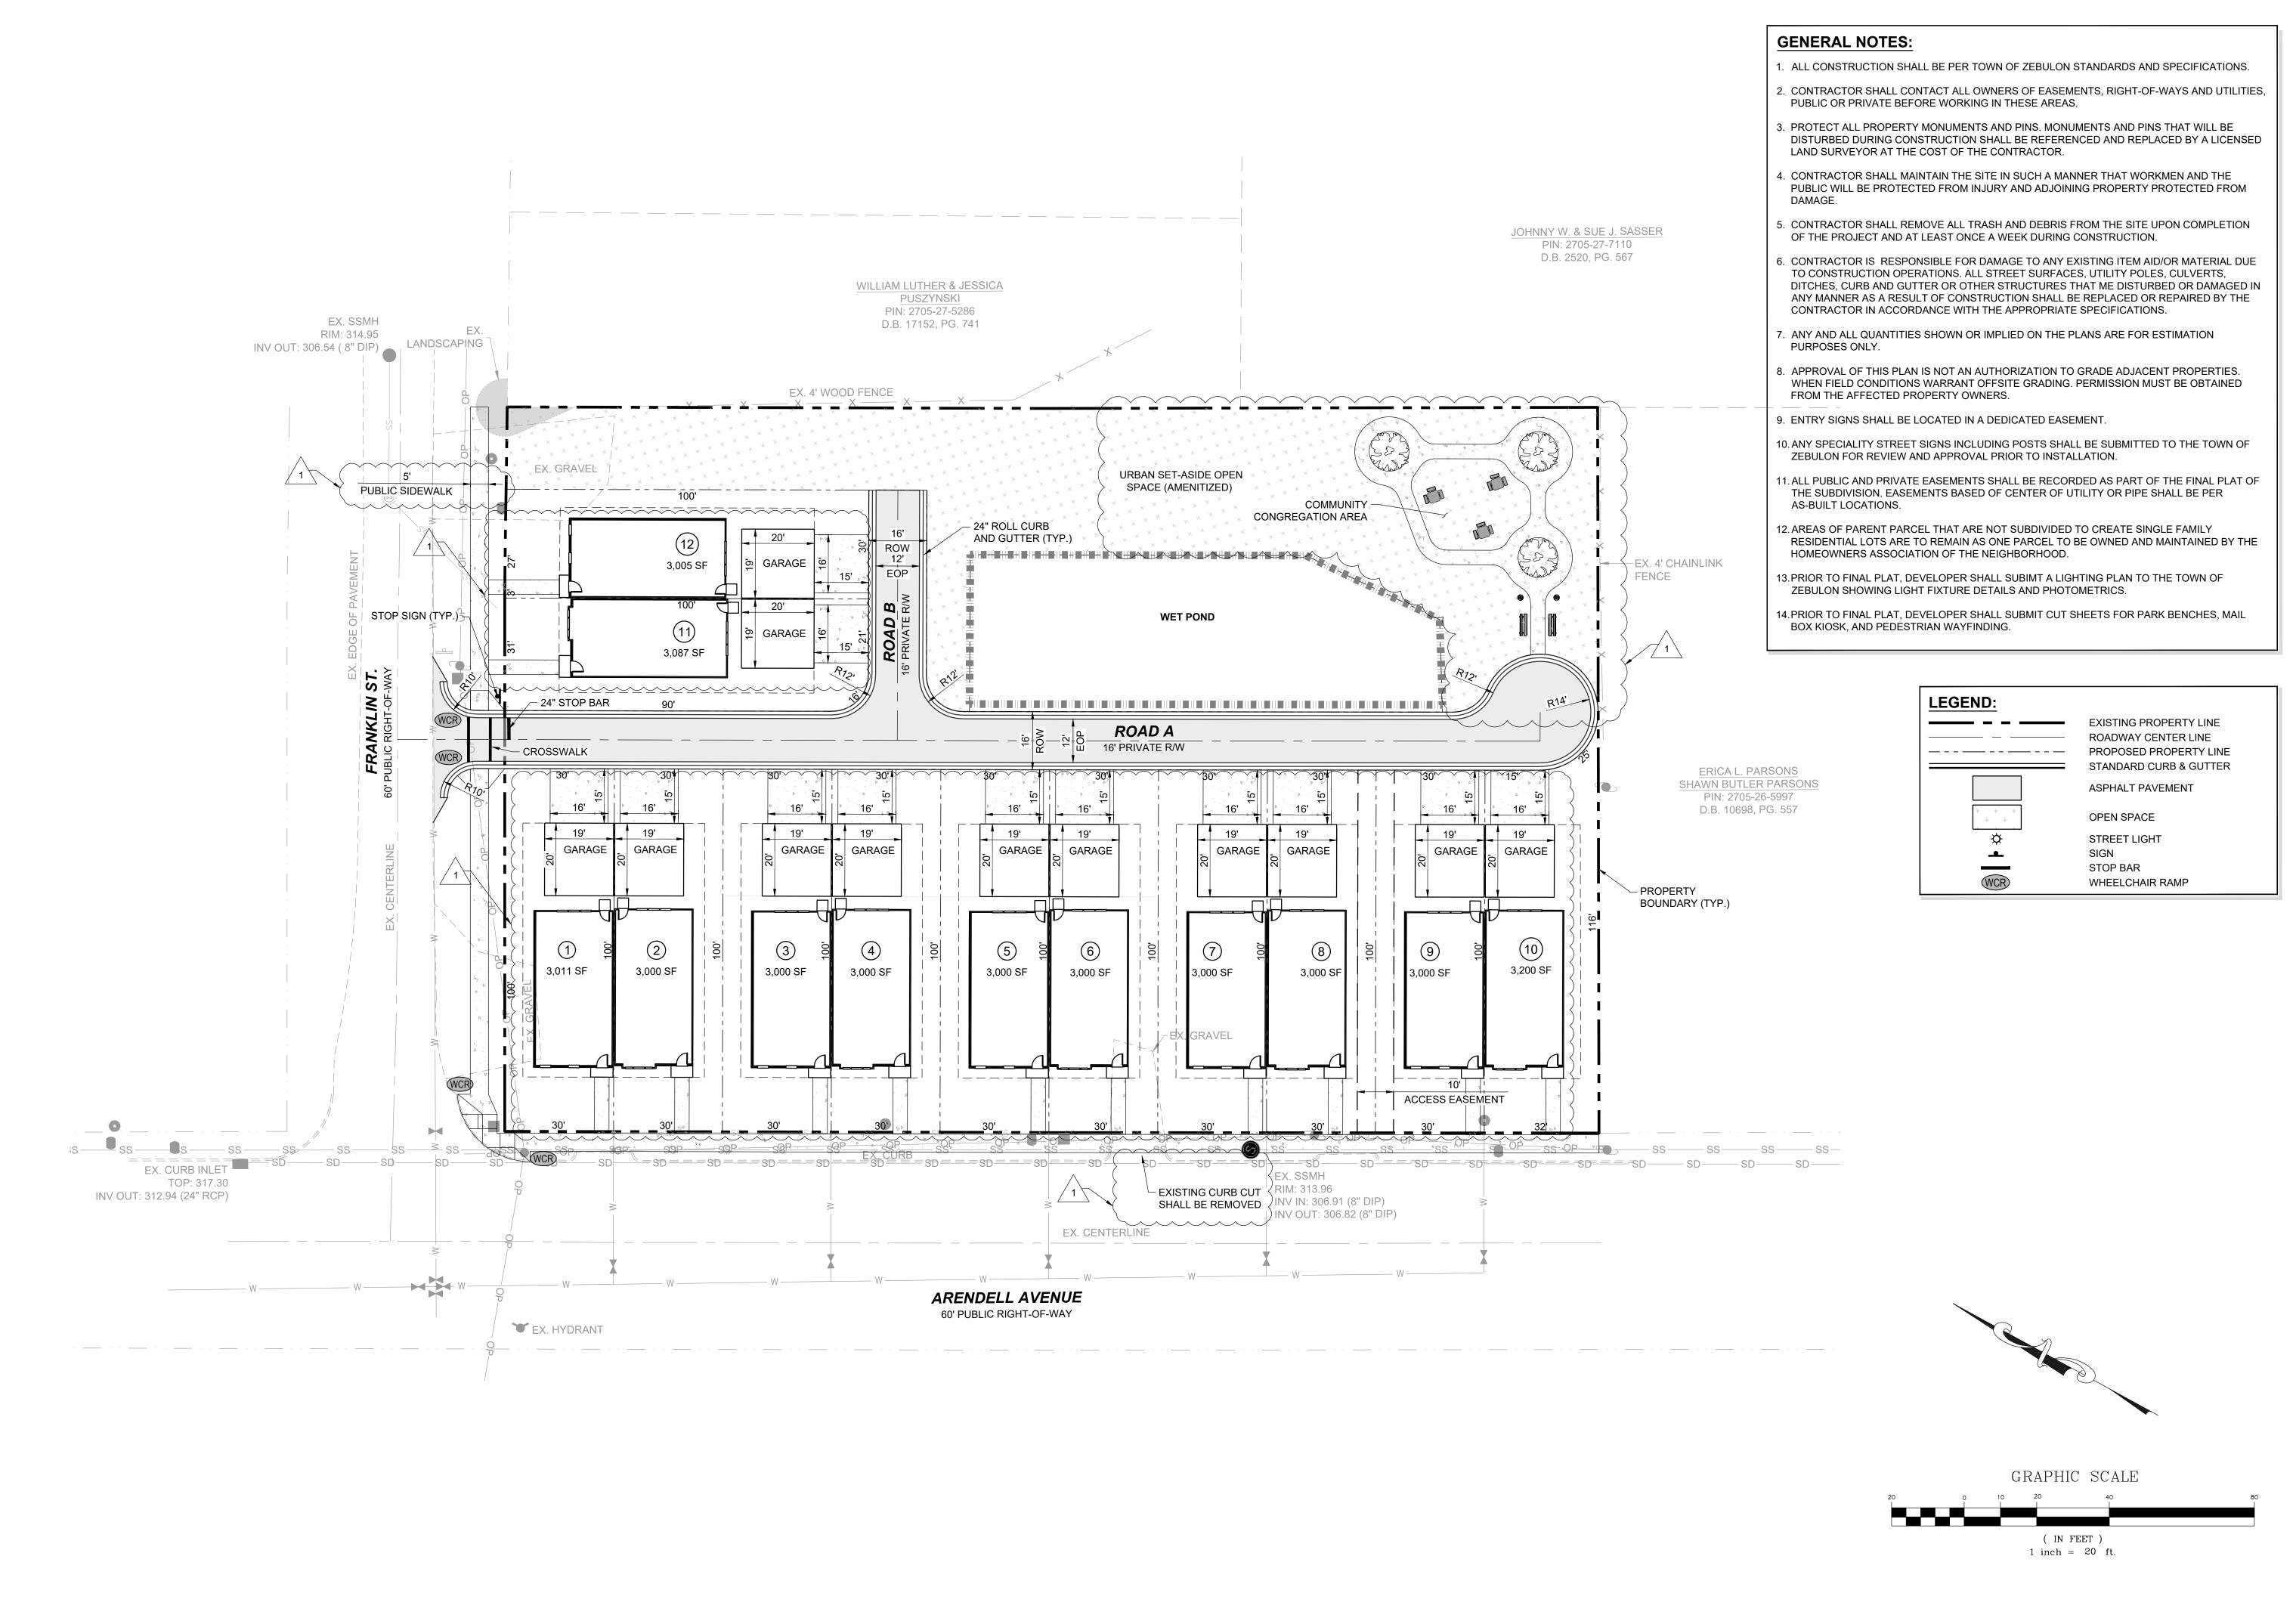

DRAWING SHEET

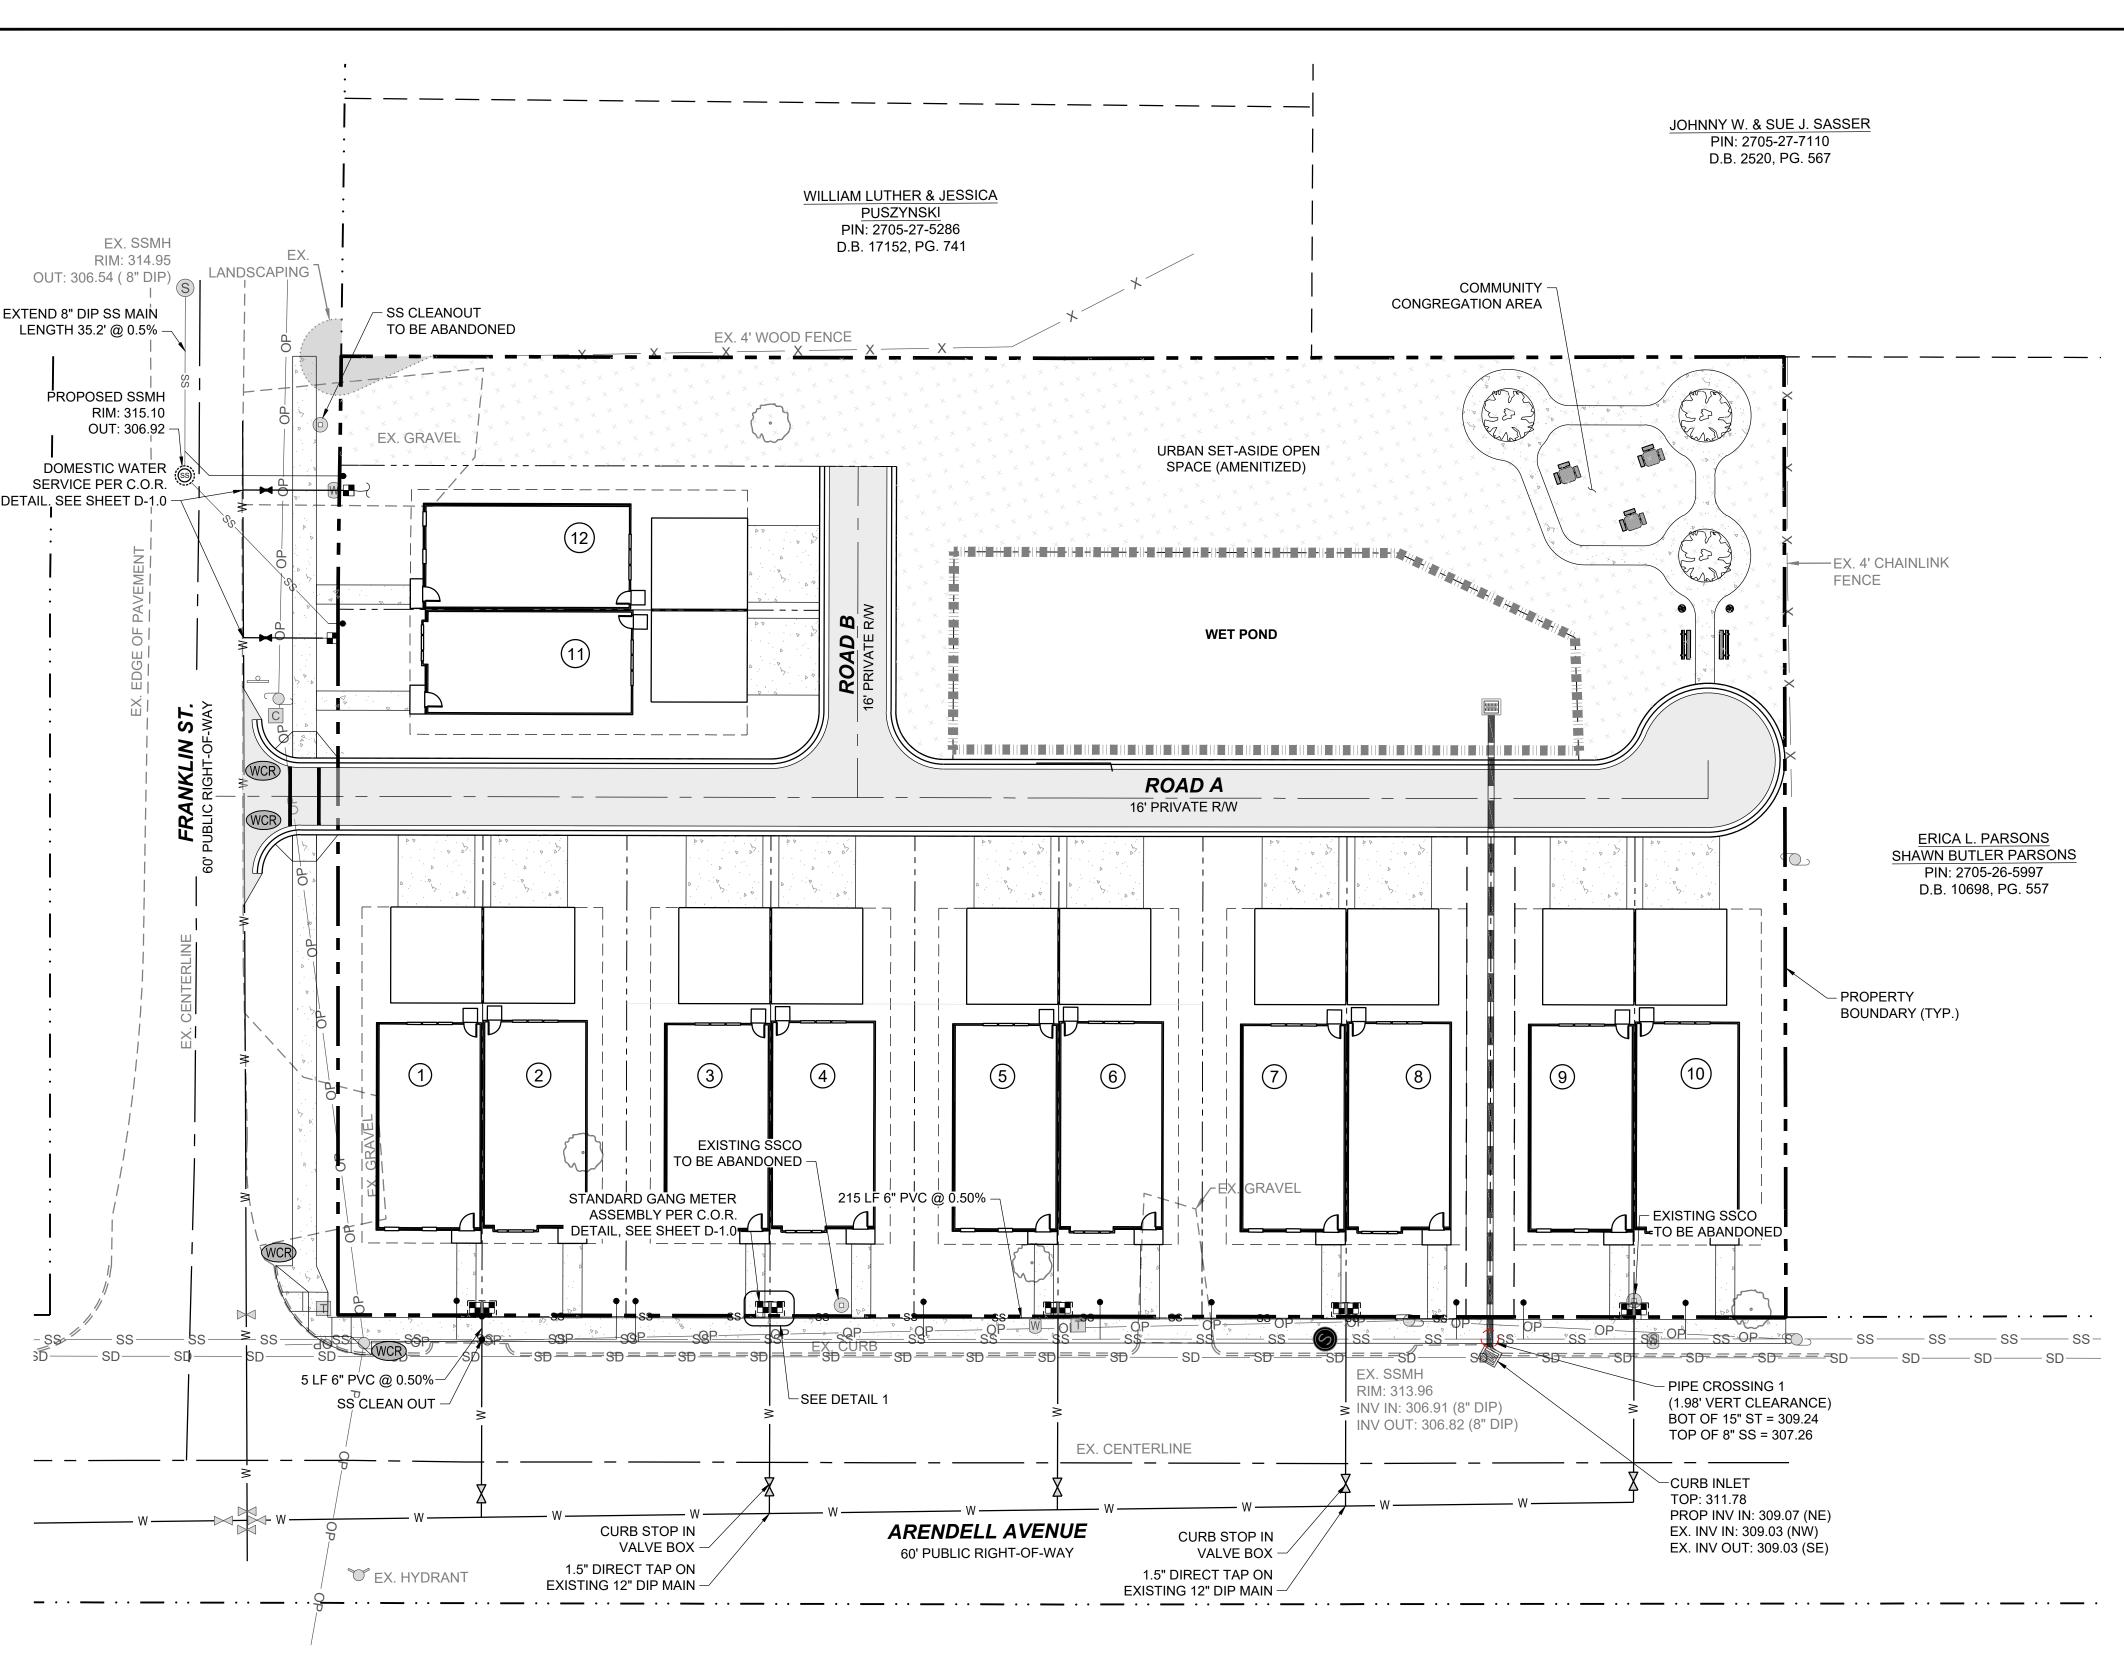

SITE PERMITTING APPROVAL:

WATER AND SEWER PERMITS (IF APPLICABLE)

THE CITY OF RALEIGH CONSENTS TO THE CONNECTION AND EXTENSION OF THE CITY'S PUBLIC SEWER SYSTEM AS SHOWN ON THIS PLAN. THE MATERIAL AND CONSTRUCTION METHODS USED FOR THIS PROJECT SHALL CONFORM TO THE STANDARDS AND SPECIFICATIONS OF THE CITY'S PUBLIC UTILITIES HANDBOOK.

CITY OF RALEIGH PUBLIC UTILITIES DEPARTMENT PERMIT #

THE CITY OF RALEIGH CONSENTS TO THE CONNECTION AND EXTENSION OF THE CITY'S PUBLIC WATER SYSTEM AS SHOWN ON THIS PLAN. THE MATERIAL AND CONSTRUCTION METHODS USED FOR THIS PROJECT SHALL CONFORM TO THE STANDARDS AND SPECIFICATIONS OF THE CITY'S PUBLIC UTILITIES HANDBOOK. CITY OF RALEIGH PUBLIC.

UTILITIES DEPARTMENT PERMIT #

THE CITY OF RALEIGH CONSENTS TO THE CONNECTION TO ITS PUBLIC SEWER SYSTEM AND EXTENSION OF THE PRIVATE SEWER COLLECTION SYSTEM AS SHOWN ON THIS PLAN. THE MATERIAL AND CONSTRUCTIONS METHODS USED FOR THIS PROJECT SHALL CONFORM TO THE STANDARDS AND SPECIFICATIONS OF THE CITY'S PUBLIC UTILITIES HANDBOOK.

CITY OF RALEIGH PUBLIC UTILITIES DEPARTMENT PERMIT #

NOTE:

WHERE PROPOSED SS PASSES OVER WATER AND STORM, SS MUST BE DUCTILE IRON WITH CONCRETE COLLAR, REFER TO DETAIL S-49.

MASTER PLAN BOUNDARY ADJOINER PROPERTY LINE EXISTING WATERLINE **EXISTING SANITARY SEWER** PROPOSED WATERLINE PROPOSED SANITARY SEWER PROPOSED LOT LINE PROPOSED ROLL CURB AND GUTTER EXISTING FIRE HYDRANT EXISTING WATER VALVE EXISTING UTILITY POLE **EXISTING TELEPHONE PEDEST** PROPOSED GATE VALVE (GV) PROPOSED TEE PROPOSED CLEANOUT

LEGEND:

UTILITY NOTES:

- ALL MATERIALS & CONSTRUCTION METHODS SHALL BE IN ACCORDANCE WITH CITY OF ZEBULON DESIGN STANDARDS, DETAILS & SPECIFICATIONS (REFERENCE: CORPUD HANDBOOK, CURRENT EDITION)
- 2. UTILITY SEPARATION REQUIREMENTS (TAKEN FROM CORPUD HANDBOOK, 2014 EDITION, SEWER DESIGN, MATERIAL, & CONSTRUCTION STANDARDS, SECTION 1. a. 15;):
 - A. A DISTANCE OF 100' SHALL BE MAINTAINED BETWEEN SANITARY SEWER & ANY PRIVATE OR PUBLIC WATER SUPPLY SOURCE SUCH AS AN IMPOUNDED RESERVOIR USED AS A SOURCE OF DRINKING WATER. IF ADEQUATE LATERAL SEPARATION CANNOT BE ACHIEVED, FERROUS SANITARY SEWER PIPE SHALL BE SPECIFIED & INSTALLED TO WATERLINE SPECIFICATIONS. HOWEVER, THE MINIMUM SEPARATION SHALL NOT BE LESS THAN 25' FROM A PRIVATE WELL OR 50' FROM A PUBLIC WELL.
 - B. WHEN INSTALLING WATER &/OR SEWER MAINS, THE HORIZONTAL SEPARATION BETWEEN UTILITIES SHALL BE 10'. IF THIS SEPARATION CANNOT BE MAINTAINED DUE TO EXISTING CONDITIONS, THE VARIATION ALLOWED IS THE WATER MAIN IN A SEPARATE TRENCH WITH THE ELEVATION OF THE WATER MAIN AT LEAST 18" ABOVE THE TOP OF THE SEWER & MUST BE APPROVED BY THE PUBLIC UTILITIES DIRECTOR. ALL DISTANCES ARE MEASURED FROM OUTSIDE
 - DIAMETER TO OUTSIDE DIAMETER. C. WHERE IT IS IMPOSSIBLE TO OBTAIN PROPER SEPARATION, OR ANYTIME A SANITARY SEWER PASSES OVER A WATERMAIN, DIP MATERIALS OR STEEL ENCASEMENT EXTENDED 10' ON EACH SIDE OF CROSSING MUST BE
 - SPECIFIED & INSTALLED TO WATERLINE SPECIFICATIONS. D. 5.0' MINIMUM HORIZONTAL SEPARATION IS REQUIRED BETWEEN ALL SANITARY SEWER & STORM SEWER FACILITIES, UNLESS DIP MATERIAL IS SPECIFIED FOR SANITARY SEWER.
 - E. MAINTAIN 18" MIN. VERTICAL SEPARATION AT ALL WATERMAIN & RCP STORM DRAIN CROSSINGS; MAINTAIN 24" MIN. VERTICAL SEPARATION AT ALL SANITARY SEWER & RCP STORM DRAIN CROSSINGS. WHERE ADEQUATE SEPARATIONS CANNOT BE ACHIEVED, SPECIFY DIP MATERIALS & A CONCRETE CRADLE HAVING 6" MIN. CLEARANCE (PER CORPUD DETAILS W-41 & S-49).
 - F. ALL OTHER UNDERGROUND UTILITIES SHALL CROSS WATER & SEWER FACILITIES WITH 18" MIN. VERTICAL SEPARATION REQUIRED.
- 3. ANY NECESSARY FIELD REVISIONS ARE SUBJECT TO REVIEW & APPROVAL OF AN AMENDED PLAN &/OR PROFILE BY THE CITY OF ZEBULON PUBLIC UTILITIES DEPARTMENT PRIOR TO CONSTRUCTION.
- I. CONTRACTOR SHALL MAINTAIN CONTINUOUS WATER & SEWER SERVICE TO EXISTING RESIDENCES & BUSINESSES THROUGHOUT CONSTRUCTION OF PROJECT. ANY NECESSARY SERVICE INTERRUPTIONS SHALL BE PRECEDED BY A 24 HOUR ADVANCE NOTICE TO THE CITY OF ZEBULON PUBLIC UTILITIES DEPARTMENT.
- 5. 3.0' MINIMUM COVER IS REQUIRED ON ALL WATER MAINS & SEWER FORCEMAINS. 4.0' MINIMUM COVER IS REQUIRED ON ALL REUSE MAINS.
- 6. IT IS THE DEVELOPER'S RESPONSIBILITY TO ABANDON OR REMOVE EXISTING WATER & SEWER SERVICES NOT BEING USED IN REDEVELOPMENT OF A SITE UNLESS OTHERWISE DIRECTED BY THE CITY OF ZEBULON PUBLIC UTILITIES DEPARTMENT. THIS INCLUDES ABANDONING TAP AT MAIN & REMOVAL OF SERVICE FROM ROW OR EASEMENT PER CORPUD HANDBOOK PROCEDURE.
- INSTALL 3 4" COPPER* WATER SERVICES WITH METERS LOCATED AT ROW OR WITHIN A 2'X2' WATERLINE EASEMENT IMMEDIATELY ADJACENT. NOTE: IT IS THE APPLICANT'S RESPONSIBILITY TO PROPERLY SIZE THE WATER SERVICE FOR EACH CONNECTION TO PROVIDE ADEQUATE FLOW & PRESSURE.
- 8. INSTALL 4" PVC* SEWER SERVICES @ 1.0% MINIMUM GRADE WITH CLEANOUTS LOCATED AT ROW OR EASEMENT LINE & SPACED EVERY 75 LINEAR FEET MAXIMUM.
-). PRESSURE REDUCING VALVES ARE REQUIRED ON ALL WATER SERVICES EXCEEDING 80 PSI; BACKWATER VALVES ARE REQUIRED ON ALL SANITARY SEWER SERVICES HAVING BUILDING DRAINS LOWER THAN 1.0' ABOVE THE NEXT UPSTREAM MANHOLE.
- 10. A 3-PARTY ENCROACHMENT AGREEMENT BETWEEN THE NCDOT, THE CITY OF ZEBULON PUBLIC UTILITIES, AND THE DEVELOPER MAY BE NEEDED FOR WATER AND SEWER SERVICE TAPS WITHIN THE NCDOT MAINTAINED RIGHT OF WAY.

CROSS-CONNECTION CONTROL PROTECTION DEVICES ARE REQUIRED BASED ON DEGREE OF HEALTH HAZARD INVOLVED AS LISTED IN APPENDIX-B OF THE RULES GOVERNING PUBLIC WATER SYSTEMS IN NORTH CAROLINA. THESE GUIDELINES ARE THE MINIMUM REQUIREMENTS. THE DEVICES SHALL MEET AMERICAN SOCIETY OF SANITARY ENGINEERING (ASSE) STANDARDS OR BE ON THE UNIVERSITY OF SOUTHERN CALIFORNIA APPROVAL LIST. THE DEVICES SHALL BE INSTALLED AND TESTED (BOTH INITIAL AND PERIODIC TESTING THEREAFTER) IN ACCORDANCE WITH THE MANUFACTURER'S RECOMMENDATIONS OR THE LOCAL CROSS-CONNECTION CONTROL PROGRAM, WHICHEVER IS MORE STRINGENT. CONTACT JOANIE HARTLEY AT (919) 996-5923 OR JOANIE.HARTLEY@ RALEIGHNC.GOV FOR MORE INFORMATION.

- 11.PROPOSED PRIVATE UTILITIES (POWER, TELEPHONE, NATURAL GAS, CABLE TV) ARE NOT SHOWN ON THIS PLAN. THE DEVELOPER SHALL COORDINATE THE INSTALLATION OF THOSE UTILITIES WHEN INSTALLING PUBLIC UTILITIES.
- 12. CONTRACTOR SHALL LOCATE ALL UNDERGROUND UTILITIES PRIOR TO ANY LAND DISTURBANCE ACTIVITIES. IF ANY EXISTING UTILITIES ARE LOCATED THAT CAUSE A CONFLICT WITH PROPOSED UTILITIES, CONTRACTOR SHALL IMMEDIATELY NOTIFY THE CIVIL ENGINEER OF RECORD IN WRITING. IF SUCH A SCENARIO ARISES, THE PROPOSED UTILITY IN QUESTION SHALL NOT BE INSTALLED UNTIL AN ACCEPTABLE SOLUTION IS PREPARED AND APPROVED BY THE AUTHORITY HAVING JURISDICTION.
- 13. CONTRACTOR SHALL ADJUST ALL CLEANOUTS, VALVE BOXES, MANHOLES, ETC. TO THE FINISHED GRADES ESTABLISHED
- 14. ALL UNDERGROUND ELECTRICAL CONDUITS SHALL HAVE A MINIMUM COVER OF 36"; GAS AND COMMUNICATION LINES SHALL HAVE DEPTH AND SPACING AS SPECIFIED BY SERVICE COMPANY.
- 15. MAXIMUM SPACING FOR SANITARY SEWER CLEANOUTS IS 75 FEET. ALL CLEANOUTS LOCATED IN DRIVE AISLES AND/OR PARKING AREAS SHALL TO BE TRAFFIC RATED.
- 16. INVERT AT CLEANOUT IS INVERT ELEVATION AT THE CONNECTION OF THE HORIZONTAL BEND.
- 17. A 3-FOOT CLEAR SPACE SHALL BE MAINTAINED AROUND THE CIRCUMFERENCE OF FIRE HYDRANTS.
- 18. CONTRACTOR SHALL PROVIDE PROPER NOTIFICATION TO AUTHORITIES HAVING JURISDICTION AS SPECIFIED IN AGENCY PERMIT CONDITIONS. AS A COURTESY, CIVIL ENGINEER OF RECORD REQUESTS NOTIFICATION.

GRAPHIC SCALE

(IN FEET)


1 inch = 20 ft.


GRAPHIC SCALE

(IN FEET)

1 inch = 5 ft.


- 19. THRUST RESTRAINT SHALL BE IN ACCORDANCE WITH CITY OF ZEBULON STANDARD SPECIFICATIONS.
- 20. WATER LINE TESTING AND STERILIZATION SHALL BE IN ACCORDANCE WITH CITY OF ZEBULON STANDARD SPECIFICATIONS.
- 21.ALL NEW MANHOLES SHALL BE ECCENTRIC UNLESS OTHERWISE NOTED.
- 22.ALL WATER AND SEWER SERVICE CONNECTIONS SHALL BE INSTALLED BY A LICENSED PLUMBER.

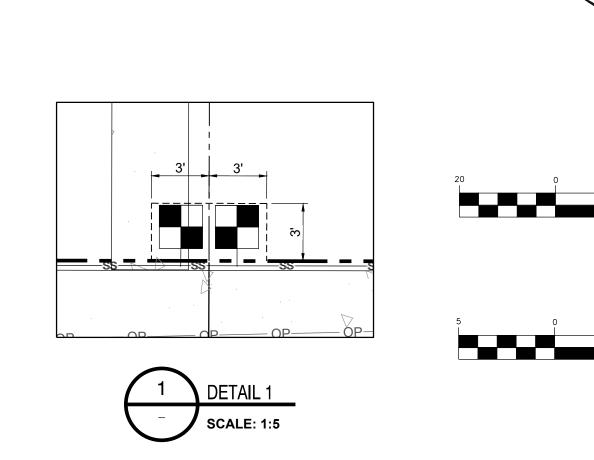


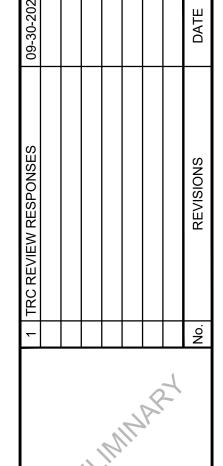


ENDI ORTH C/


DRAWING SHEET

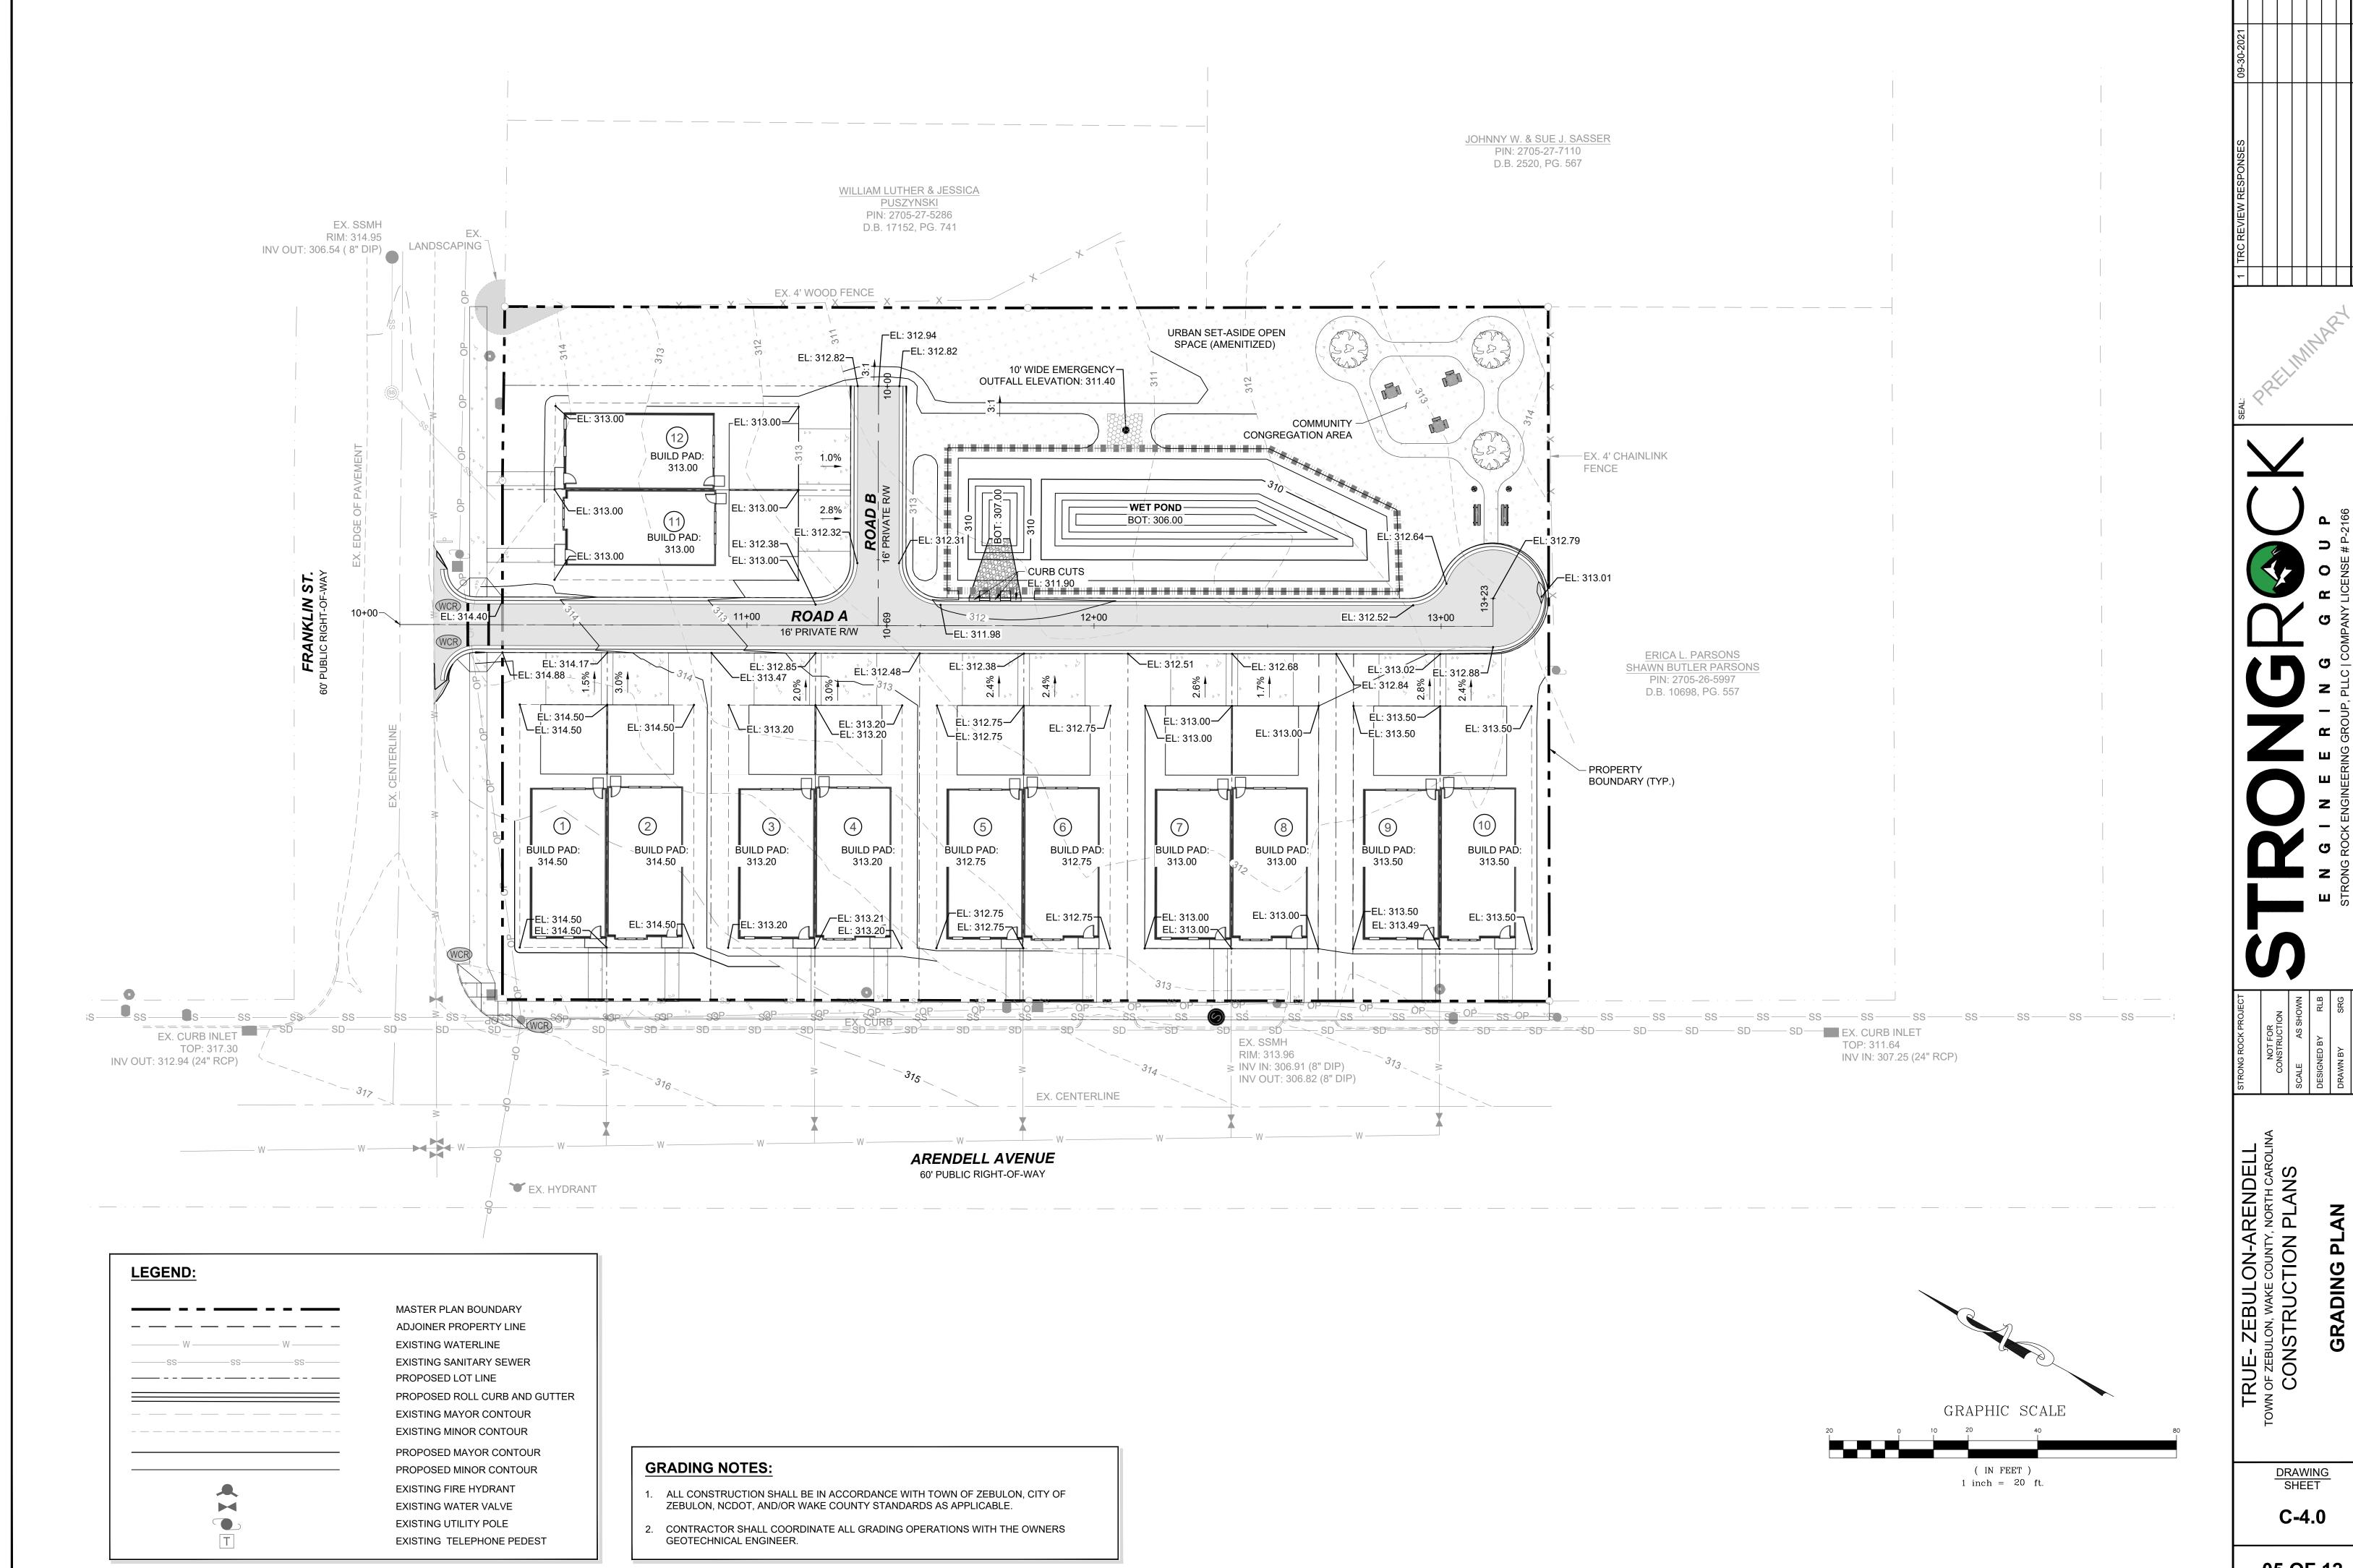


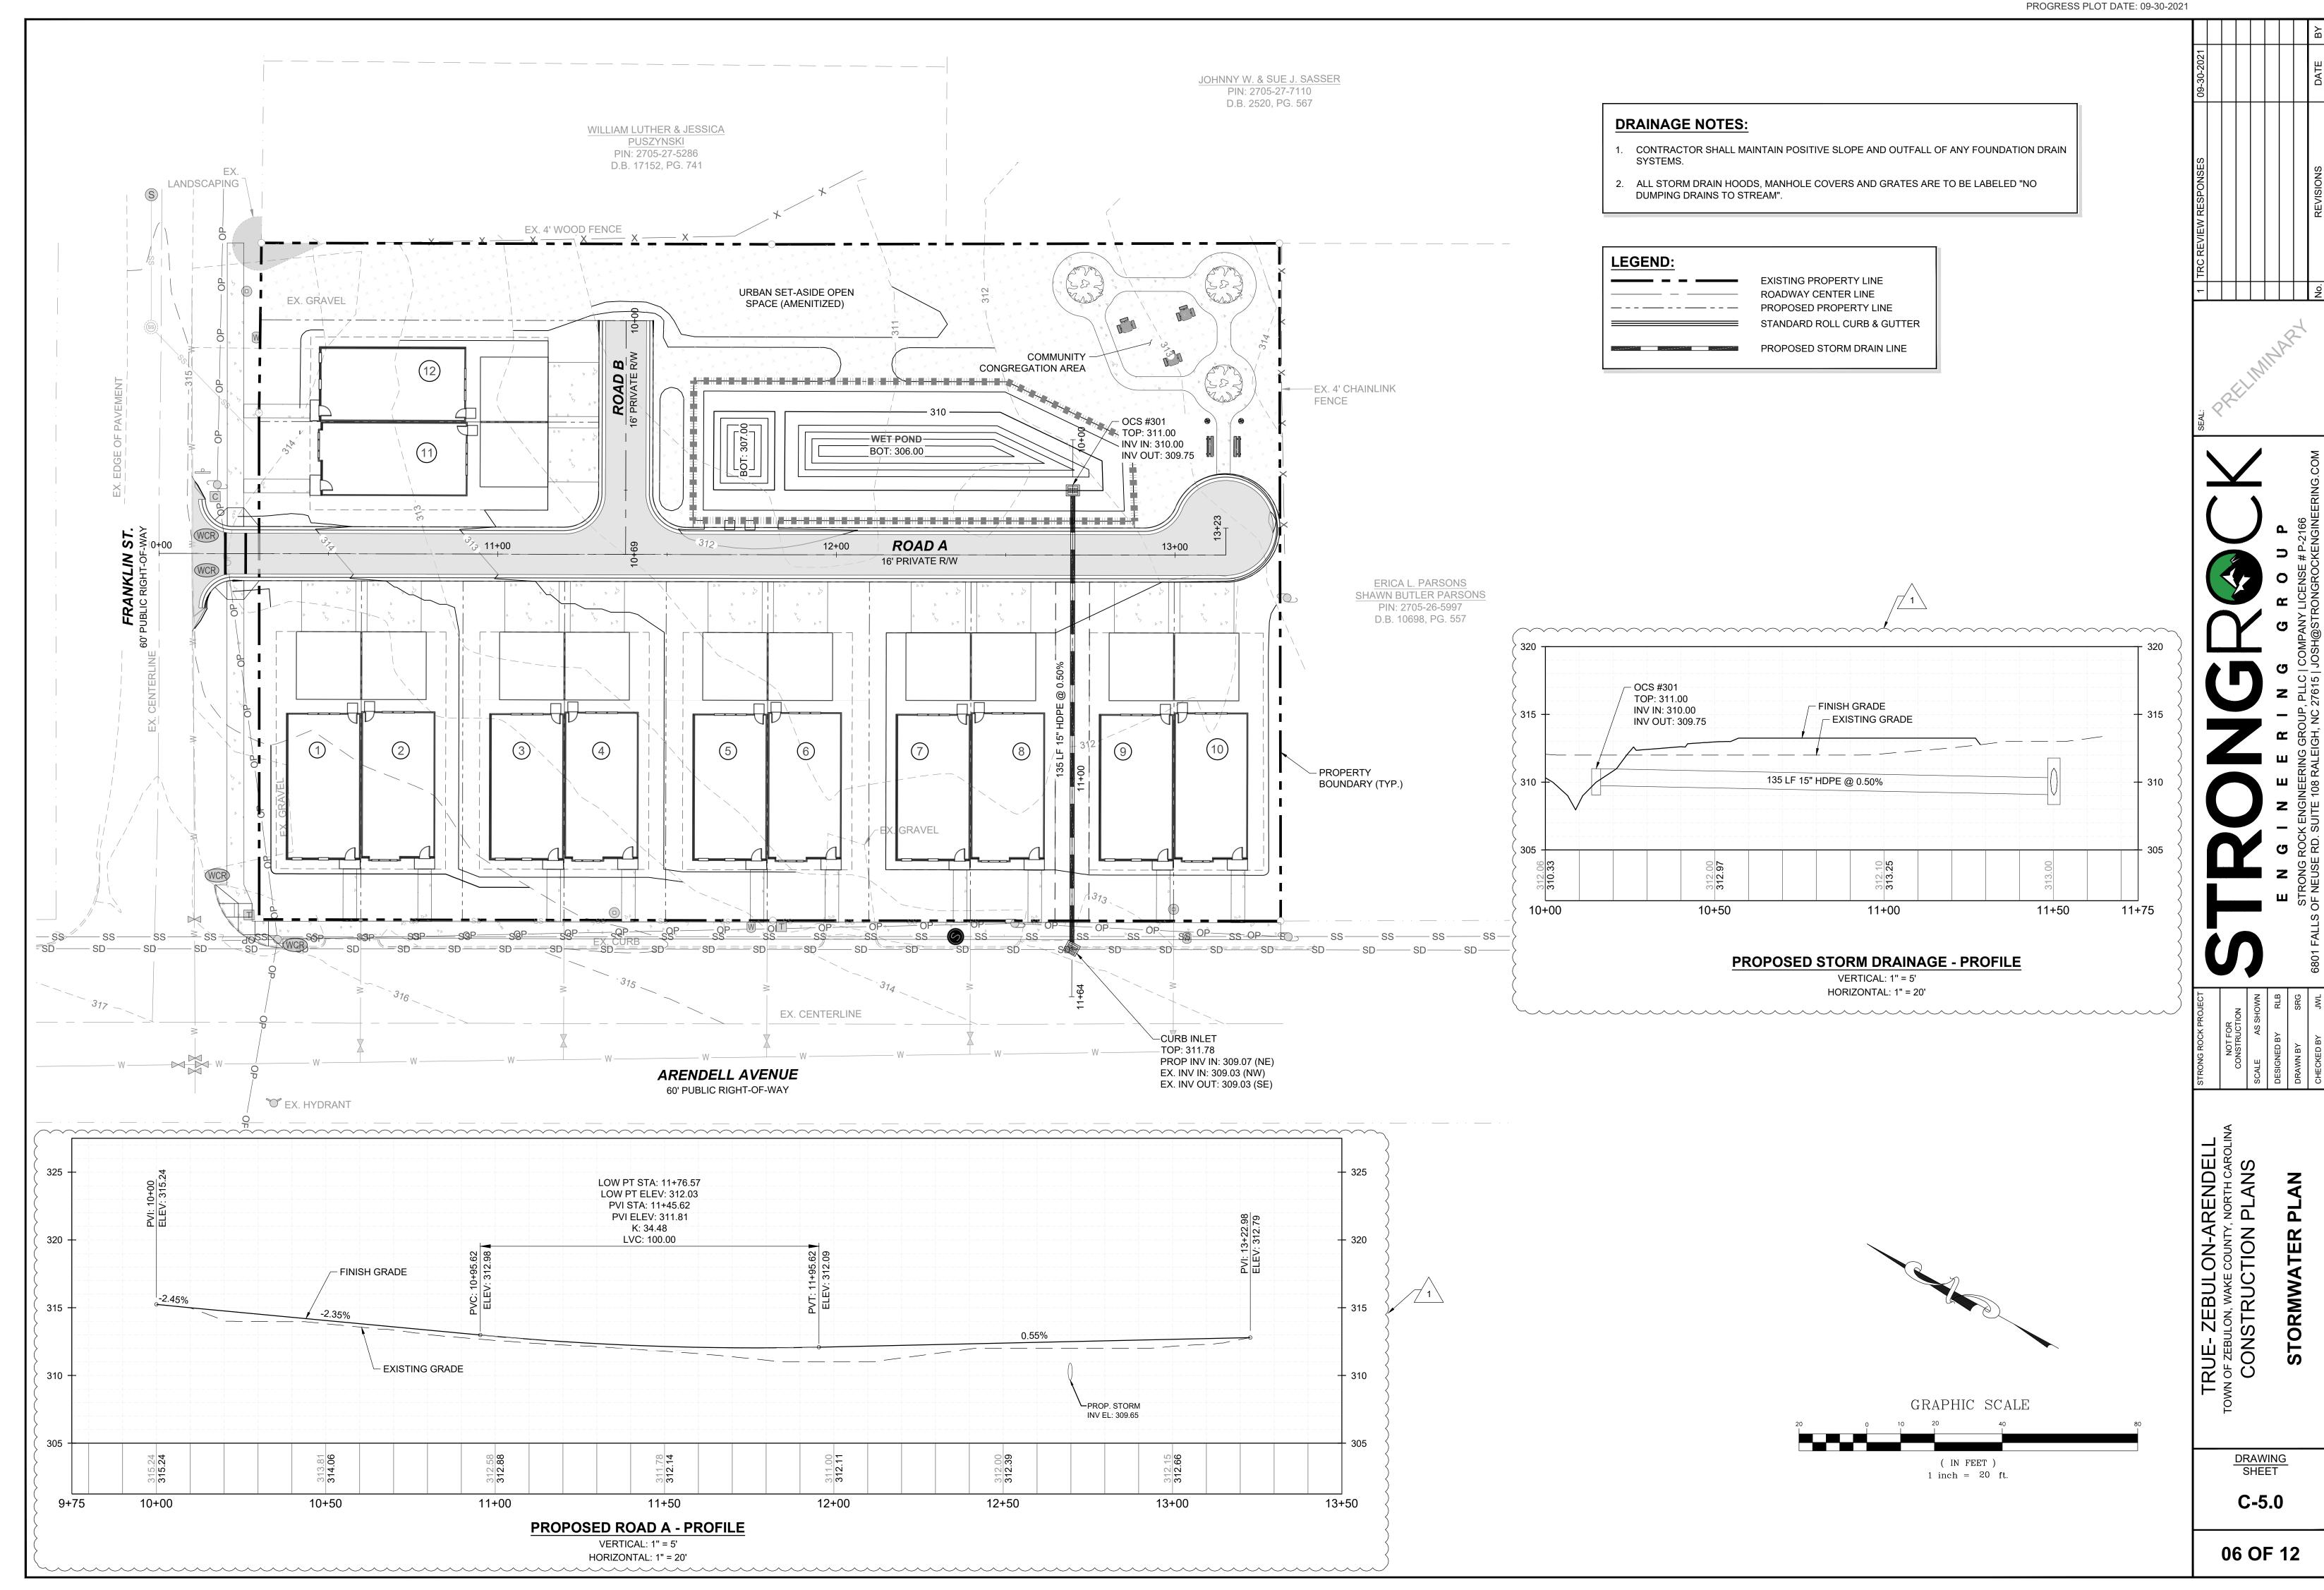

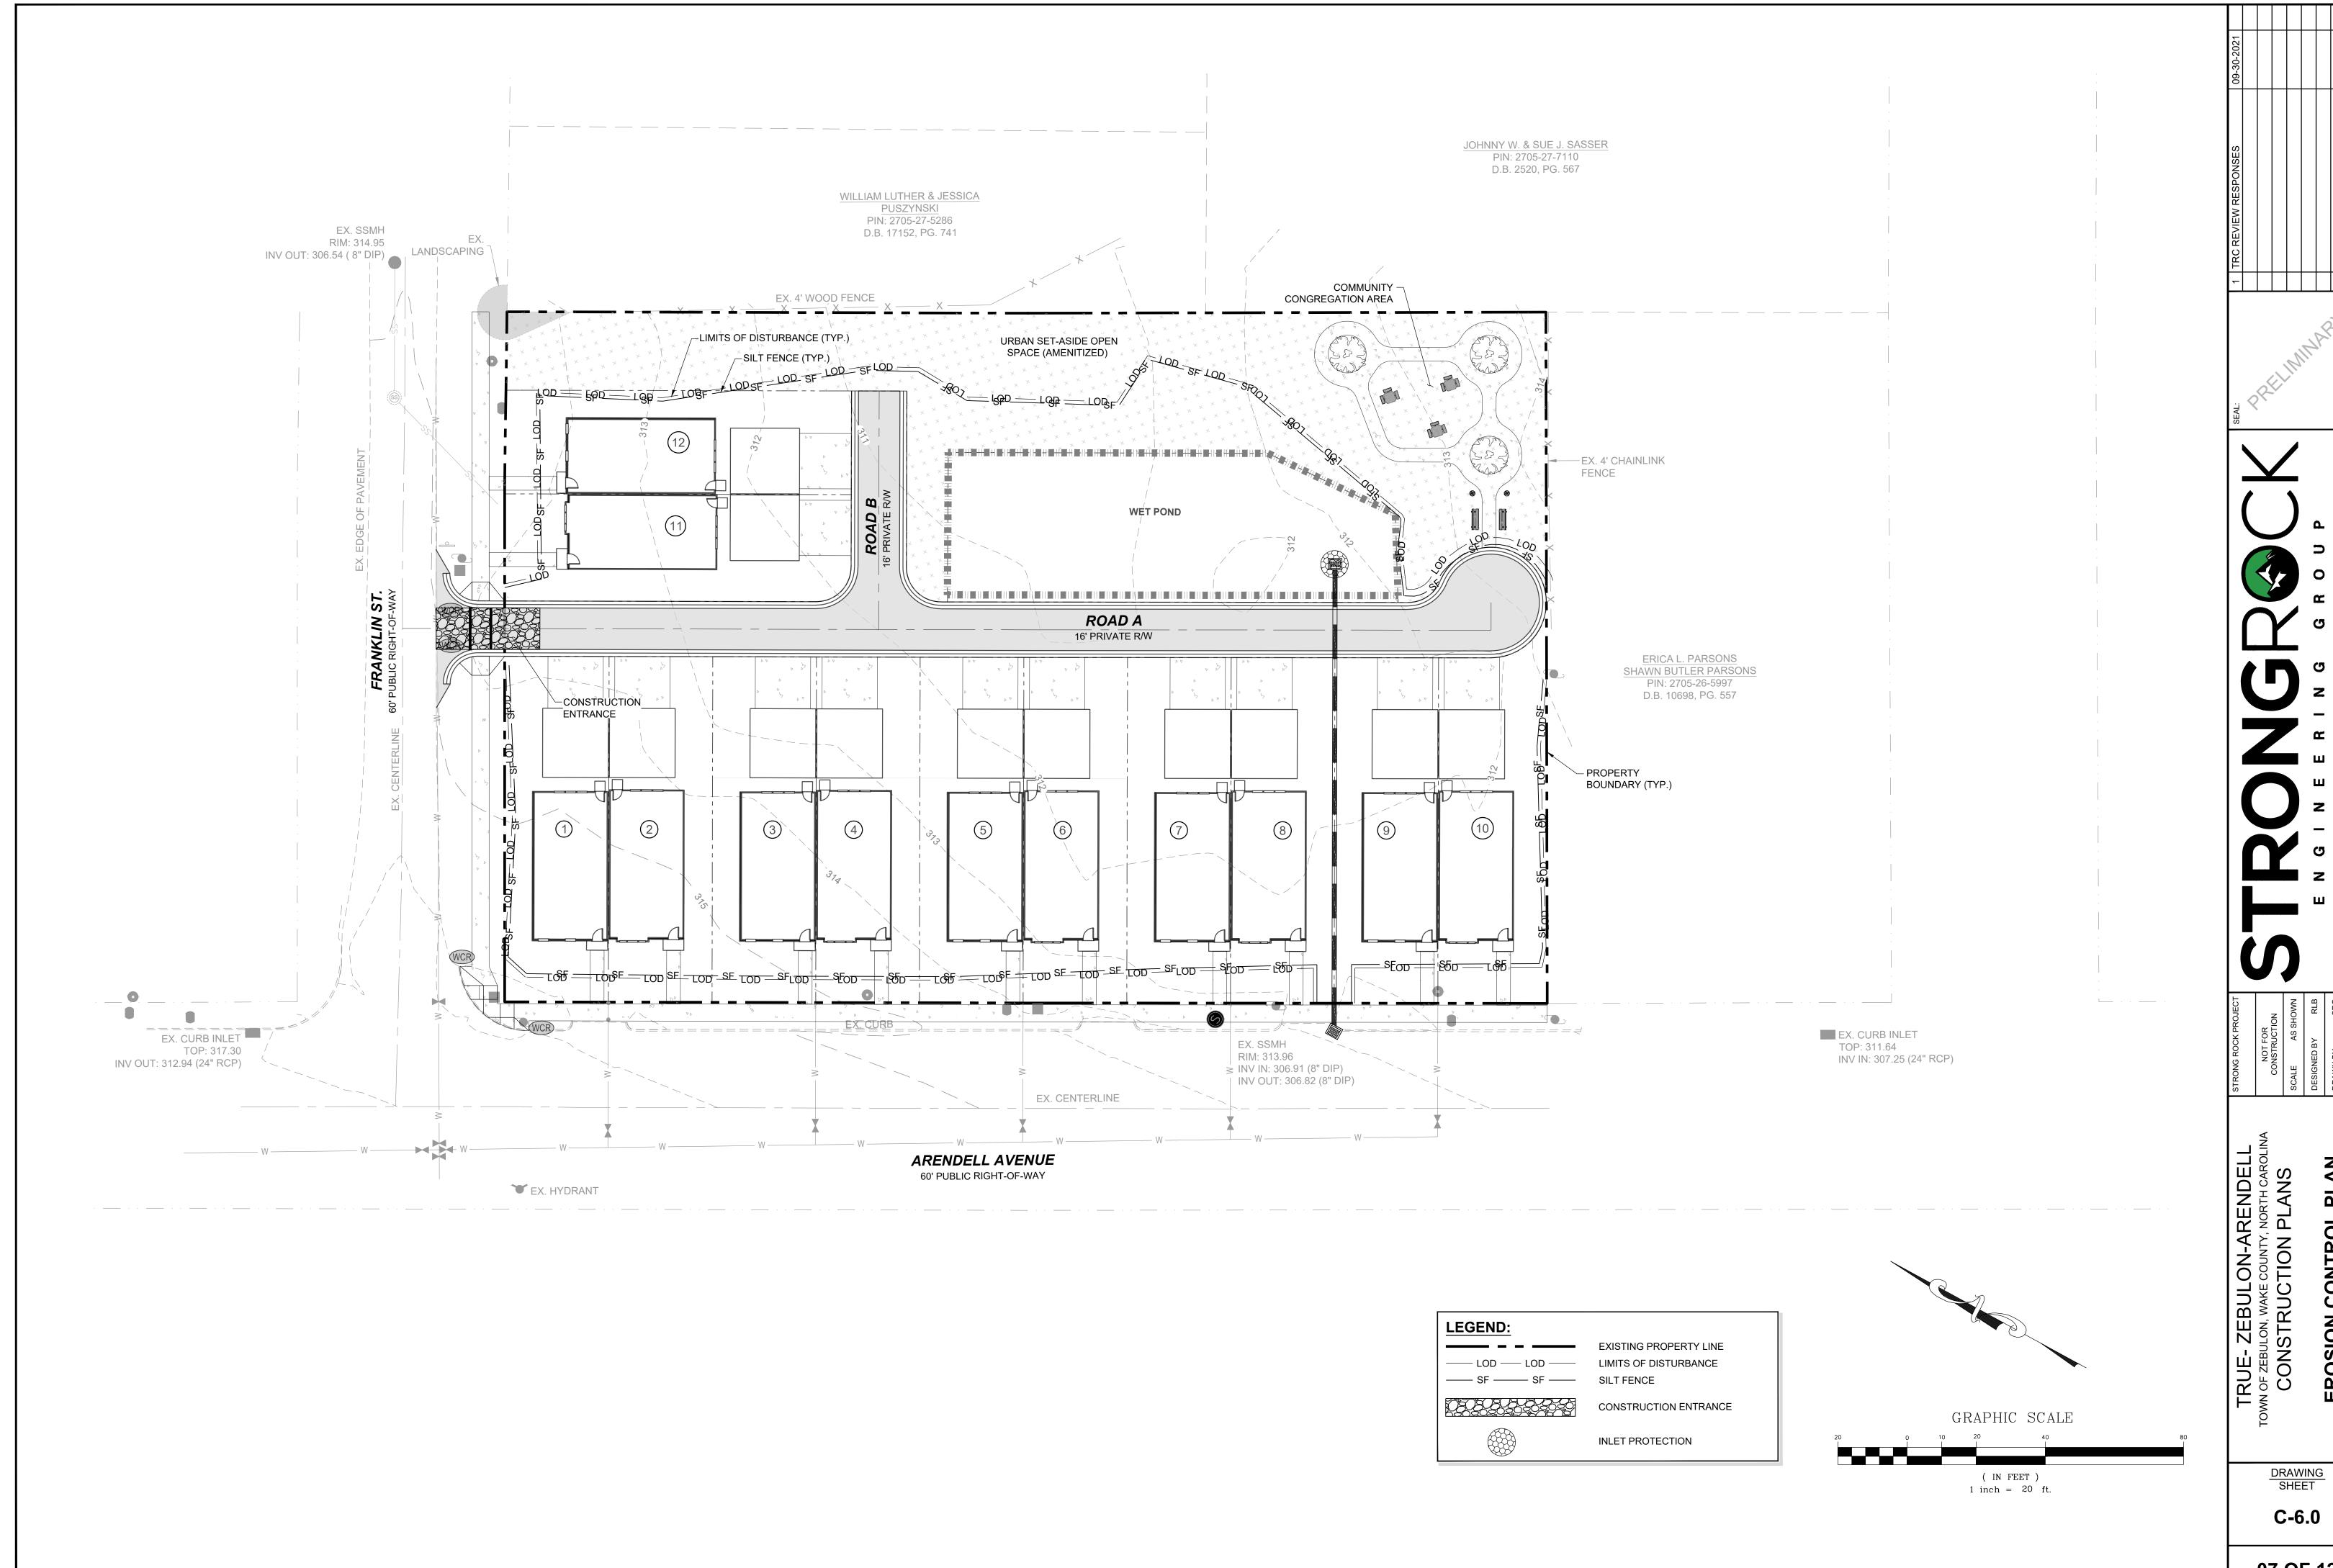

EROSION

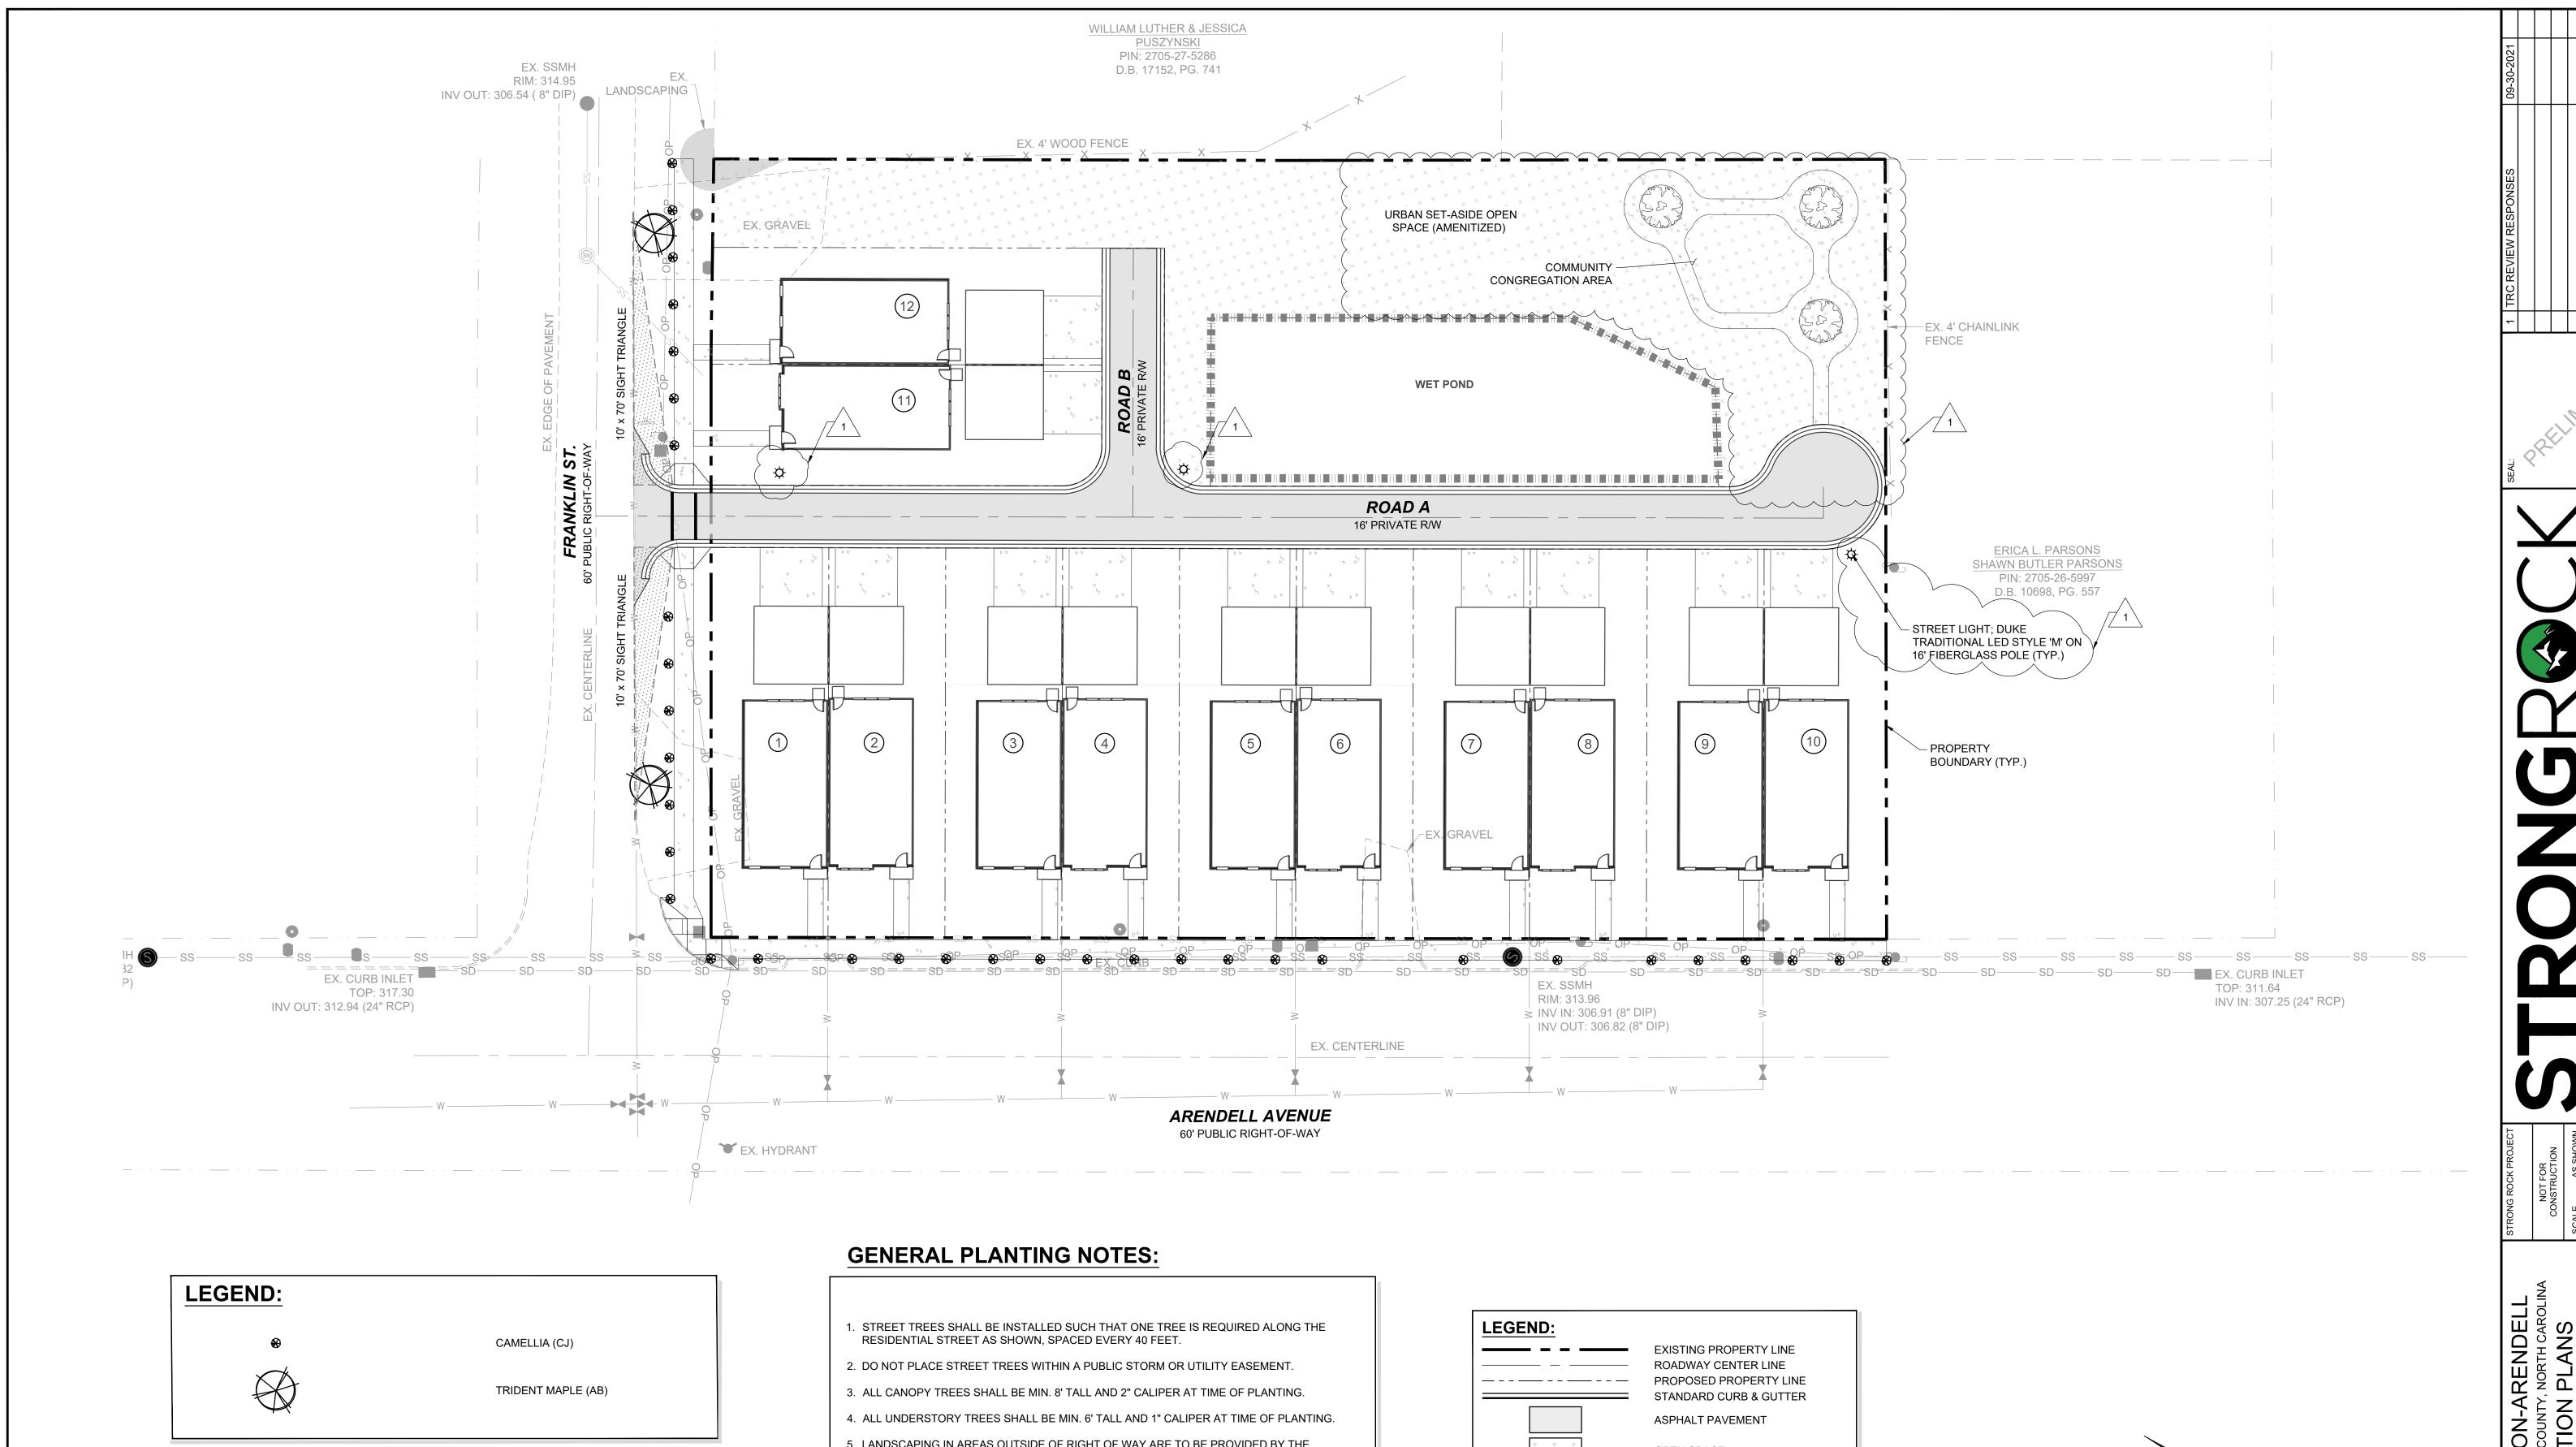

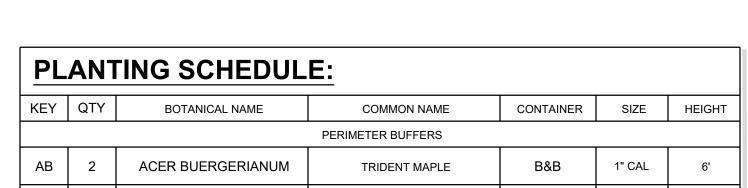

CAMELLIA

3 GAL


18"

CJ

CAMELLIA JAPONICA

- 5. LANDSCAPING IN AREAS OUTSIDE OF RIGHT OF WAY ARE TO BE PROVIDED BY THE DEVELOPER. ANY LANDSCAPING INSTALLED WITHIN THESE AREAS ARE TO BE MAINTAINED BY THE DEVELOPER UNTIL HOME OWNERS ASSOCIATION (HOA) IS ESTABLISHED. HOA WILL BE RESPONSIBLE FOR CONTINUED MAINTENANCE OF LANDSCAPING AND ANY IMPROVEMENTS OUTSIDE THE RIGHT OF WAY.
- 6. ADDITIONAL LANDSCAPING ON SITE MAYBE PROVIDED BY DEVELOPER.


LEGEND:	
	EXISTING PROPERTY LINE ROADWAY CENTER LINE PROPOSED PROPERTY LINE
	STANDARD CURB & GUTTER ASPHALT PAVEMENT
+ + +	OPEN SPACE STREET LIGHT

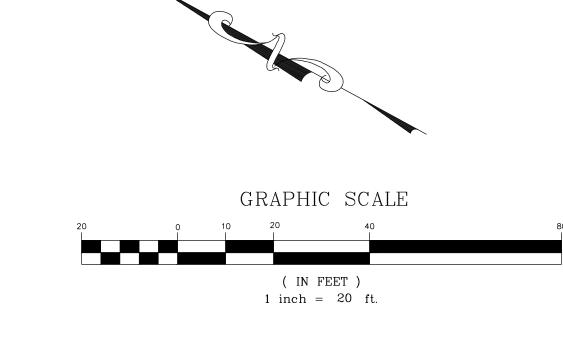

LANDSCAPING

DRAWING SHEET



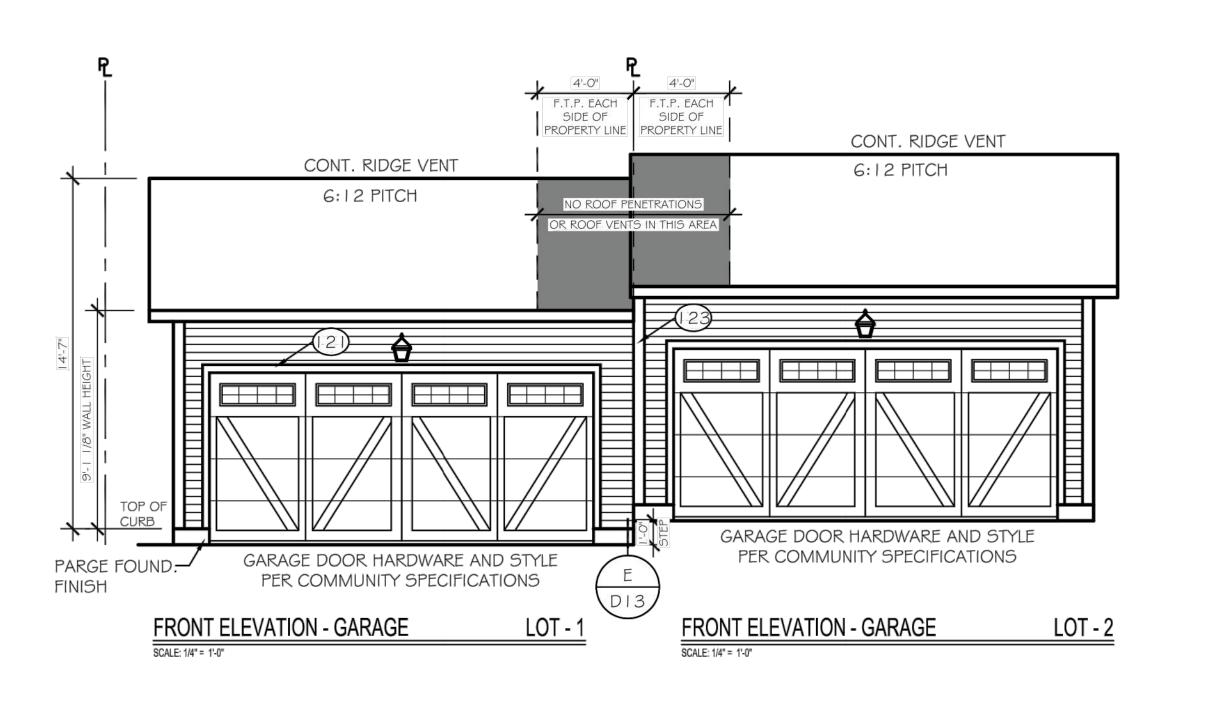

STRONG ROCK ENGINEERING GROUP, PLLC | COMPANY LICENSE # P-2166


6801 FALLS OF NEUSE RD. SUITE 108 RALEIGH, NC 27615 | JOSH@STRONGROCKENGINEERING.COM


ANS
SCALE AS SHOWN
DESIGNED BY RLB
DRAWN BY SRG


TRUE- ZEBULON-ARENDELL
WN OF ZEBULON, WAKE COUNTY, NORTH CAROLIN
CONSTRUCTION PLANS
BUILDING ELEVATIONS


DRAWING SHEET


D-1.0

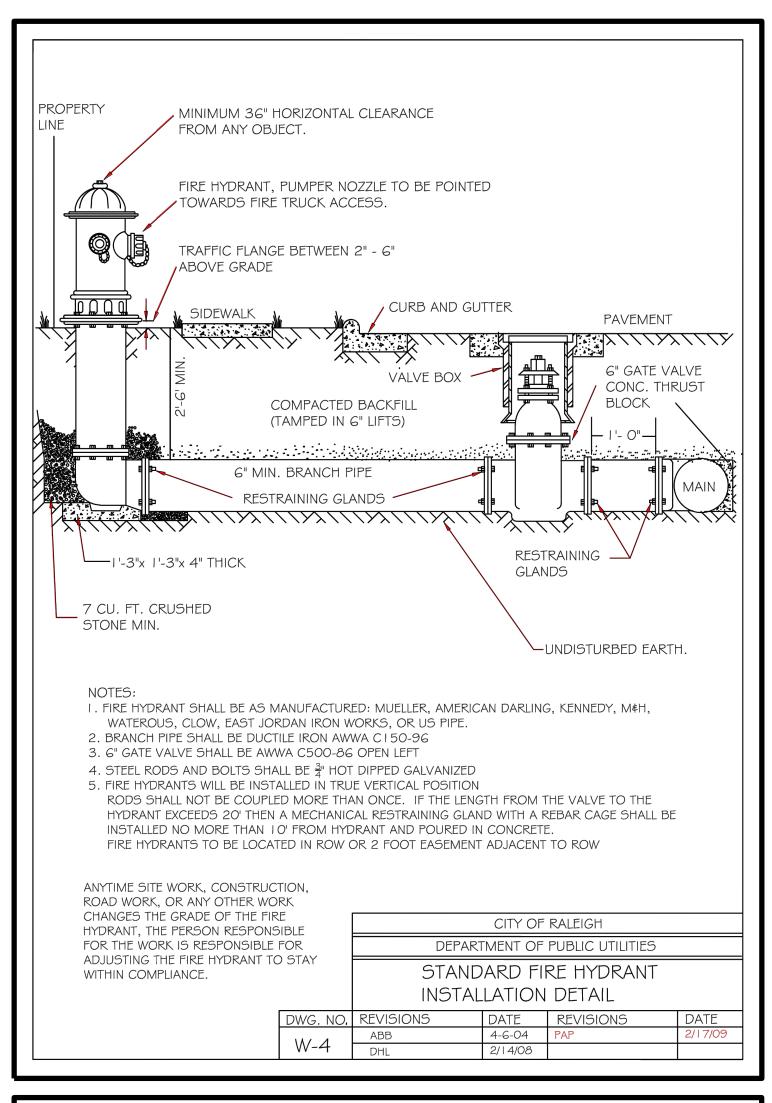


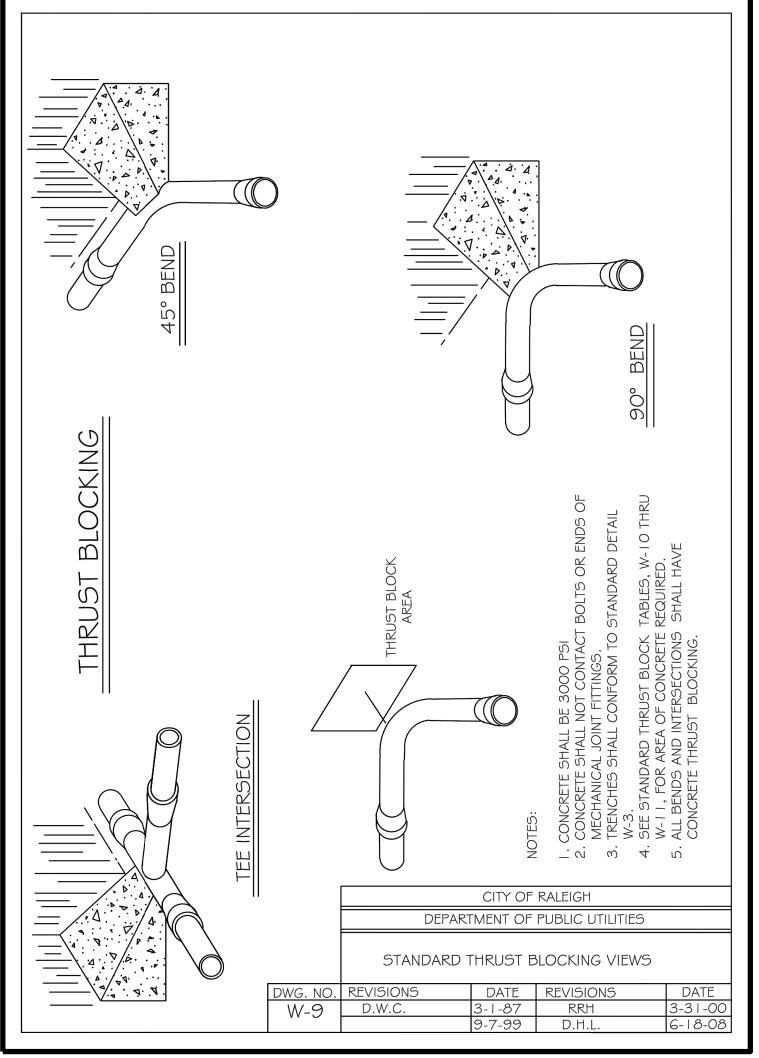

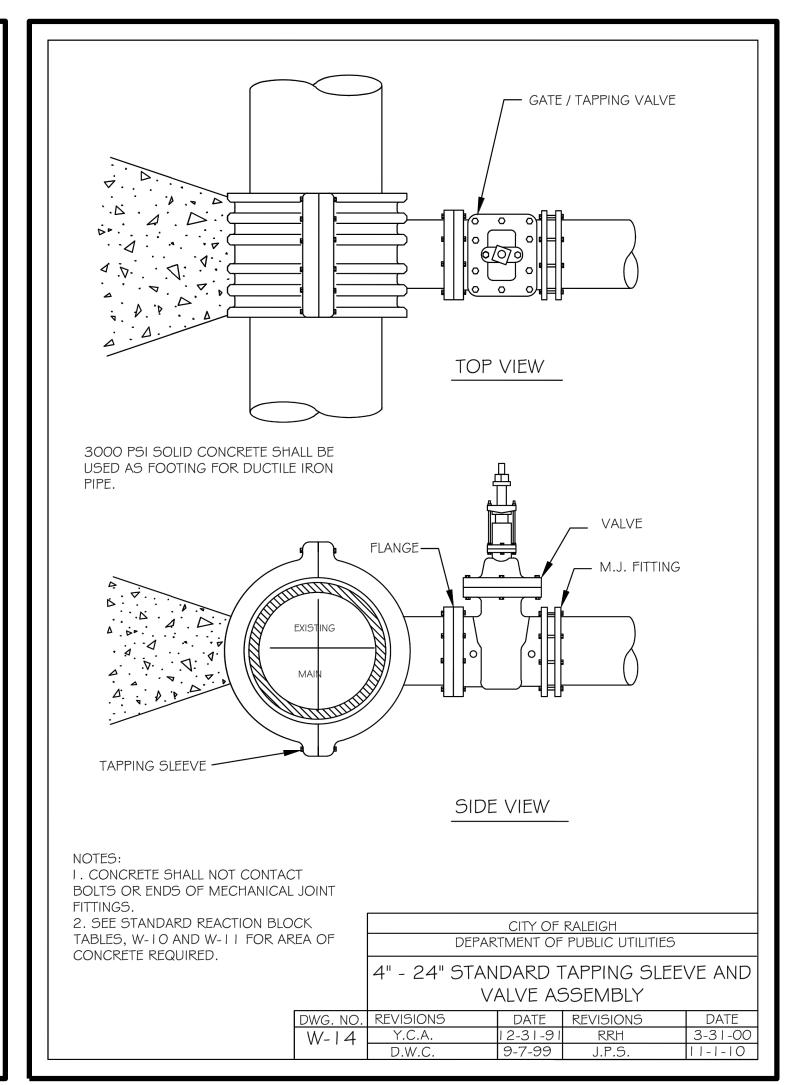

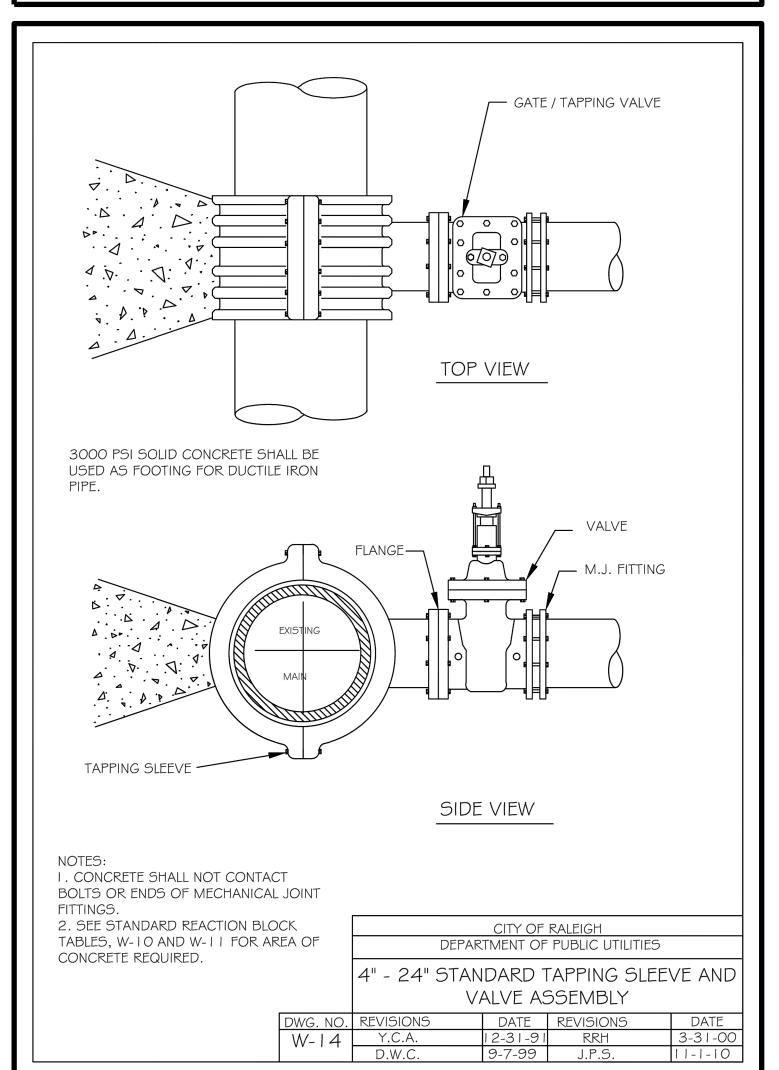

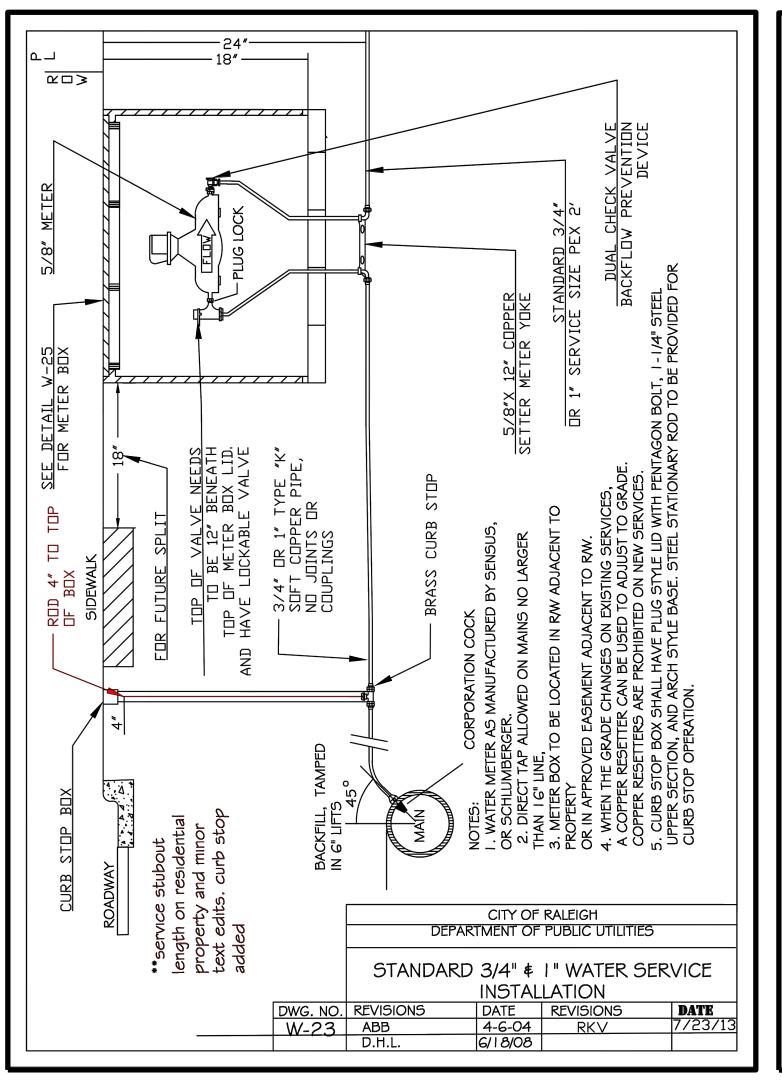

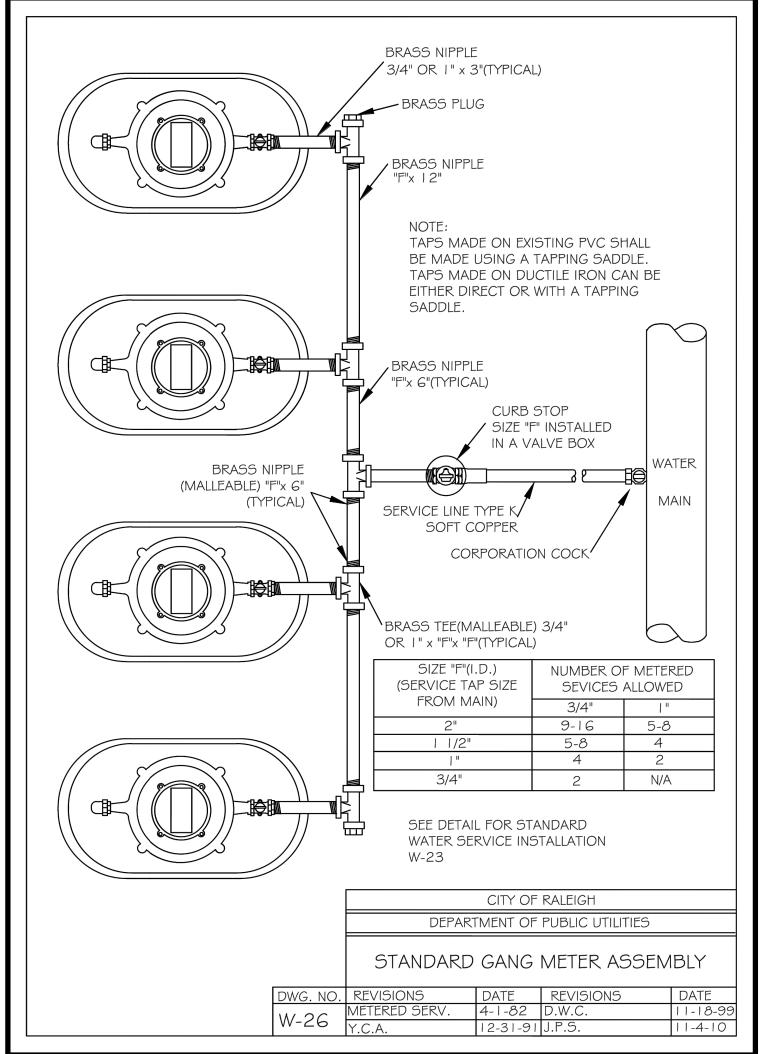

CITY OF ZEBULON - PLANS AUTHORIZED FOR

CONSTRUCTION:

ELECTRONIC APPROVAL: THIS

ELECTRONIC APPROVAL: THIS APPROVAL IS BEING ISSUED ELECTRONICALLY. THIS APPROVAL IS VALID ONLY UPON THE SIGNATURE OF A CITY OF ZEBULON REVIEW OFFICER BELOW. THE CITY WILL RETAIN A COPY OF THE APPROVED PLANS. ANY WORK AUTHORIZED BY THIS APPROVAL MUST PROCEED IN ACCORDANCE WITH THE PLANS KEPT ON FILE WITH THE CITY. THIS ELECTRONIC APPROVAL MAY NOT BE EDITED ONCE ISSUED. ANY MODIFICATION TO THIS APPROVAL ONCE ISSUED WILL INVALIDATE THIS APPROVAL.

CITY OF ZEBULON DEVELOPMENT APPROVAL

ZEBULON WATER REVIEW OFFICER

No. REVISIONS DATE






CONSTRUCTION
SCALE AS SHOWN
DESIGNED BY RLB
DRAWN BY SRG


ROLINA CONSTR SCALE DESIGNED BY


UE- ZEBULON-ARENDELL
F ZEBULON, WAKE COUNTY, NORTH CAROLINA
CONSTRUCTION PLANS
WATER DETAILS


DRAWING SHEET


D-2.0

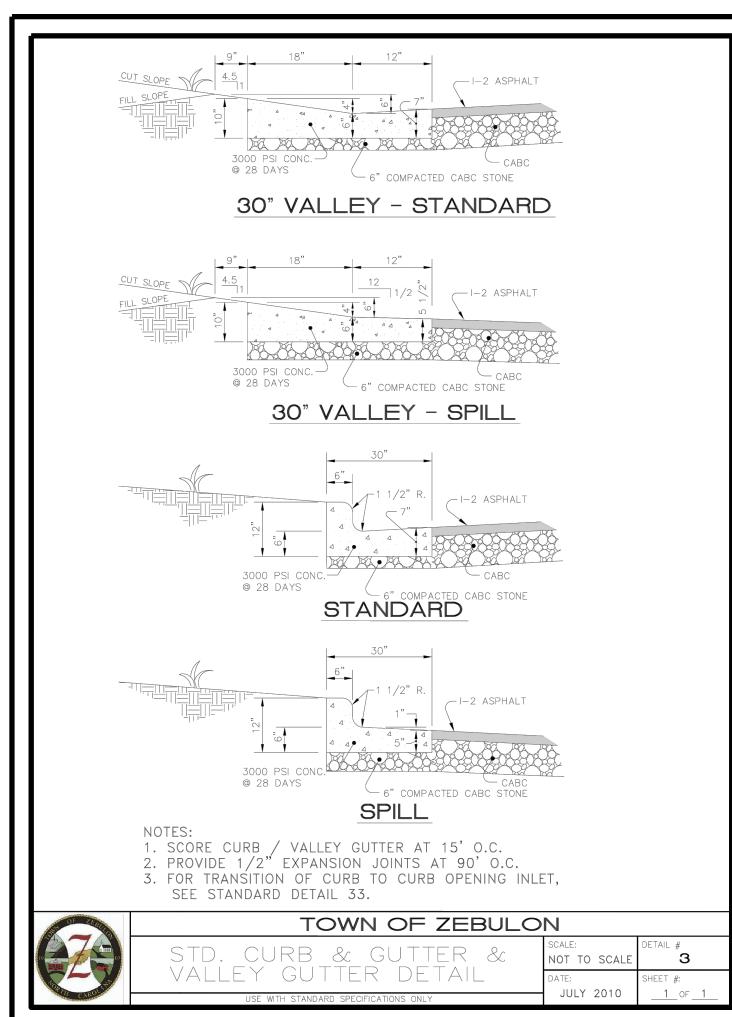


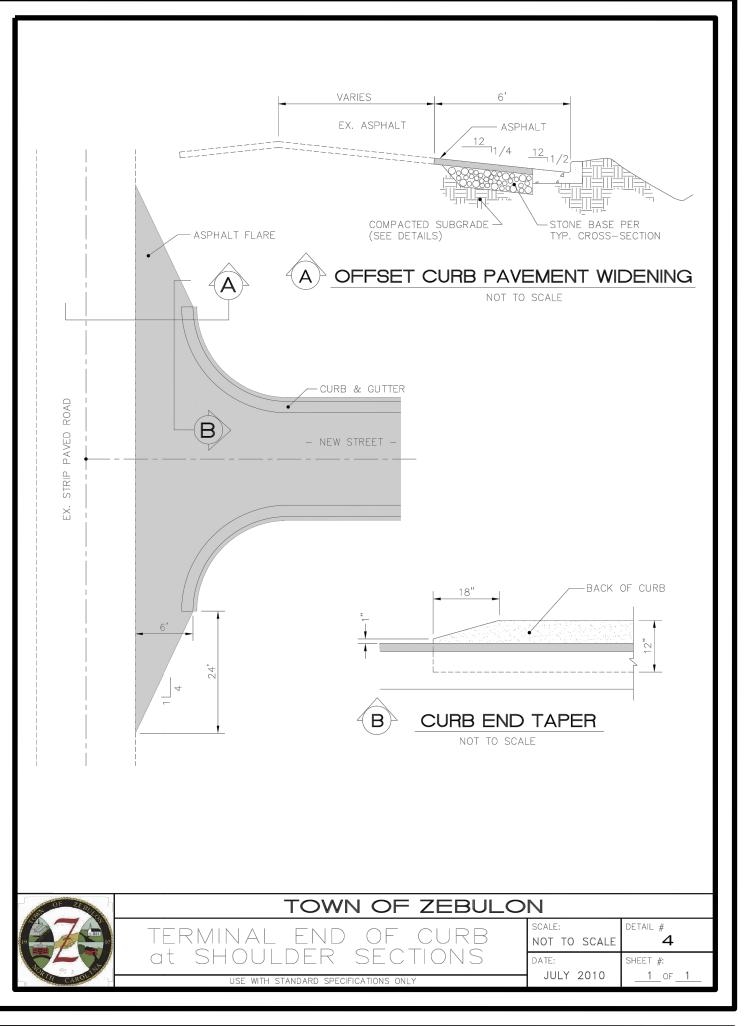


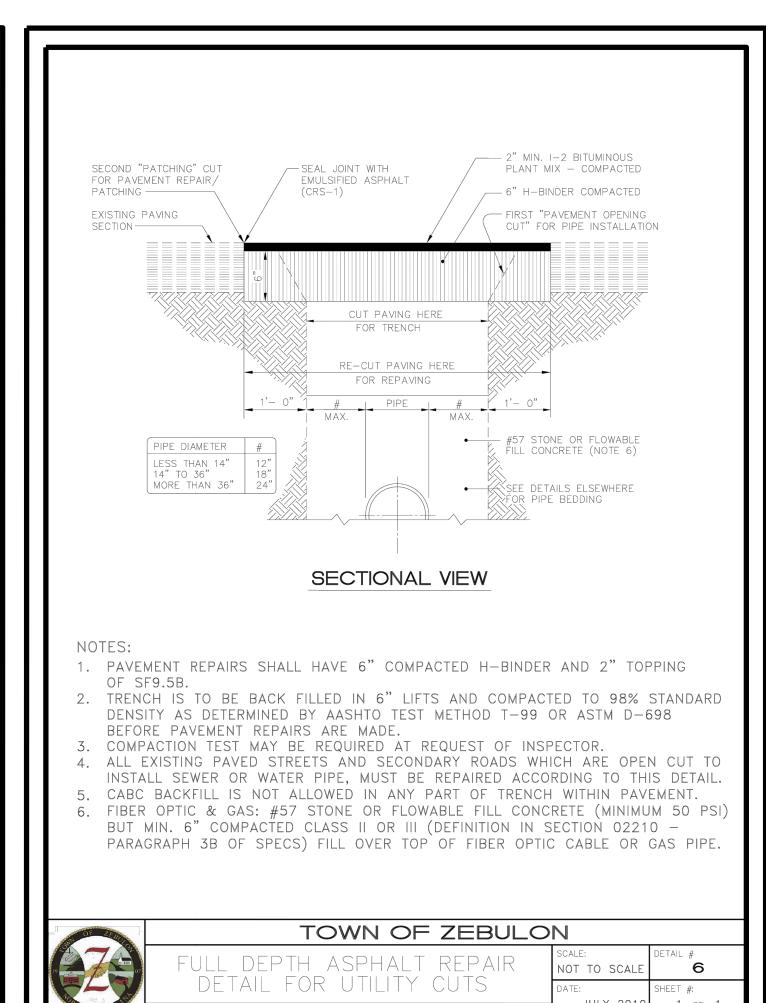


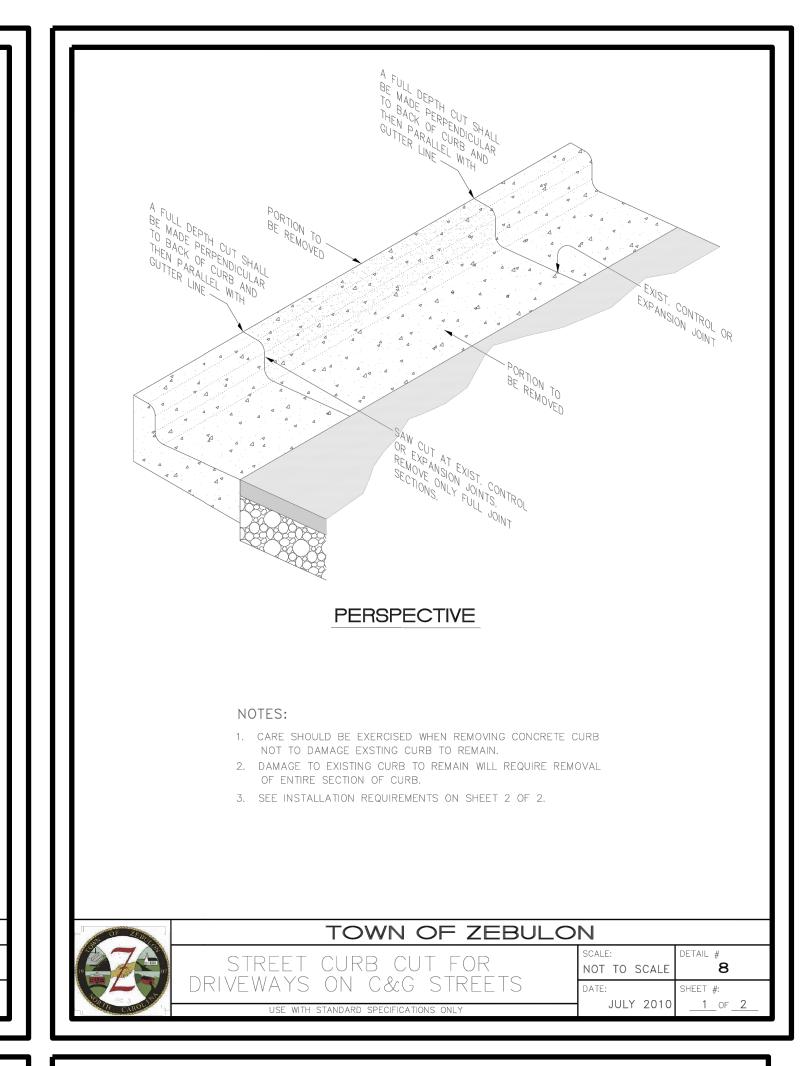

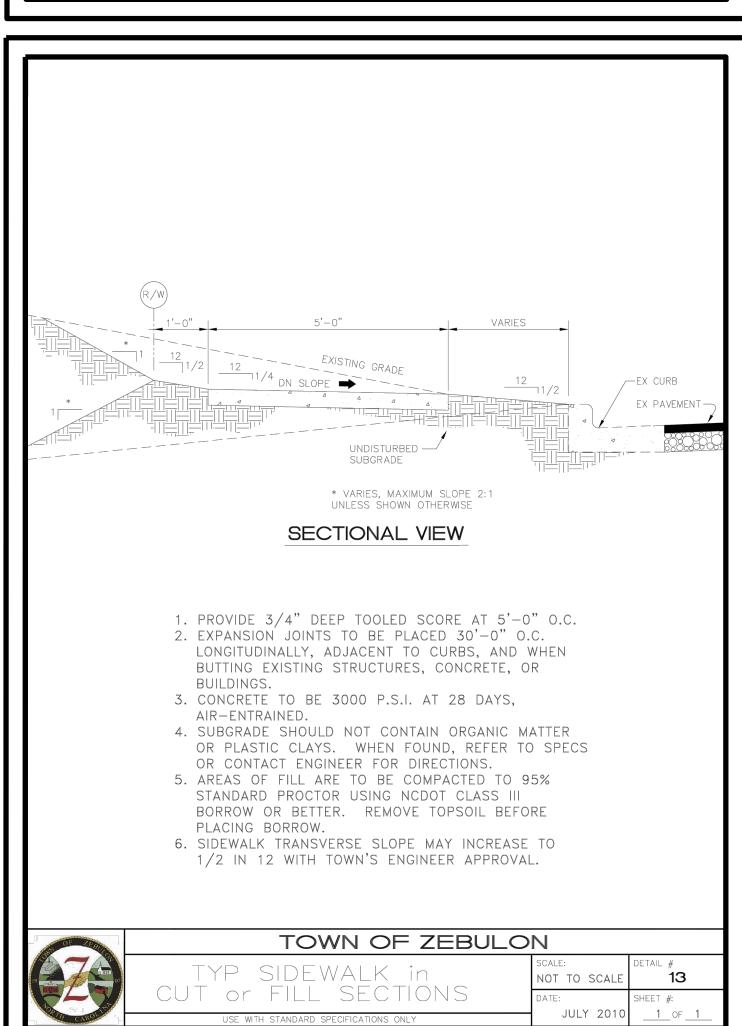

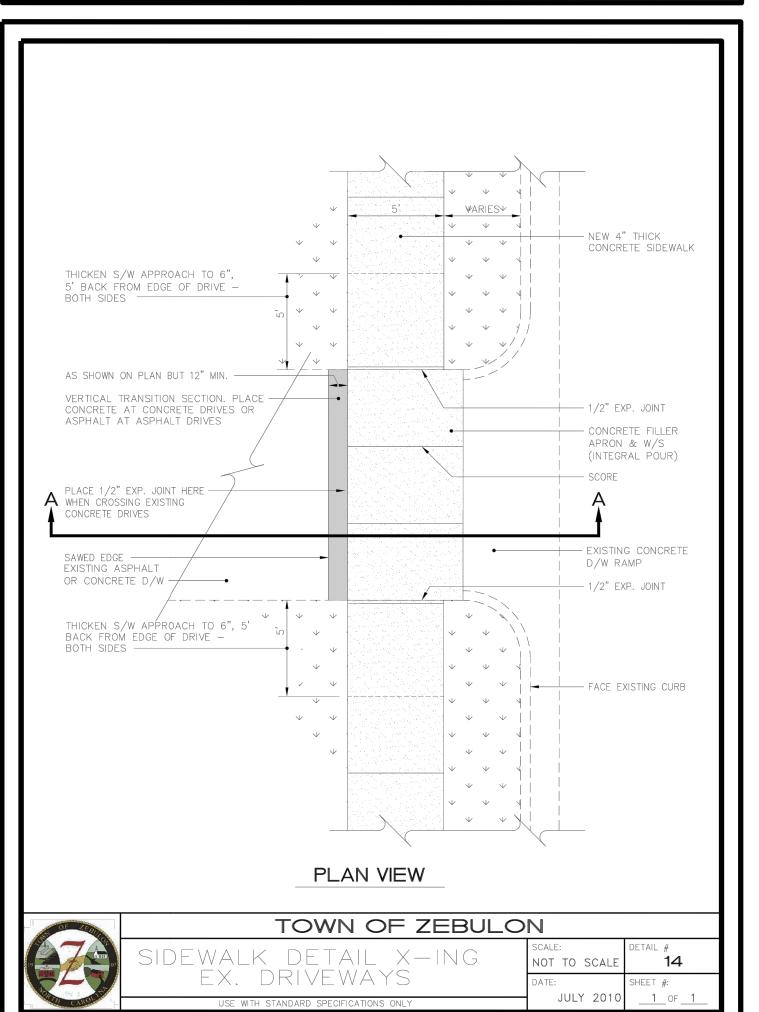

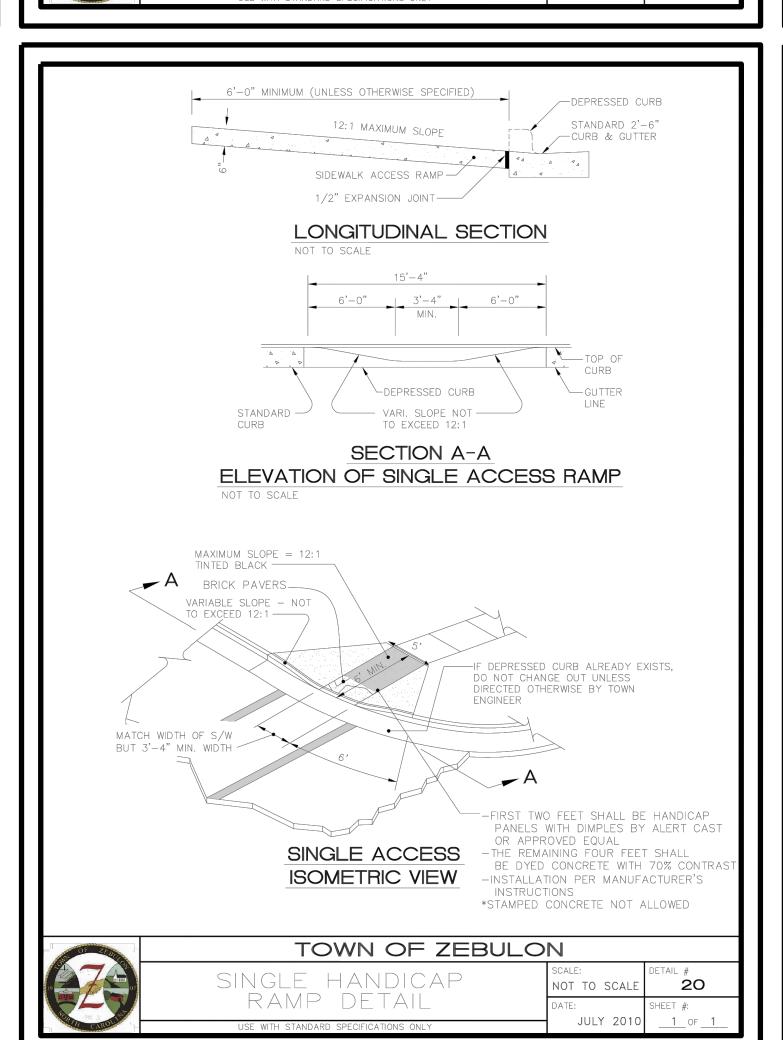

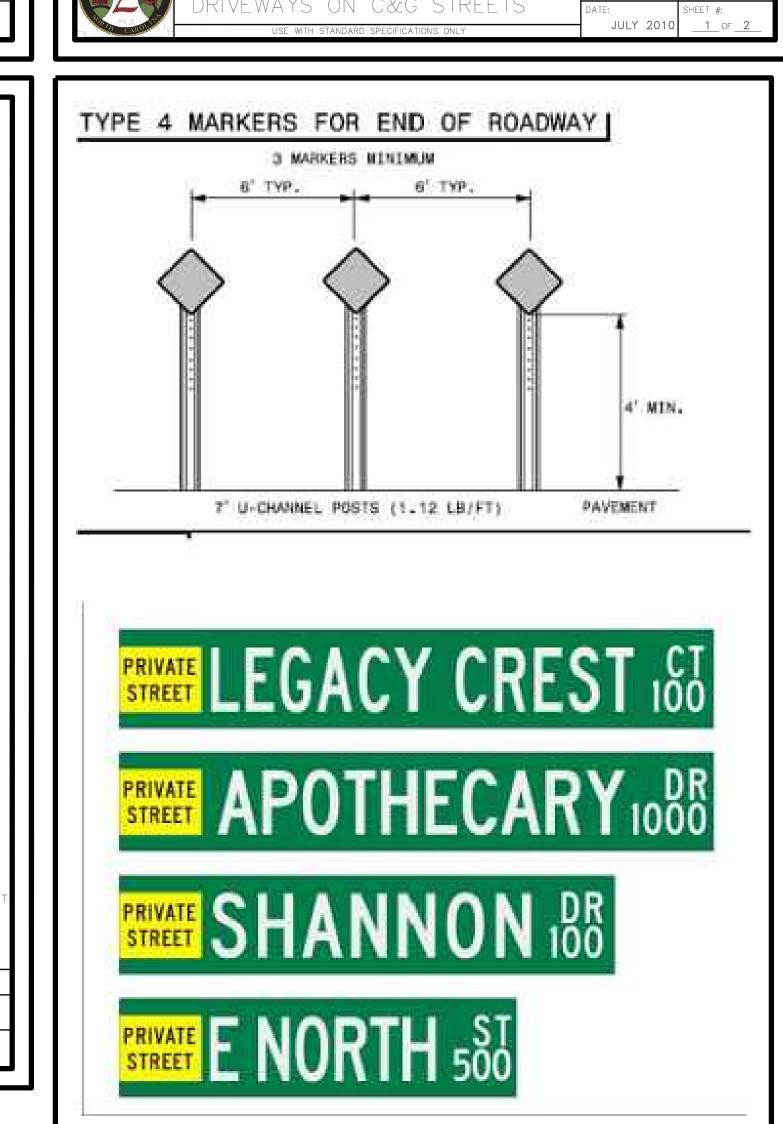






DRAWING


SHEET


D-2.1

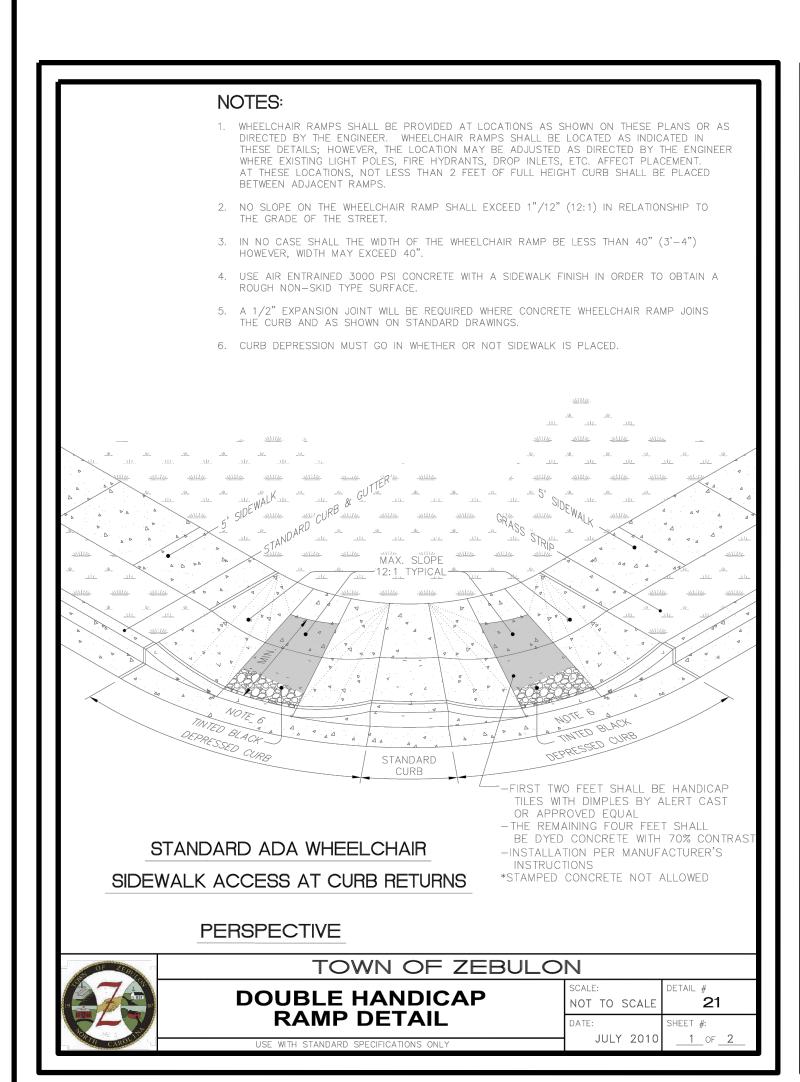


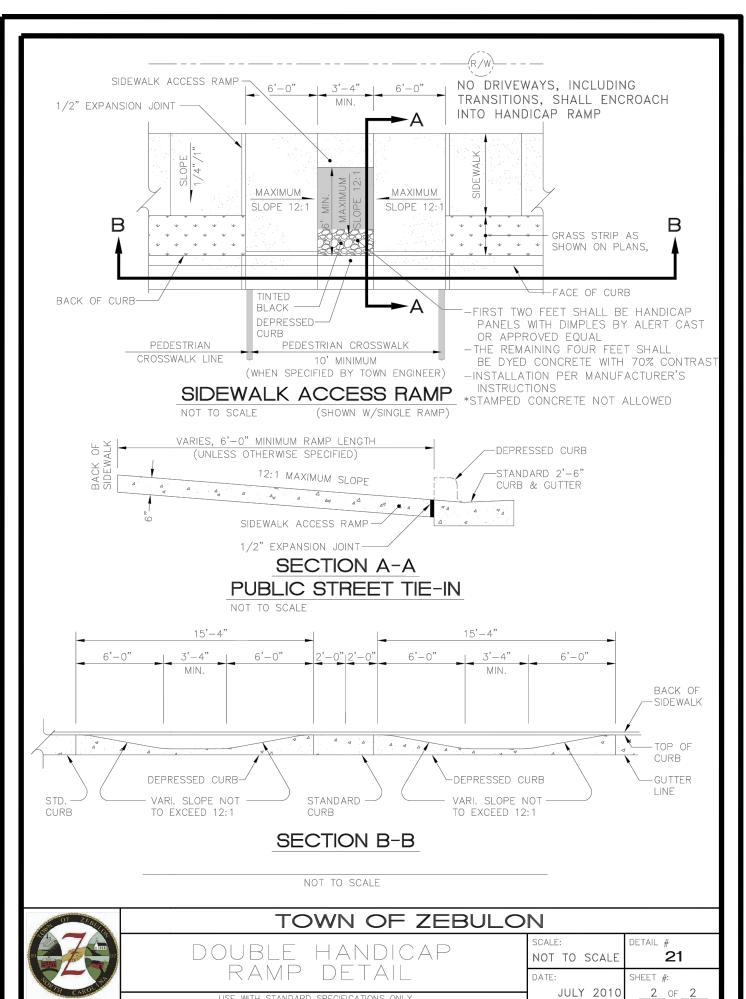


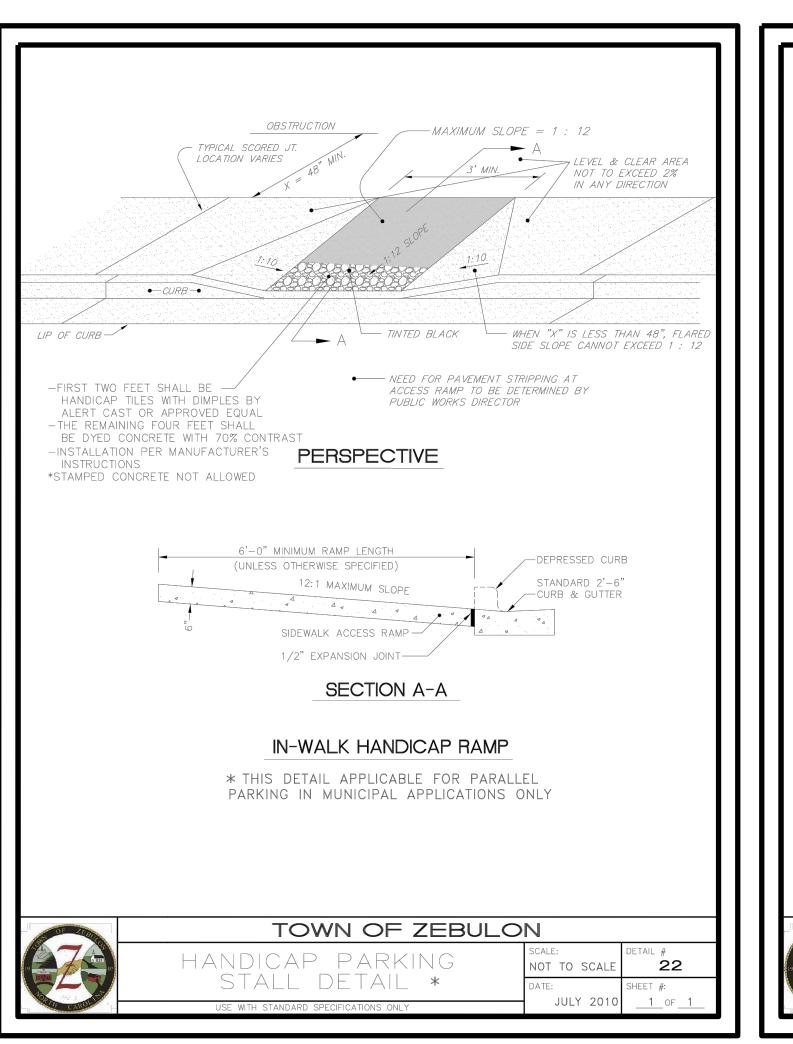

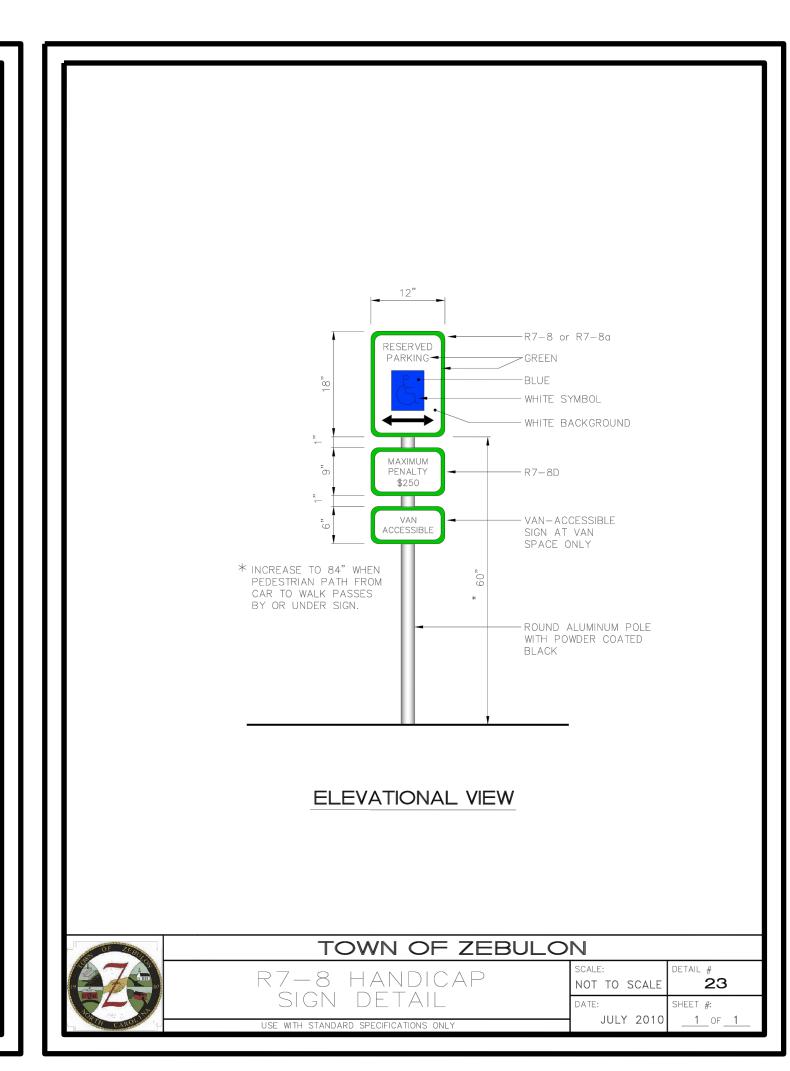

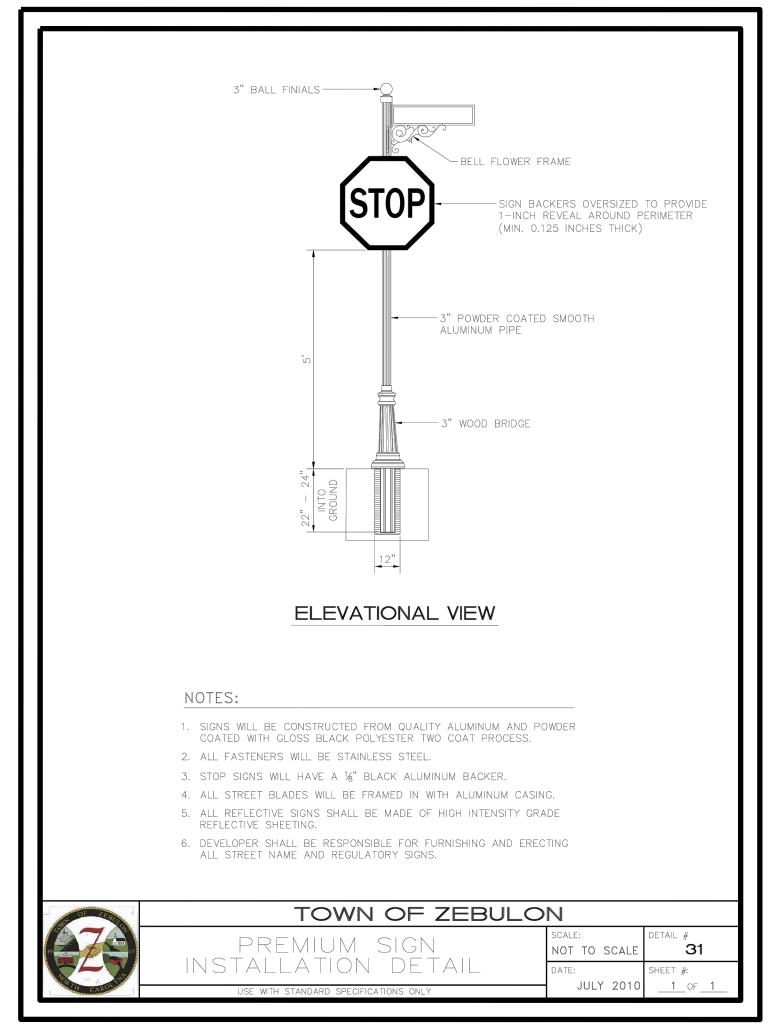

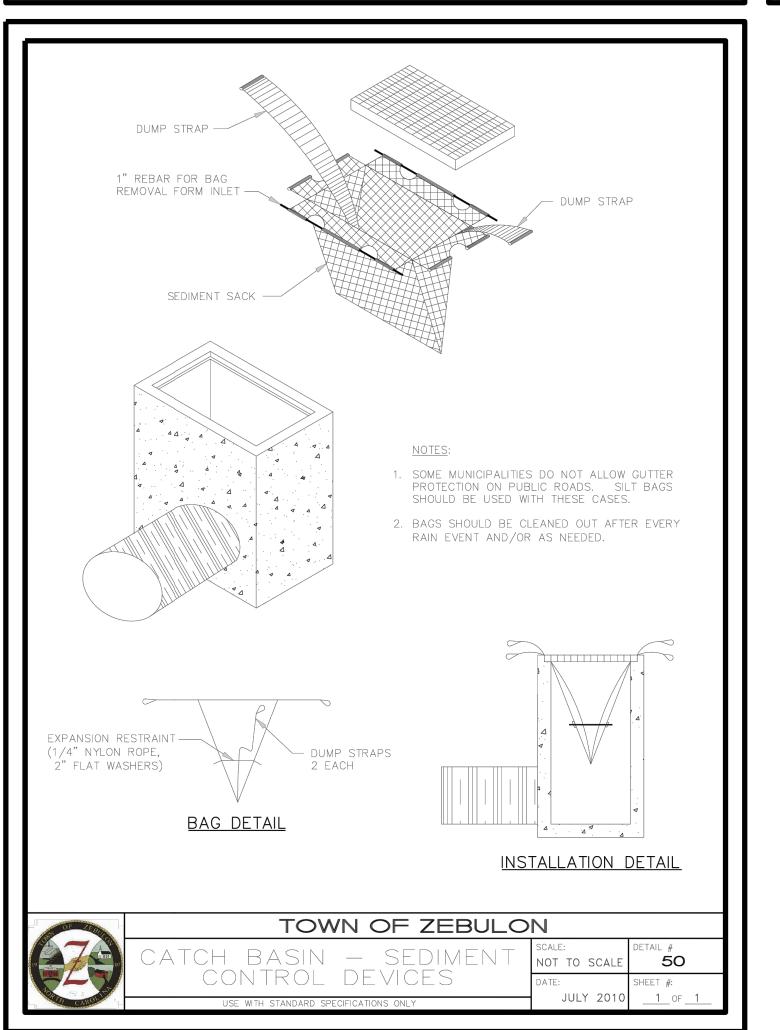

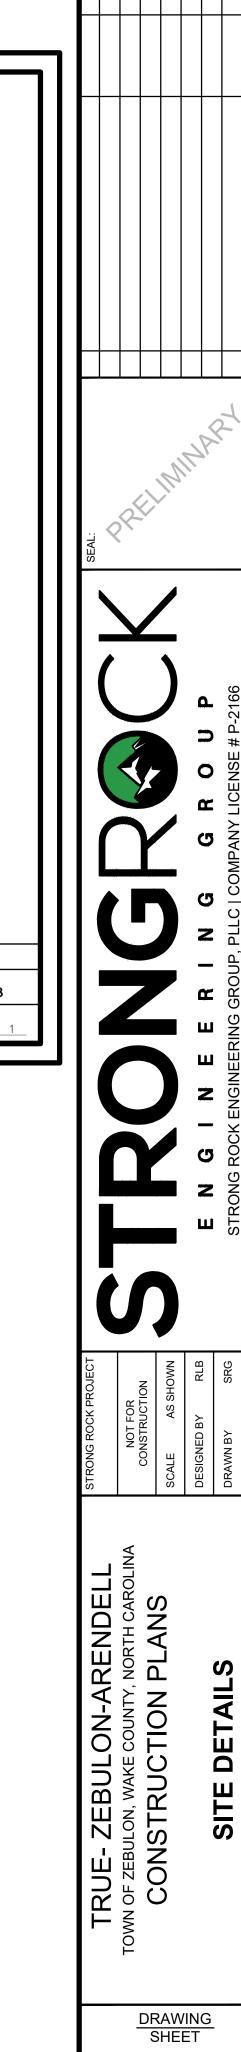

D-2.2